

## JONESBORO MUNICIPAL AIRPORT JONESBORO, ARKANSAS

# 2016 HANGAR CONSTRUCTION PHASE D

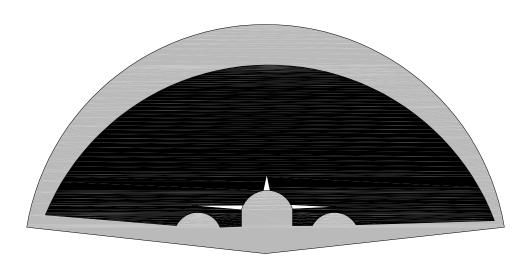

### JONESBORO MUNICIPAL AIRPORT COMMISSION

P.O. BOX 1293 - JONESBORO, AR 72403 - 870-935-8669

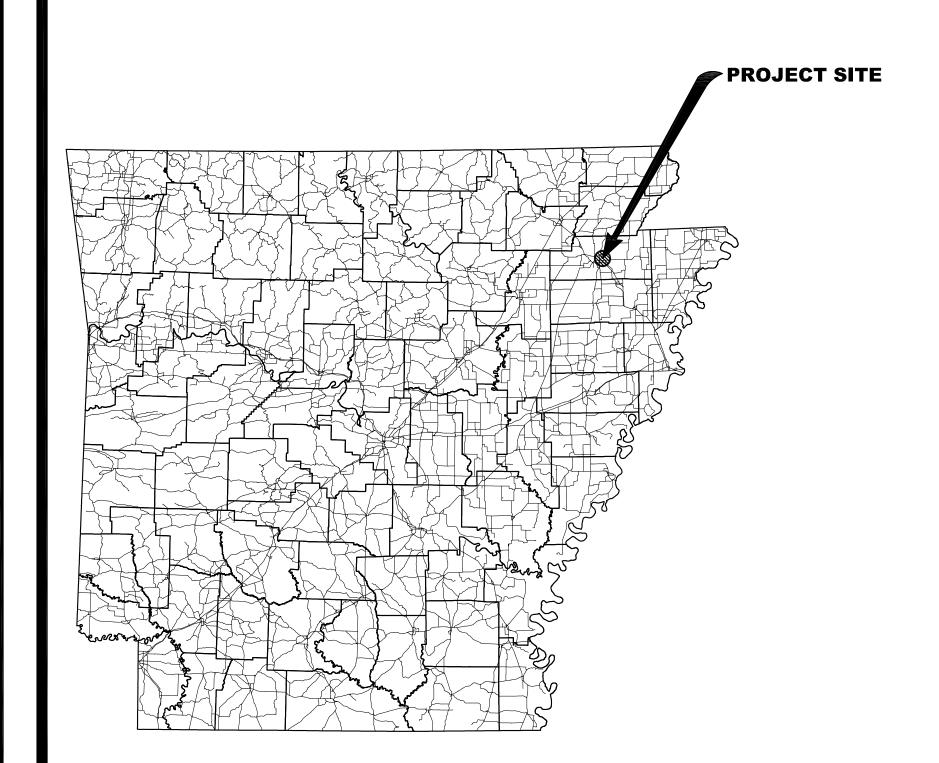

NOVEMBER, 2016

**ENGINEERING SERVICES PROVIDED BY:** 




1400 W. Markham St., Suite 204 Little Rock, AR 72201 501-907-6223

| INDEX OF DRAWINGS                         |    |                                       |
|---|----|---------------------------------------|
| Drawing No. Sheet No. Drawing Description |    | Drawing Description                   |
|   |    | COVER SHEET                           |
| PLP-1                                     | 1  | PROJECT LAYOUT PLAN                   |
| CSP-1                                     | 2  | CONSTRUCTION SAFETY PLAN              |
| SCP-1                                     | 3  | SURVEY CONTROL PLAN AND BORING LAYOUT |
| TS-1                                      | 4  | TYPICAL SECTIONS                      |
| HLP-1                                     | 5  | HANGAR LAYOUT PLAN                    |
| HGP-1                                     | 6  | HANGAR GRADING AND DRAINAGE PLAN      |
| ULP-1                                     | 7  | HANGAR UTILITY LAYOUT PLAN            |
| PMP-1                                     | 8  | PAVEMENT MARKING PLAN                 |
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| XS-1                                      | 11 | CROSS SECTIONS                        |
| DP-1                                      | 12 | REAR ENTRY DRIVE PROFILE              |





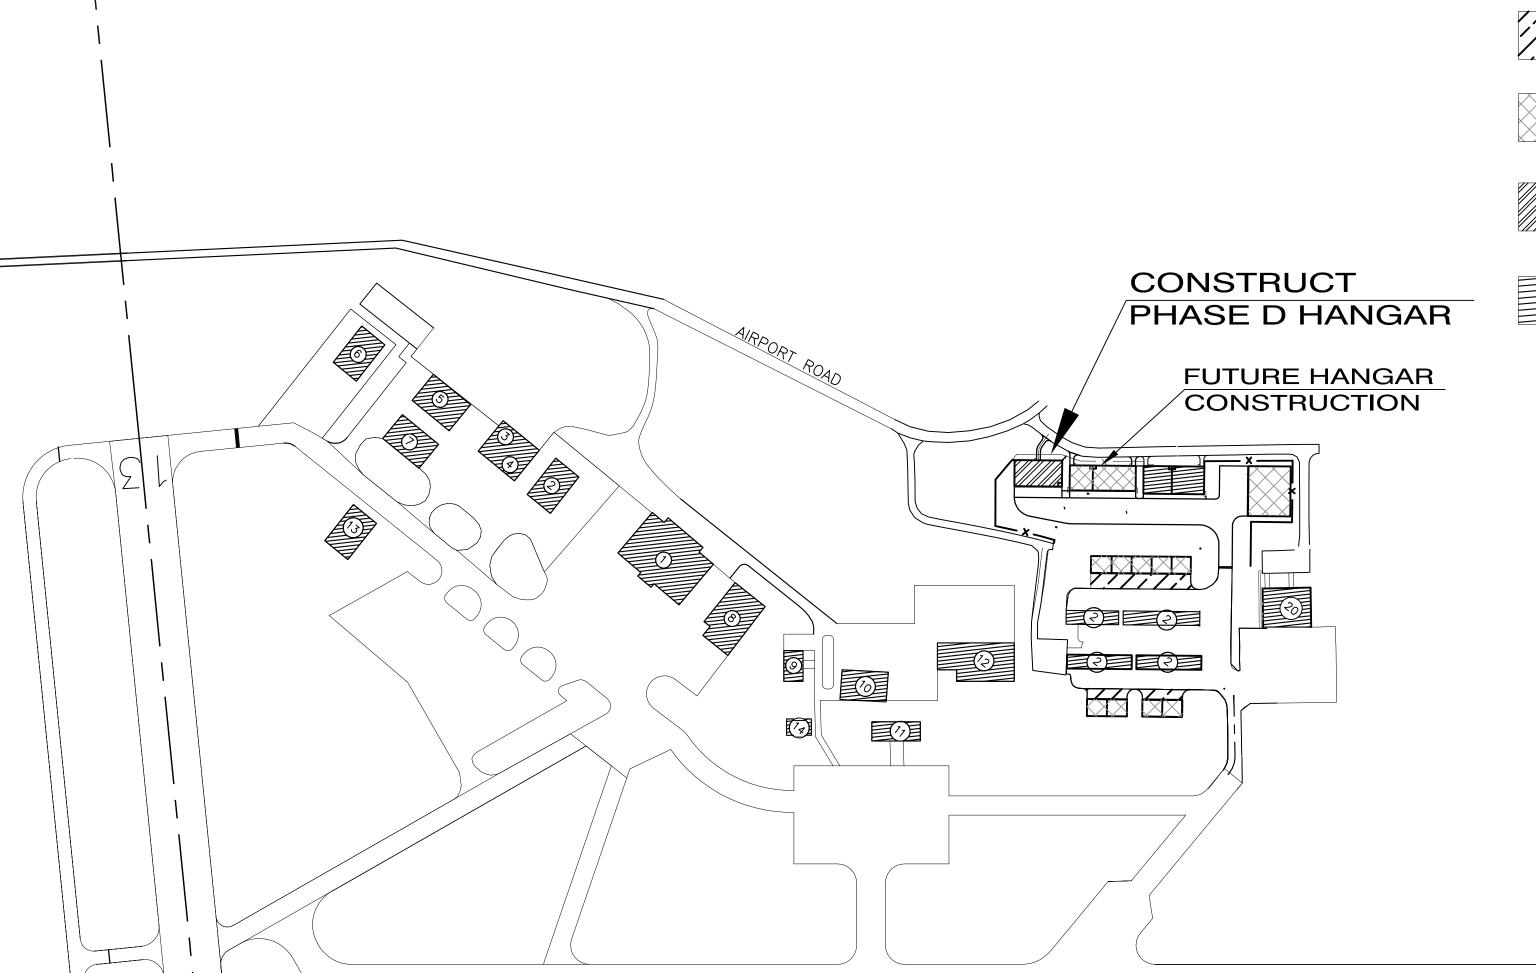

PROPOSED ASPHALT PAVEMENT (NOT IN THIS CONTRACT)


FUTURE HANGARS (NOT IN THIS CONTRACT)



CONSTRUCT HANGAR



EXISTING HANGARS

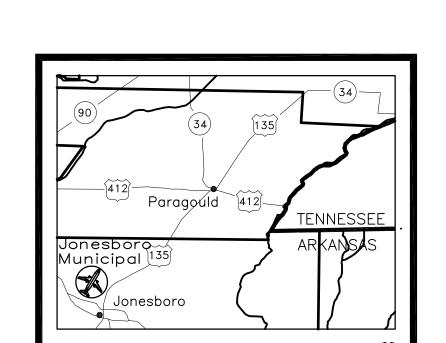

| BUILDING LEGEND |                                     |               |  |
|-----------------|-------------------------------------|---------------|--|
|                 | DESCRIPTION                         | TOP ELEVATION |  |
| 1.              | FBO TERMINAL / HANGAR               | 291.9         |  |
| 2.              | HANGAR                              | 288.9         |  |
| 3.              | HANGAR                              | 284.1         |  |
| 4.              | HANGAR                              | 284.1         |  |
| 5.              | HANGAR                              | 280.8         |  |
| 6.              | HANGAR (FOWLER)                     | 289.3         |  |
| 7.              | HANGAR                              | 279.8         |  |
| 8.              | ARKANSAS AVIATION HANGAR            | 283.1         |  |
| 9.              | ASU BUILDING                        | 278.2         |  |
| 10.             | CIVIL AIR PATROL BUILDING           | 273.6         |  |
| 11.             | TERMINAL BUILDING                   | UNKNOWN       |  |
| 12.             | FSS (FLIGHT SERVICE STATION) /      | 274.3         |  |
|                 | FAA EQUIPMENT BUILDINGS             |               |  |
| 13.             | HANGAR (LANDRY)                     | 282.0         |  |
| 14.             | VAULT BUILDING                      | 265.3         |  |
| 15.             | HANGAR (HYTROL)                     | UNKNOWN       |  |
| 20.             | SHARP AVIATION MAINTENANCE FACILITY | UNKNOWN       |  |


**Location Map** 


### JONESBORO MUNICIPAL AIRPORT

### Michael Baker

**JONESBORO, ARKANSAS** 

INTERNATIONA

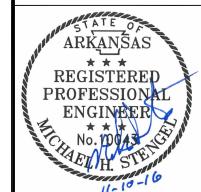

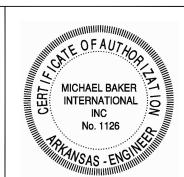

| Designer:   | Checked by:     |   |
|-------------|-----------------|---|
| RDF         | MHS             |   |
| Technician: | Project Number: | _ |
| RDF         | 153216          |   |

REVISIONS

Date

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2016 HANGAR

CONSTRUCTION PHASE D

awing Name:

No. Description


PROJECT LAYOUT
PLAN

| A A.I.P. Project Number: |                    |  |  |
|--------------------------|--------------------|--|--|
| NONE                     |                    |  |  |
| november, 2016           | Division: AIRPORTS |  |  |
| 1"=300'                  | Sheet Number:      |  |  |
| 1 –300                   | PLP-1              |  |  |

### GENERAL NOTES

- 1. ALL NON-PAVED AREAS OUTSIDE LIMITS OF CONSTRUCTION INCLUDING THE DESIGNATED STAGING AREA THAT ARE DISTURBED BY THE CONTRACTOR'S WORK, HAUL ROADS, ETC. SHALL BE RESEEDED AND RESTORED TO ORIGINAL CONDITION BY THE CONTRACTOR AS DIRECTED BY THE ENGINEER. THERE WILL BE NO SEPARATE PAY ITEM FOR THIS WORK.
- 2. THE CONTRACTOR WILL BE RESPONSIBLE FOR THE STORAGE AND SECURITY OF HIS MATERIAL AND EQUIPMENT AND SHALL ERECT STORAGE FACILITIES AND FENCING AS NECESSARY. THE CONTRACTOR'S STORAGE AND STAGING AREA SHALL BE IN THE LOCATION SHOWN ON DRAWINGS.
- 3. CONTRACTOR WILL NOT BE ALLOWED TO USE ANY OF THE EXISTING RUNWAYS OR TAXIWAYS AS PART OF THE HAUL ROAD UNLESS INDICATED ON DRAWINGS OR SPECIFICALLY AUTHORIZED BY THE ENGINEER.
- 4. ALL CONSTRUCTION TRAFFIC SHALL ENTER AND EXIT THE PROJECT AREA THROUGH THE PROJECT ACCESS ROUTES AS DETERMINED BY THE OWNER AND ENGINEER.
- 5. CONSTRUCTION STAKE-OUT SHALL BE PERFORMED BY CONTRACTOR IN ACCORDANCE WITH ARTICLE 50-06 OF THE SPECIFICATIONS.
- 6. THE CONTRACTOR WILL BE RESPONSIBLE FOR THE CLEANUP AND DISPOSAL OF ALL TRASH AND DEBRIS CREATED BY HIS WORK OR PERSONNEL. ALL TRASH AND DEBRIS MUST BE LEGALLY DISPOSED OF OFFSITE AND IN ACCORDANCE WITH ALL APPLICABLE FEDERAL, STATE AND LOCAL LAWS AND REGULATIONS.
- 7. CONTRACTOR WILL PROTECT ALL EXISTING UNDERGROUND UTILITIES AND SIGNS IN THE VICINITY OF THE WORK AREAS THAT ARE DESIGNATED TO REMAIN AND ANY DAMAGE WILL BE REPAIRED AT THE EXPENSE OF THE CONTRACTOR.
- 8. IN THE EVENT THE CONTRACTOR SERVICES HIS EQUIPMENT ON AIRPORT PROPERTY, ALL OIL AND FLUIDS REMOVED FROM THE EQUIPMENT MUST BE COLLECTED AND DISPOSED OF IN ACCORDANCE WITH THE LOCAL, STATE AND FEDERAL ENVIRONMENTAL LAWS. IF A HAZARDOUS OR REGULATED MATERIAL IS SPILLED, IT MUST BE PROMPTLY REPORTED TO THE AIRPORT AND CLEANED UP BY THE CONTRACTOR AT HIS EXPENSE.

- 9. CONTRACTOR SHALL VISIT THE SITE TO DETERMINE EXISTING CONDITIONS PRIOR TO SUBMITTING BID.
- 10. PRIOR TO DIGGING ANY TRENCHES, CONTRACTOR SHALL NOTIFY THE AIRPORT MANAGER TO HAVE ALL AIRPORT/FAA CABLES LOCATED.
- 11. ANY DAMAGES DONE TO AIRPORT PROPERTY OR UTILITIES (SUCH AS RUNWAY, TAXIWAYS, APRONS, FENCING, EXISTING AIRPORT AND/OR FAA CABLES) WILL BE REPAIRED BY THE CONTRACTOR TO THE ACCEPTANCE OF THE OWNER OF THE FACILITY IN A SATISFACTORY MANNER. THE CONTRACTOR WILL BEAR ALL COSTS FOR REPAIRS.
- 12. APPROVED CUTS IN PAVEMENT OR CONCRETE SHALL BE MADE USING A PAVEMENT SAW, AND SHALL BE PATCHED TO MATCH THE EXISTING SURFACE IN A MANNER APPROVED BY THE ENGINEER.
- 13. EXISTING EASEMENTS TO OTHER PROPERTIES SHALL BE MAINTAINED AT ALL TIMES.
- 14. IT SHALL BE THE RESPONSIBILITY OF THE CONTRACTOR TO PROVIDE ALL MEASUREMENTS THAT MAY BE REQUIRED TO LAY OUT THE CONSTRUCTION. THE COSTS OF STAKING WILL NOT BE PAID FOR DIRECTLY AND WILL BE INCLUDED IN THE UNIT PRICES FOR THE VARIOUS ITEMS OF WORK.
- 15. THE EXISTING AIRPORT PAVEMENTS, ACCESS ROADS, AND HAUL ROUTES MAY NOT BE CAPABLE OF SUPPORTING CERTAIN TYPES OF CONSTRUCTION EQUIPMENT. PRIOR TO BIDDING, THE CONTRACTOR SHALL FULLY SATISFY HIMSELF AS TO THE ABILITY OF THE EXISTING AIRPORT PAVEMENTS TO SATISFACTORILY SUSTAIN THE TYPE OF EQUIPMENT USED FOR CONSTRUCTION ACCORDINGLY. ANY DAMAGE CAUSED BY HAULING OR ANY OTHER CONSTRUCTION ACTIVITY TO EXISTING PAVEMENT SHALL BE REPAIRED BY THE CONTRACTOR AT NO ADDITIONAL COST TO THE OWNER. THE COST FOR CONSTRUCTING, MAINTAINING AND REMOVING ALL HAUL ROUTES SHALL BE INCLUDED AND CONSIDERED INCIDENTAL TO THE UNIT BID PRICE FOR MOBILIZATION.
- 16. ANY UNPLANNED, UNAPPROVED, OR ACCIDENTAL SHUTDOWN OR INTERRUPTION OF SERVICE TO ANY LIGHTING CIRCUIT OR NAVIGATIONAL AID REQUIRES IMMEDIATE NOTIFICATION TO THE OWNER AND THE ENGINEER AND SHALL BE REPAIRED IMMEDIATELY BY THE CONTRACTOR. THE COST OF MATERIALS AND LABOR REQUIRED TO REPAIR THE LIGHTING CIRCUIT SHALL BE BORNE BY THE CONTRACTOR.
- 17. ANY DAMAGE TO EXISTING UTILITIES OR UNDERGROUND PIPELINES ON OR OFF AIRPORT PROPERTY SHALL BE THE RESPONSIBILITY OF THE CONTRACTOR. ALL REPAIR WORK SHALL MEET THE APPROVAL OF THE OWNER OF THE DAMAGED UTILITY.
- 18. CONTRACTOR SHALL COORDINATE WORK AREAS WITH ENGINEER AND AIRPORT IN ORDER TO MINIMIZE DISRUPTION TO OPERATIONS. CONTRACTOR SHALL PLACE SUFFICIENT BARRICADES ON ALL SIDES OF WORK AREA TO SEPARATE CONSTRUCTION ACTIVITES FROM AIRPORT OPERATIONS. NOTAM SHALL BE ISSUED THAT MEN AND EQUIPEMENT ARE WORKING IN APRON AREA.

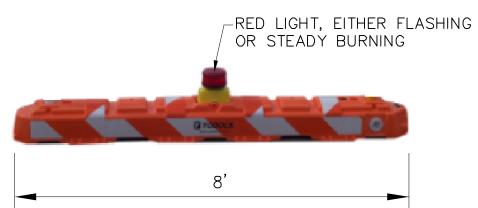

### **BARRICADE NOTES:**


- 1. BARRICADES SHALL MEET FAA SPECIFICATIONS AS OUTLINED IN CURRENT FAA ADVISORY CIRCULARS.
- 2. CONTRACTOR SHALL WEIGHT BARRICADE TO PREVENT DISPLACEMENT. METHOD TO BE APPROVED BY THE ENGINEER.
- 3. 8' BARRICADES SHALL BE LOCATED AT 12' CENTER TO CENTER MAXIMUM, WITH A BARRICADE ON THE CENTERLINE OF THE TAXIWAY, WHERE APPLICABLE.
- 4. 8' BARRICADES SHALL BE LOCATED AT 12' CENTER TO CENTER MAXIMUM, BARRICADES USED ON RUNWAYS AND TAXIWAYS MUST BE EASILY
- 5. POLYETHYLENE BARRICADES ARE RECOMMENDED. (SHERWIN INDUSTRIES OR APPROVED EQUAL.) COLLAPSIBLE UPON CONTACT WITH AN AIRCRAFT. (NO RAILROAD TIES)

### LIGHTED BARRICADE DETAIL

SCALE: NONE

### TEMPORARY MARKINGS, BARRICADES, AND TRAFFIC CONTROL

- SEE SPECIFICATION SECTION 01030 AND 01530.
- 2. THE CONTRACTOR SHALL PROVIDE NOTIFICATION OF START OF CONSTRUCTION A MINIMUM OF 15 DAYS PRIOR TO EXPECTED START DATE. CONTRACTOR SHALL INSTALL LIGHTED BARRICADES AND CLOSURE "X"S ACROSS RUNWAYS AS INDICATED ON CONSTRUCTION SAFETY PLAN, AS WELL AS STANDARD BARRICADES AROUND ANY EXCAVATIONS.
- 3. THE CONTRACTOR SHALL BE PREPARED TO UPON NOTIFICATION, IMMEDIATELY REMOVE ALL BARRICADES AND TO TAKE OTHER MEASURES AS NEEDED TO ACCOMMODATE EMERGENCY LANDING BY AIRCRAFT WHILE WORK IS IN PROGRESS.
- 4. ALL BARRICADES AND CLOSURE MARKINGS SHALL REMAIN THE PROPERTY OF THE CONTRACTOR UPON COMPLETION.

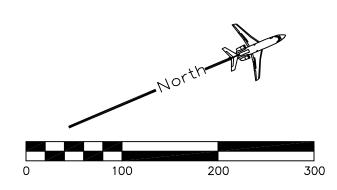






THE CONTRACTOR'S EQUIPMENT STORAGE

THE CONTRACTOR'S EMPLOYEE PARKING

INSTALL AND MAINTAIN LIGHTED BARRICADES

### **CONTRACT TIME**

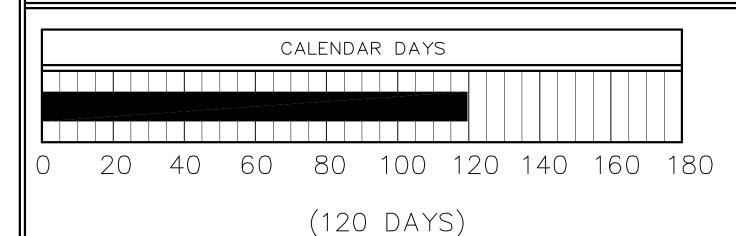

THE THE CONTRACTOR SHALL SUBMIT A CONSTRUCTION SCHEDULE TO THE ENGINEER FOR APPROVAL PRIOR TO BEGINNING CONSTRUCTION. CONSTRUCTION MAY NOT BEGIN UNTIL THE CONSTRUCTION SEQUENCE IS APPROVED BY THE ENGINEER.

### **CONSTRUCTION SAFETY PLAN & WORK RESTRICTIONS**


- AIRPORT SECURITY IS A PRIMARY CONCERN OF THE AIRPORT, ARKANSAS DEPARTMENT OF AERONAUTICS, AND THE FAA. THE CONTRACTOR WILL BE ALLOWED ACCESS TO THE CONSTRUCTION AREAS AT THE LOCATIONS SHOWN ON THE PLANS. SEE PARAGRAPH SC-08 OF THE CONTRACT DOCUMENTS FOR ADDITIONAL INFORMATION ON SECURITY REQUIREMENTS. THE CONTRACTOR'S ACCESS GATES INTO THE SECURED AREA OF THE AIRPORT SHALL BE KEPT GUARDED OR LOCKED AT ALL TIMES. THE CONTRACTOR AY BE ALLOWED ACCESS AT ADDITIONAL LOCATIONS WITH THE APPROVAL OF THE OWNER AND ENGINEER.
- THE INTENT OF THE CONTRACT DOCUMENTS IS TO ORGANIZE AND CONTROL THE WORK SO THAT IT IS ACCOMPLISHED WITH MINIMUM INCONVENIENCE TO THE AIRPORT, AND TO INSURE THE SAFETY OF AIRCRAFT MOVEMENTS AT THE AIRPORT DURING THE CONSTRUCTION PERIOD. ALL WORK SHALL BE ACCOMPLISHED IN ACCORDANCE WITH FAA ADVISORY CIRCULAR 150/5370-2E, LATEST EDITION, WHICH IS REPRODUCED IN THE SPECIFICATIONS. TO ACCOMPLISH THIS, THE WORK IS RESTRICTED IN THE AIRPORT OPERATIONS AREA (AOA) AS DEFINED HEREIN.
- .ALL WORK WITHIN AN AIRPORT OPERATIONS AREA (AOA) SHALL BE COORDINATED STRICTLY WITH THE ENGINEER AND AIRPORT MANAGER. IT SHALL BE THE FULL AND SOLE RESPONSIBILITY OF THE CONTRACTOR TO PROVIDE THE REQUIRED COORDINATION, AND TO RECEIVE AND COMPLY WITH ALL INSTRUCTIONS ISSUED BY THE ENGINEER AND AIRPORT OPERATIONS MANAGER. WHEN THE CONTRACTOR'S OPERATIONS CROSS AN ACTIVE TAXIWAY, FLAGMEN SHALL BE STATIONED CONTINUOUSLY IN THE CROSSING AREA. TAXIING AIRCRAFT SHALL AT ALL TIME HAVE RIGHT OF WAY OVER CONSTRUCTION VEHICLE/EQUIPMENT/PERSONNEL.
- 4.ALL WORK AREAS AS INDICATED ON THIS SHEET ARE LOCATED WITHIN OR ADJACENT TO THE AOA, AND REQUIRE APPROPRIATE COORDINATION AS DESCRIBED PREVIOUSLY.
- 5. THE CONTRACTOR SHALL INSURE THAT THE PAVEMENT SURFACE WITHIN AN ACTIVE AIRCRAFT MOVEMENT AREA IS KEPT CLEAN FROM DIRT, MUD, AND OTHER DEBRIS FROM THE CONTRACTOR'S EQUIPMENT.
- 6. THE CONTRACTOR SHALL TAKE CARE NOT TO DAMAGE EXISTING STRUCTURES, AND SHALL BE RESPONSIBLE FOR REPAIR OF DAMAGED STRUCTURES.
- 7. CONSTRUCTION AND HAULING EQUIPMENT WILL NOT BE ALLOWED ON AIRFIELD PAVEMENT UNLESS SPECIFICALLY SHOWN ON PLANS OR APPROVED BY THE ENGINEER.
- 8.NOTAMS SHALL BE COORDINATED WITH THE AIRPORT THROUGH THE ENGINEER BEFORE THE WORK FOR WHICH THE NOTAM IS ISSUED BEGINS.
- 9.A PORTION OF THE EXISTING SECURITY FENCE SHALL BE REMOVED UNDER THIS CONTRACT. THE CONTRACTOR SHALL MAINTAIN THE SECURITY OF THE AIRFIELD AT ALL TIMES DURING CONSTRUCTION BY CONSTRUCTING TEMPORARY SECURITY FENCE. THE TEMPORARY SECURITY FENCE SHALL BE INSTALLED, RELOCATED AS NEEDED DURING CONSTRUCTION, AND REMOVED AT THE END OF THE PROJECT. THE TEMPORARY FENCE SHALL CONSIST OF A MINIMUM 6' TALL CHAIN LINK FENCE. (SUBSIDIARY TO MOBILIZATION)
- 10.ALL BARRICADES SHALL REMAIN THE PROPERTY OF THE CONTRACTOR UPON COMPLETION.




**JONESBORO MUNICIPAL AIRPORT** JONESBORO, ARKANSAS

### Michael Baker

INTERNATIONA

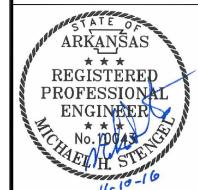

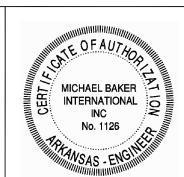

| Designer:   | Checked by:     |
|-------------|-----------------|
| RDF         | MHS             |
| Technician: | Project Number: |
| RDF         | 153216          |

**NOTE:** CONTRACTOR SHALL STRICTLY COORDINATE ALL WORK WITH ENGINEER/AIRPORT MANAGER.

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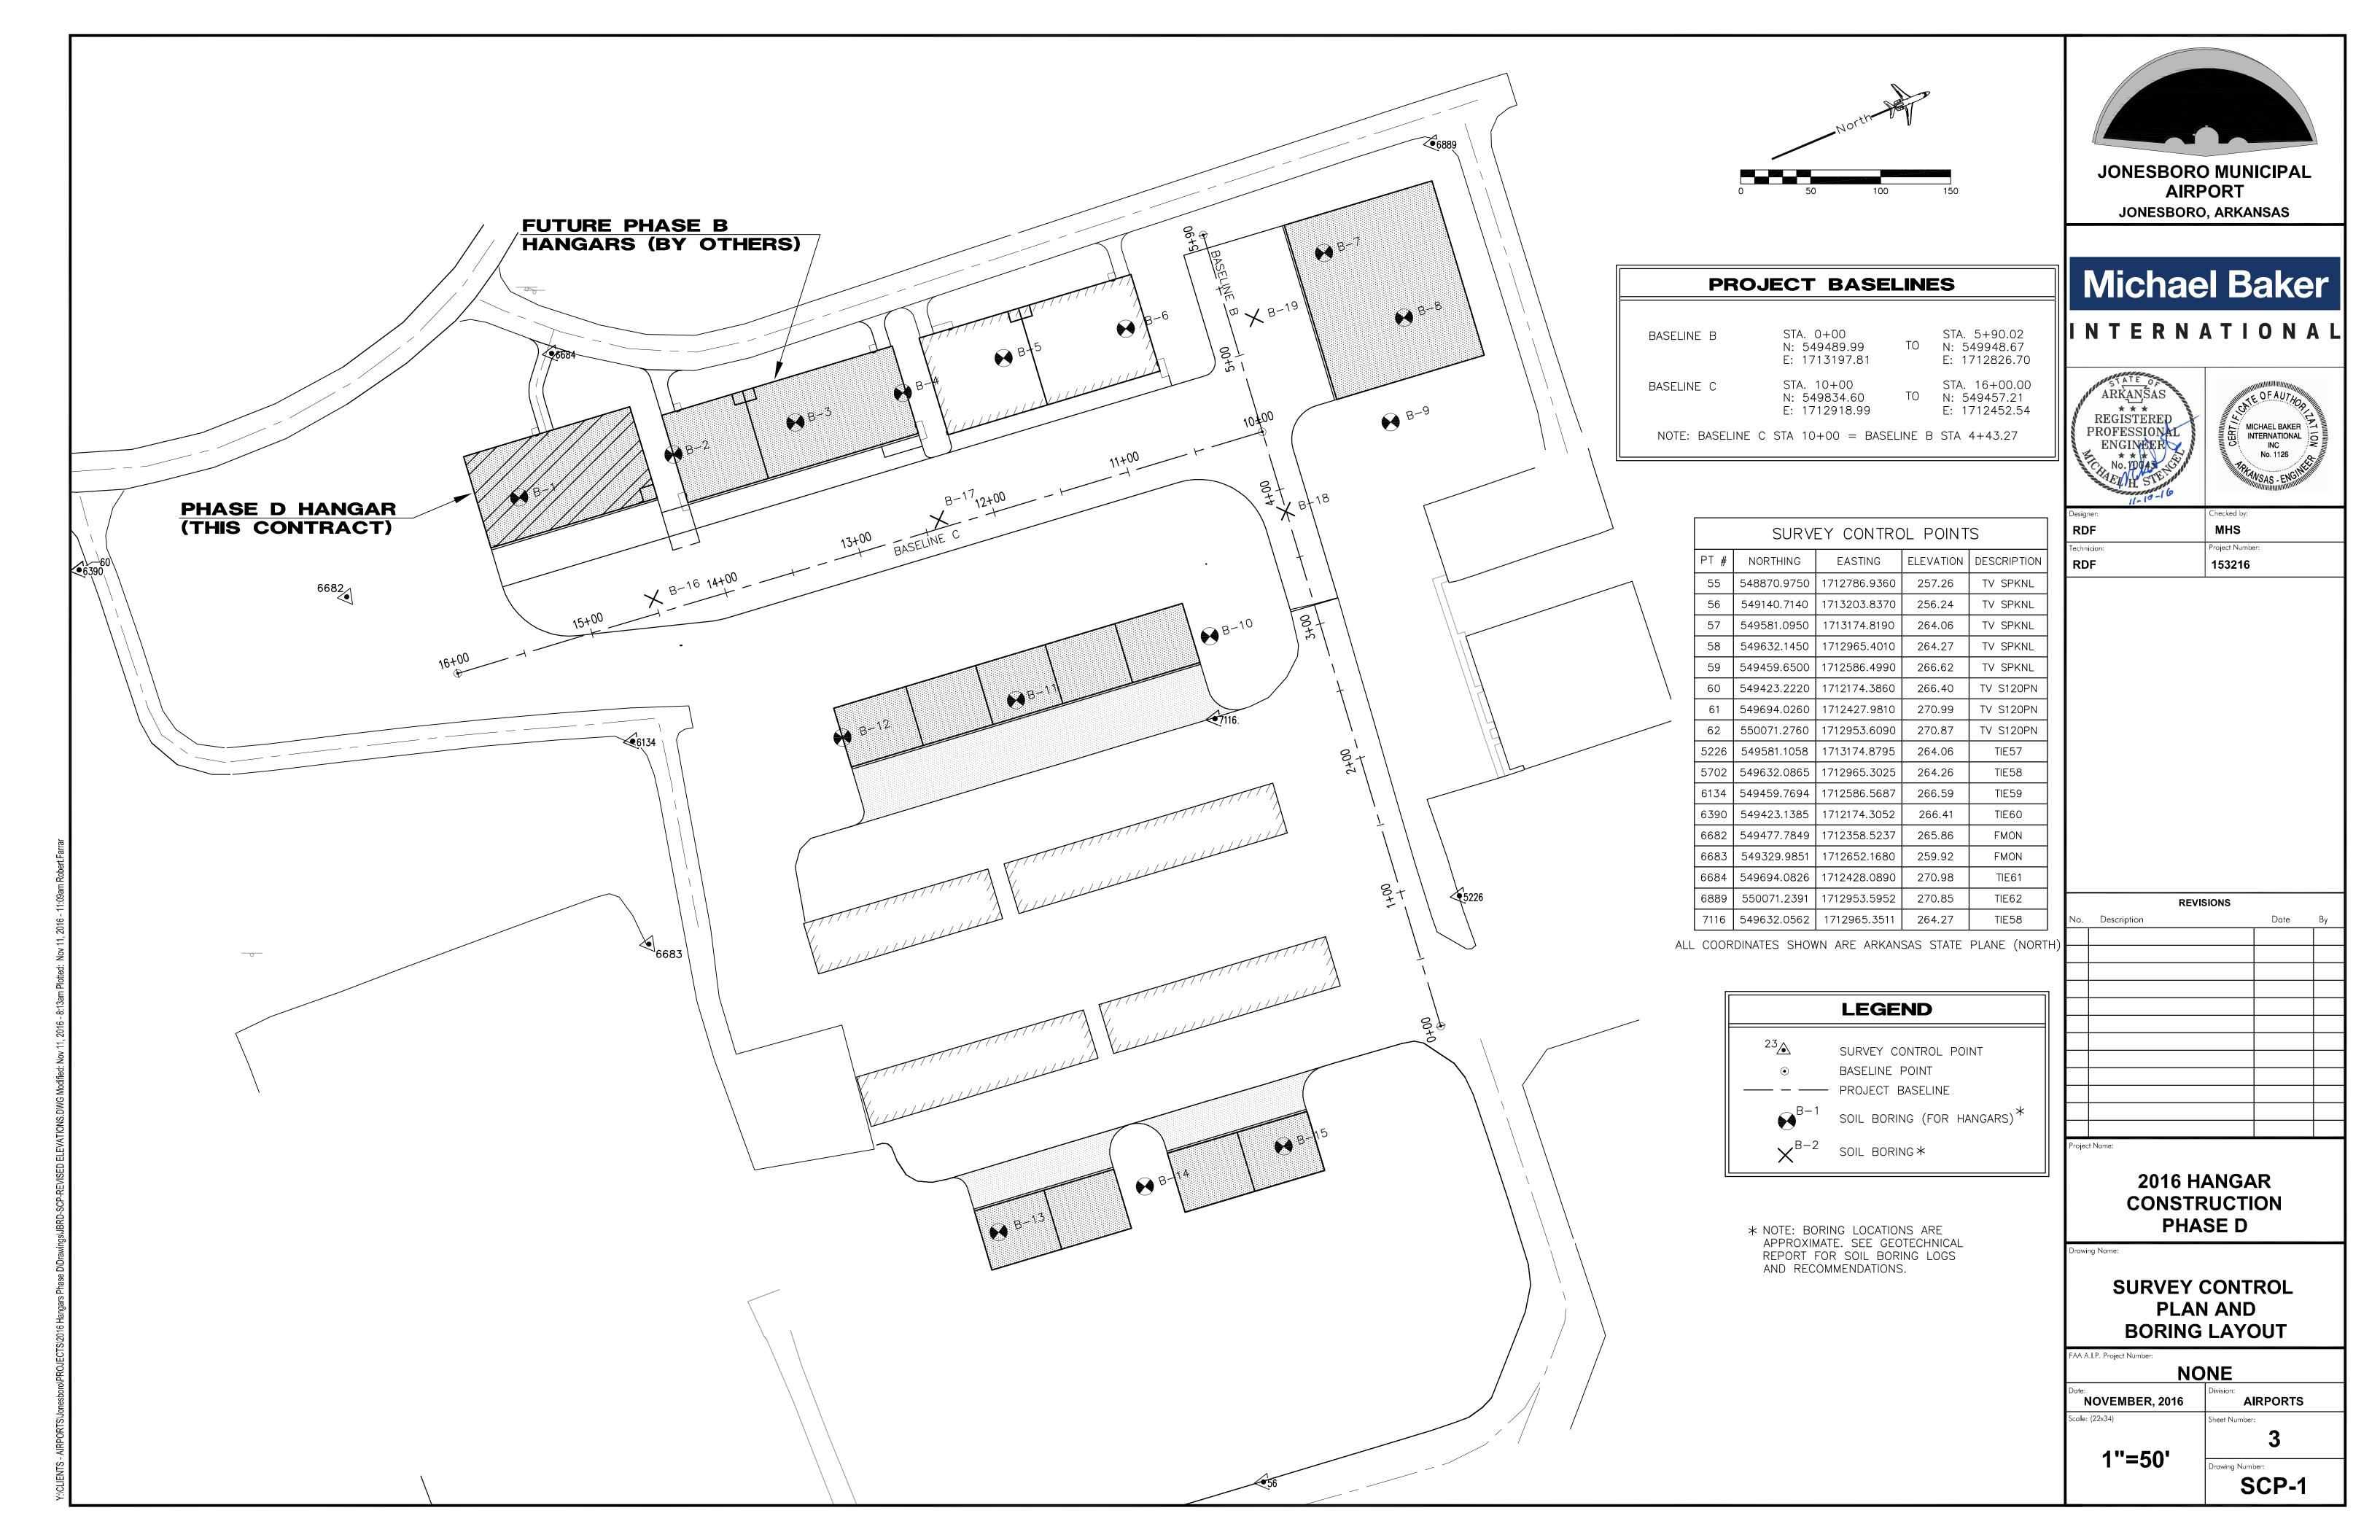
**2016 HANGAR** CONSTRUCTION PHASE D


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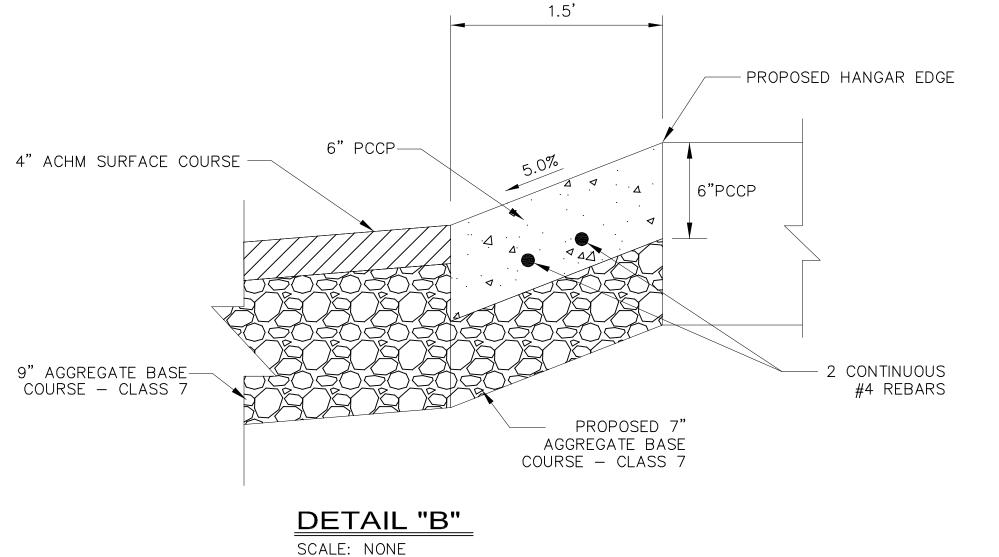
CONSTRUCTION **SAFETY PLAN** 

| FAA A.I.P. Project Number: |                          |  |
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| NONE                       |                          |  |
| Date: NOVEMBER, 2016       | Division: AIRPORTS       |  |
| Scale: (22x34)             | Sheet Number:            |  |
| 1"=100'                    | <b>2</b> Drawina Number: |  |

CSP-1





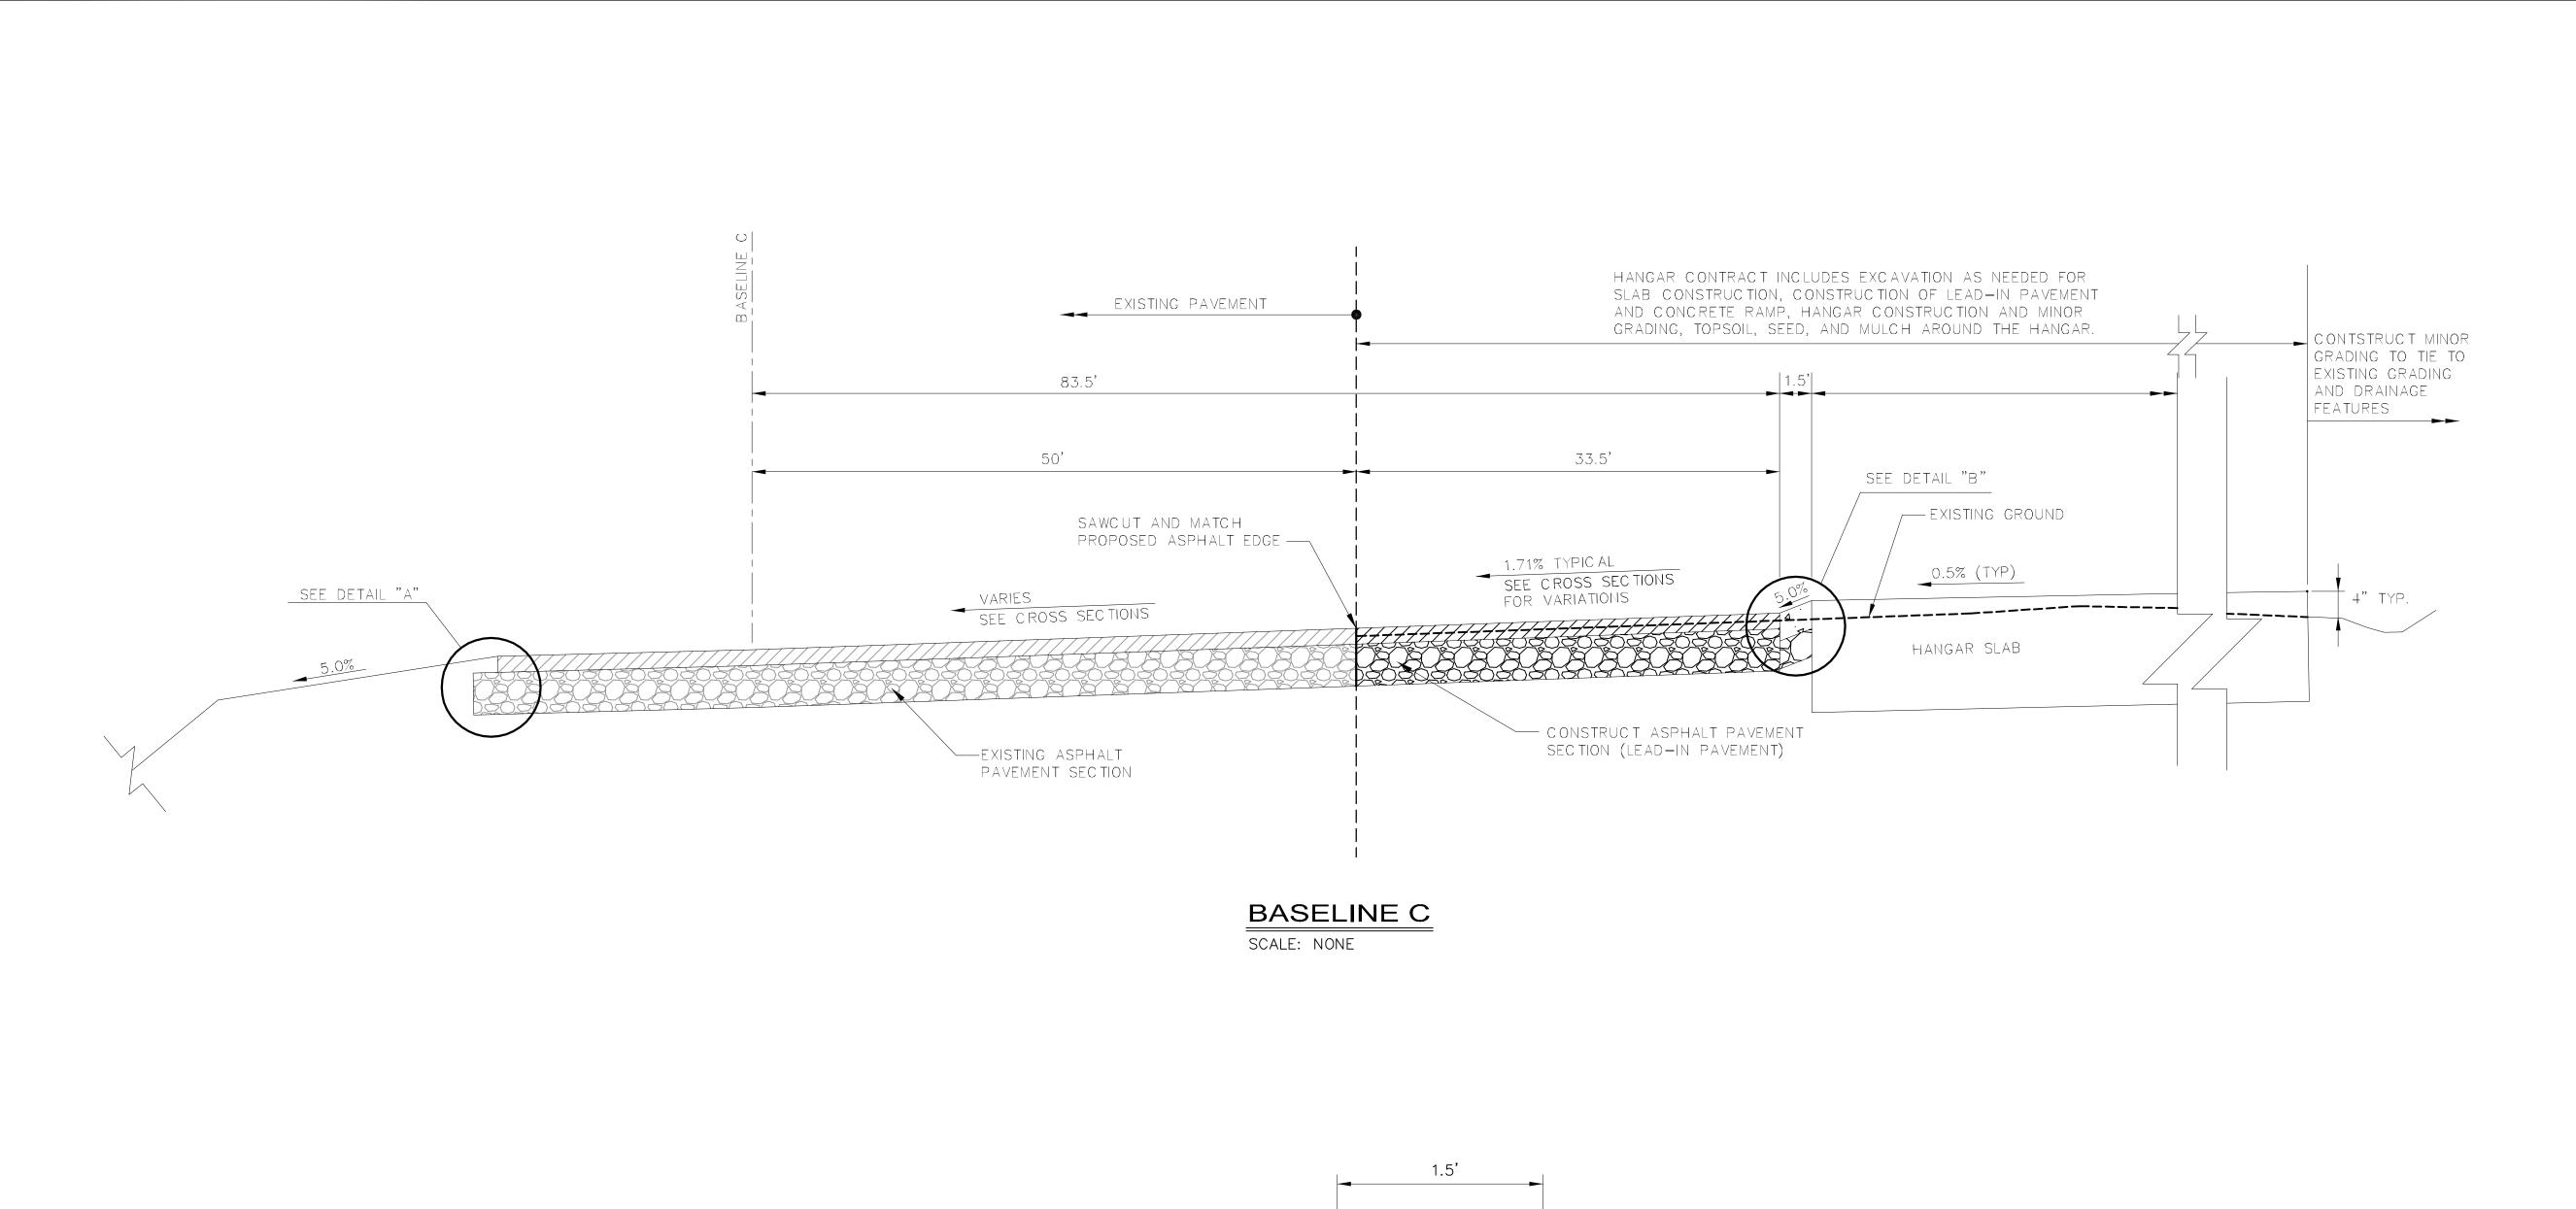


FINISHED GRADE -

BASE COURSE EXTENDS 1'
BEYOND EDGE OF ACHM

SURFACE COURSE

DETAIL "A"

SCALE: NONE

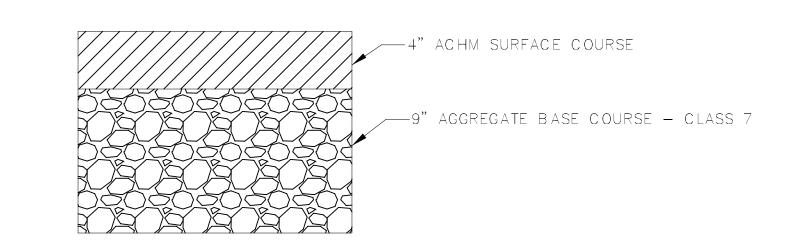

### ASPHALT PAVEMENT SECTION

SCALE: NONE

### NOTE:

CONTRACTOR SHALL HAVE THE OPTION TO CONSTRUCT CONCRETE PAVEMENT SECTION (6" PCCP OVER 5" BASE) AT ALL LOCATIONS IN LIEU OF ASPHALT PAVEMENT SECTION. NO REINFORCEMENT STEEL WILL BE REQUIRED FOR THAT PAVEMENT AREA.



### Michael Baker

INTERNATIONAL





| Designer:   | Checked by:     |  |
|-------------|-----------------|--|
| RDF         | MHS             |  |
| Technician: | Project Number: |  |
| RDF         | 153216          |  |

| REVISIONS     |             |  |      |    |
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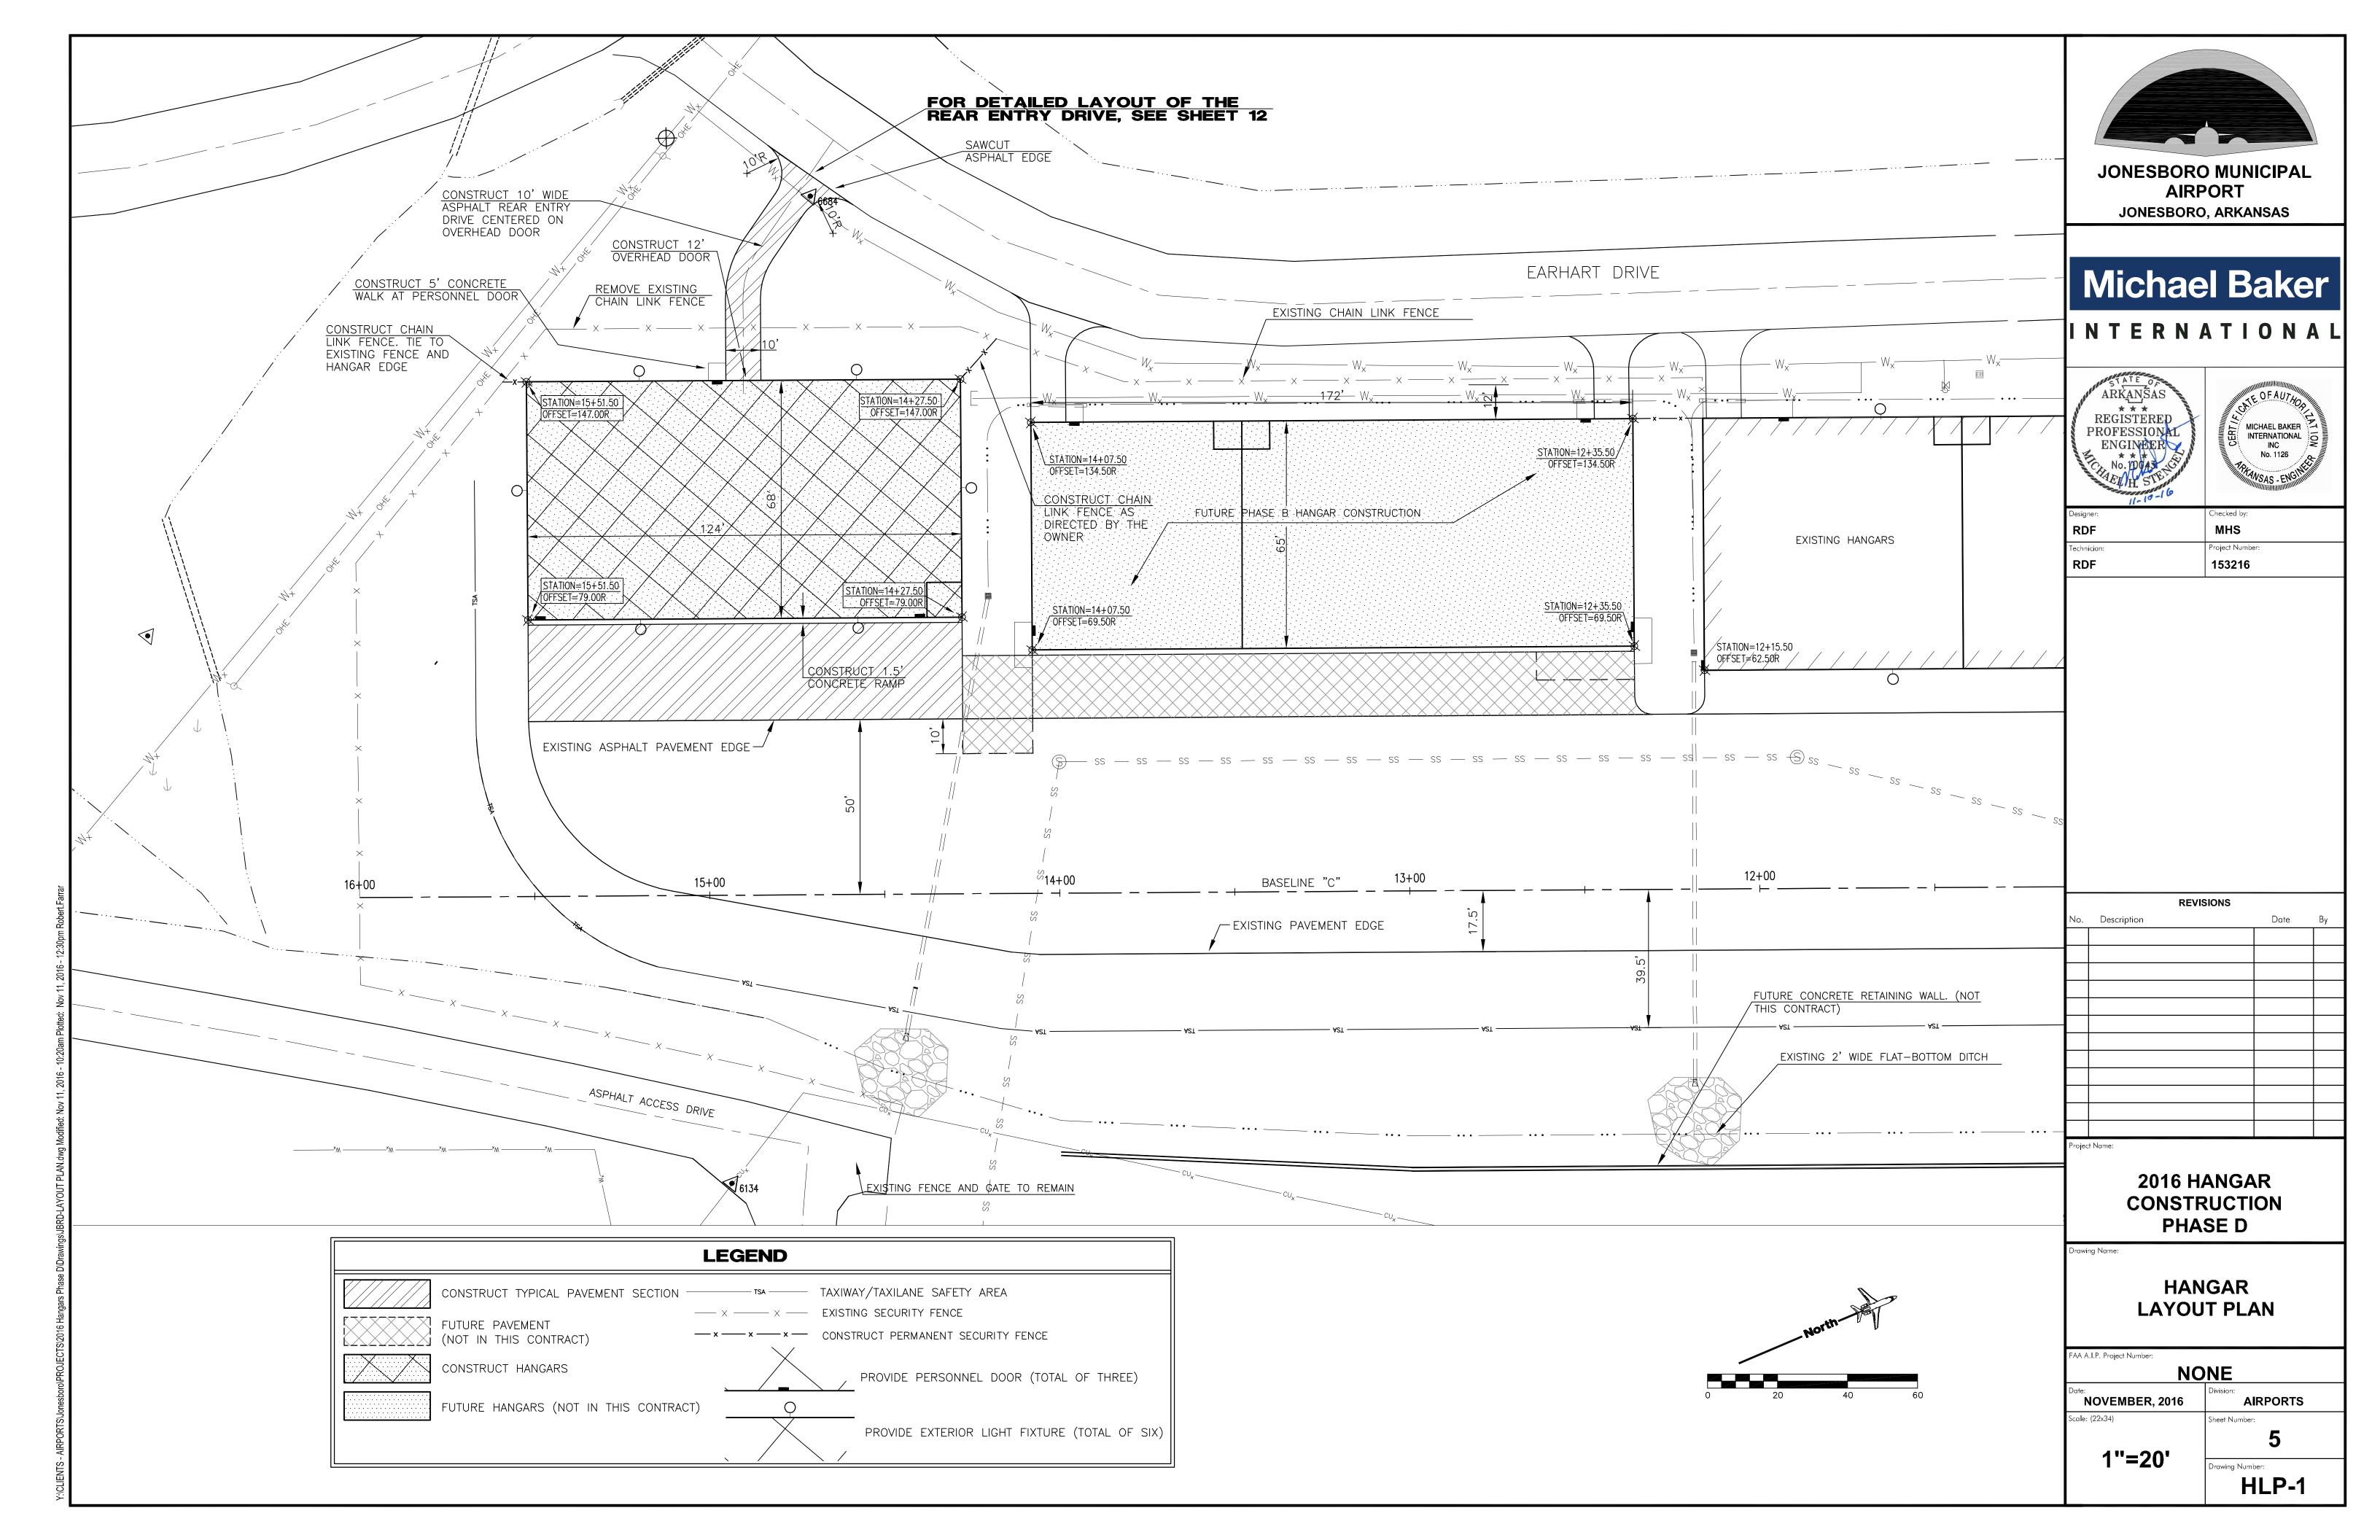
2016 HANGAR CONSTRUCTION PHASE D


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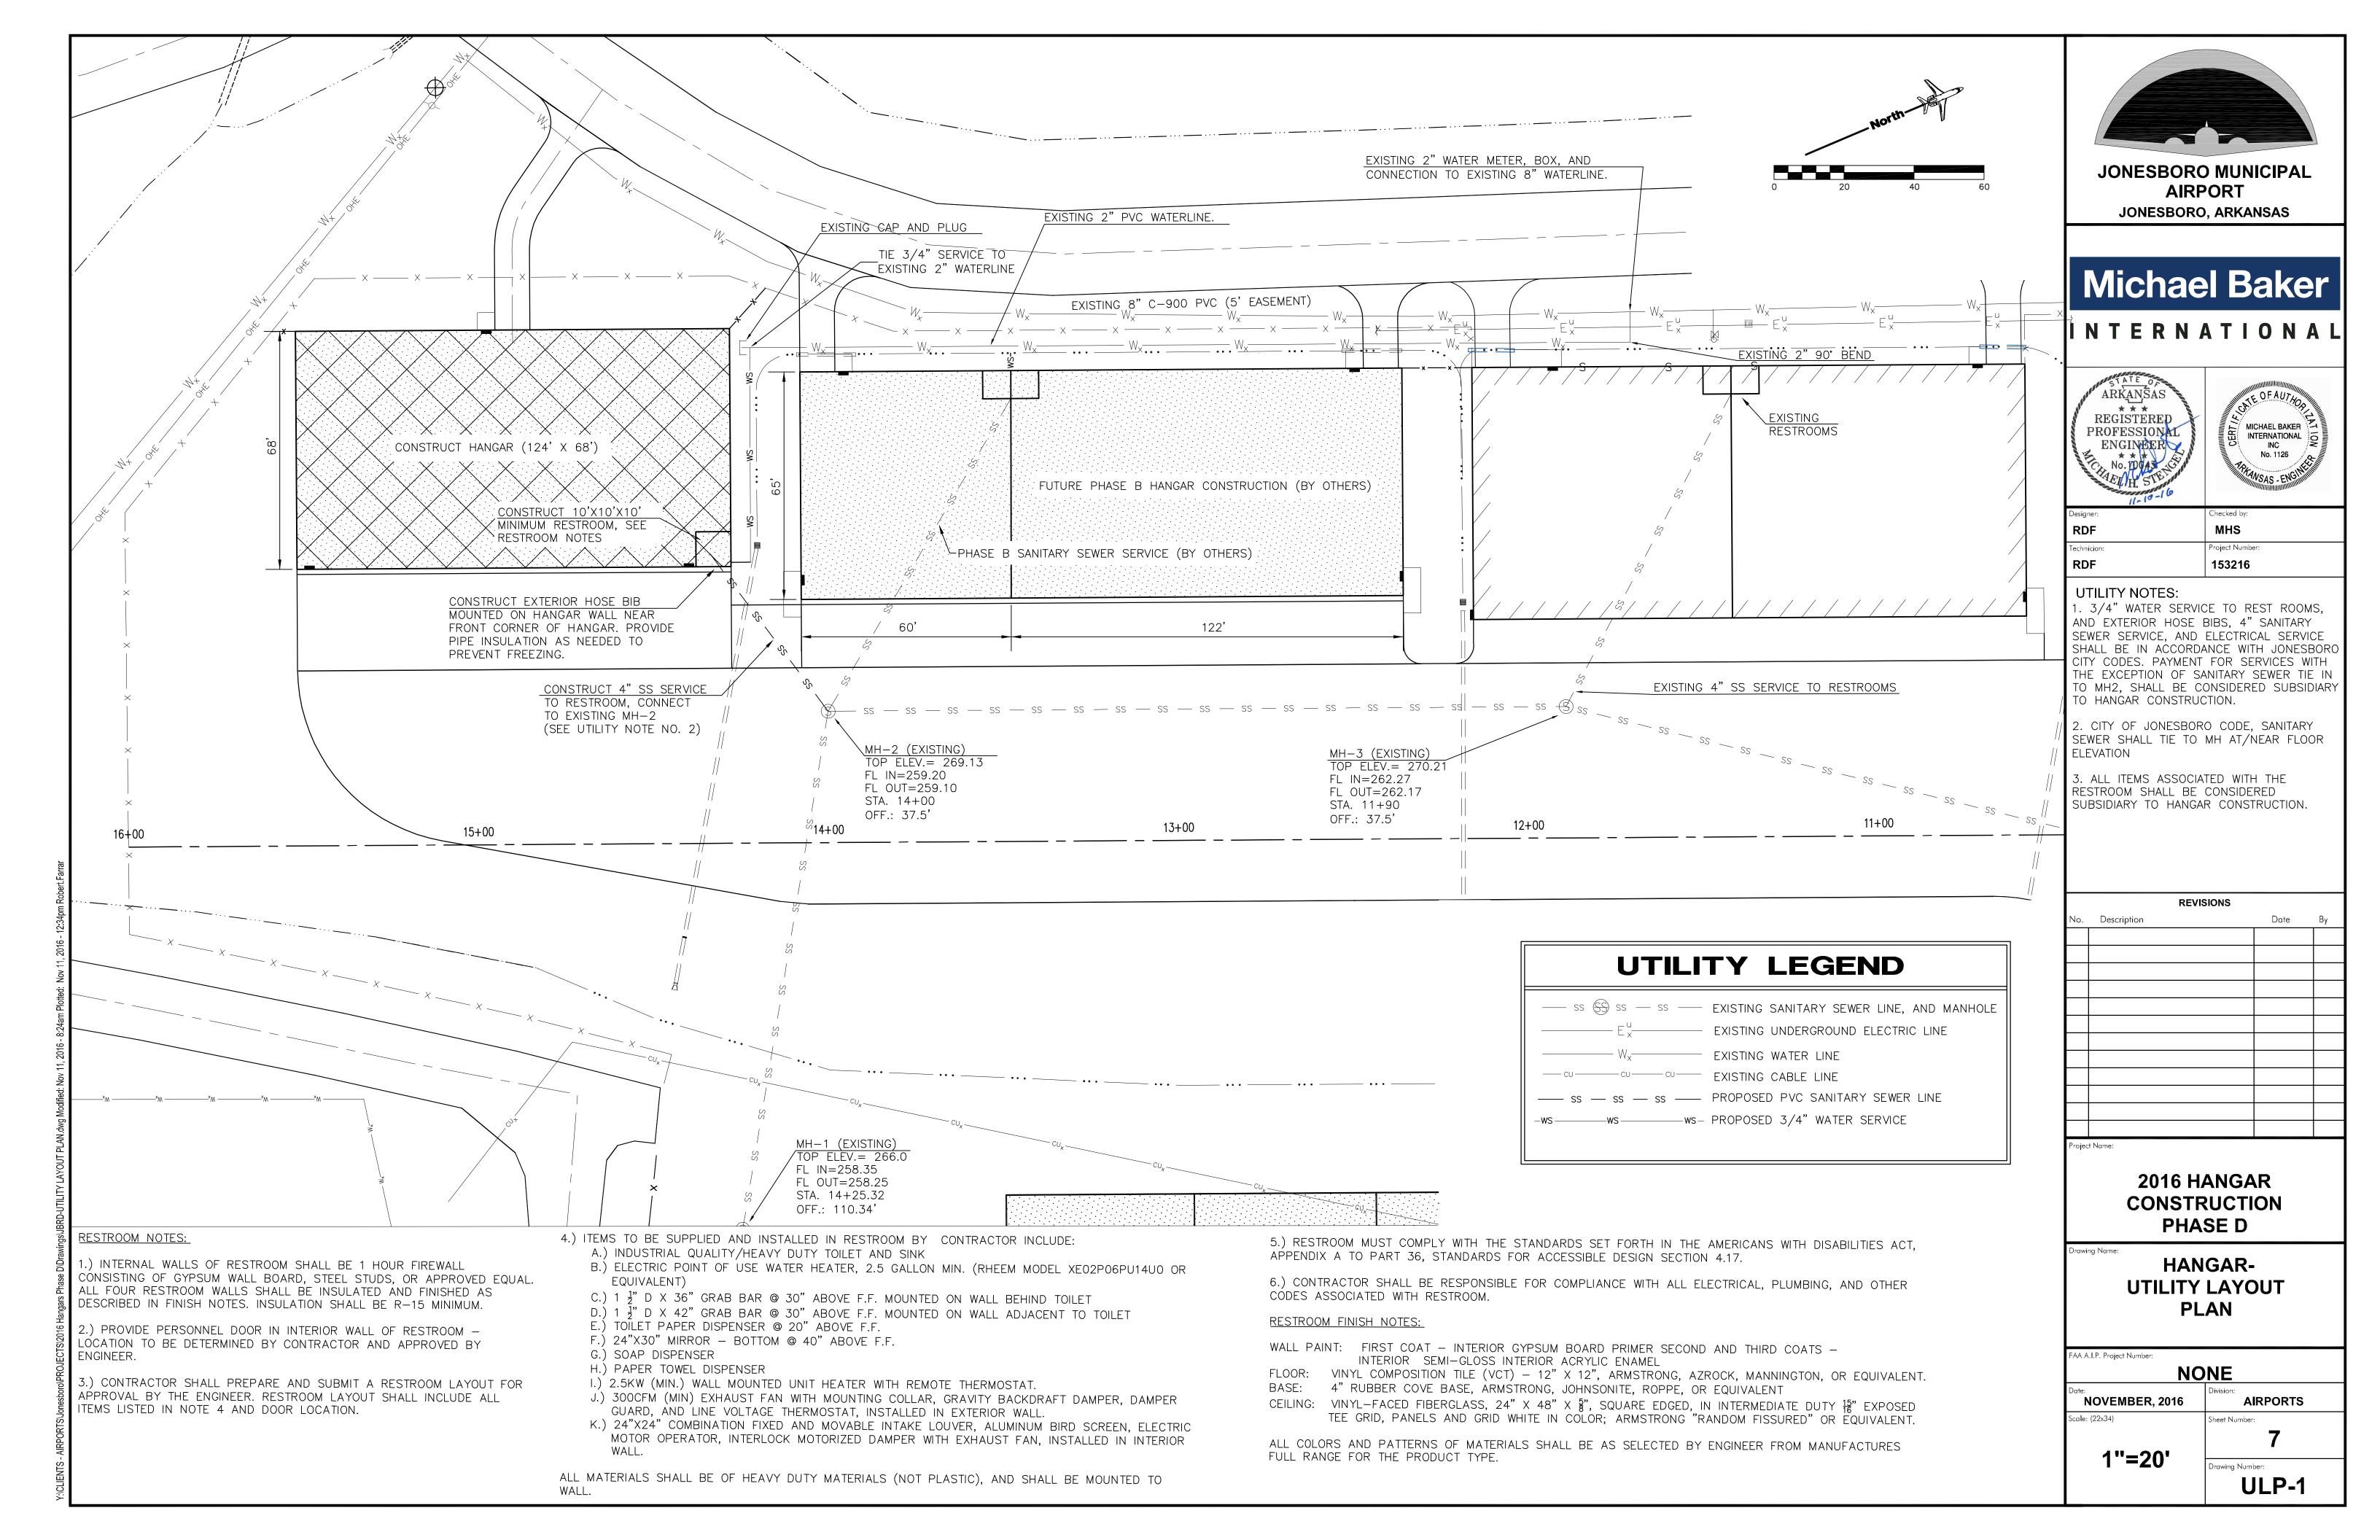
FAA A.I.P. Project Number:


TYPICAL SECTIONS


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| OVEMBER, 2016 | Division: AIRPORTS    |  |
| (22x34)       | Sheet Number:         |  |
| NONE          | Drawing Number:  TS-1 |  |





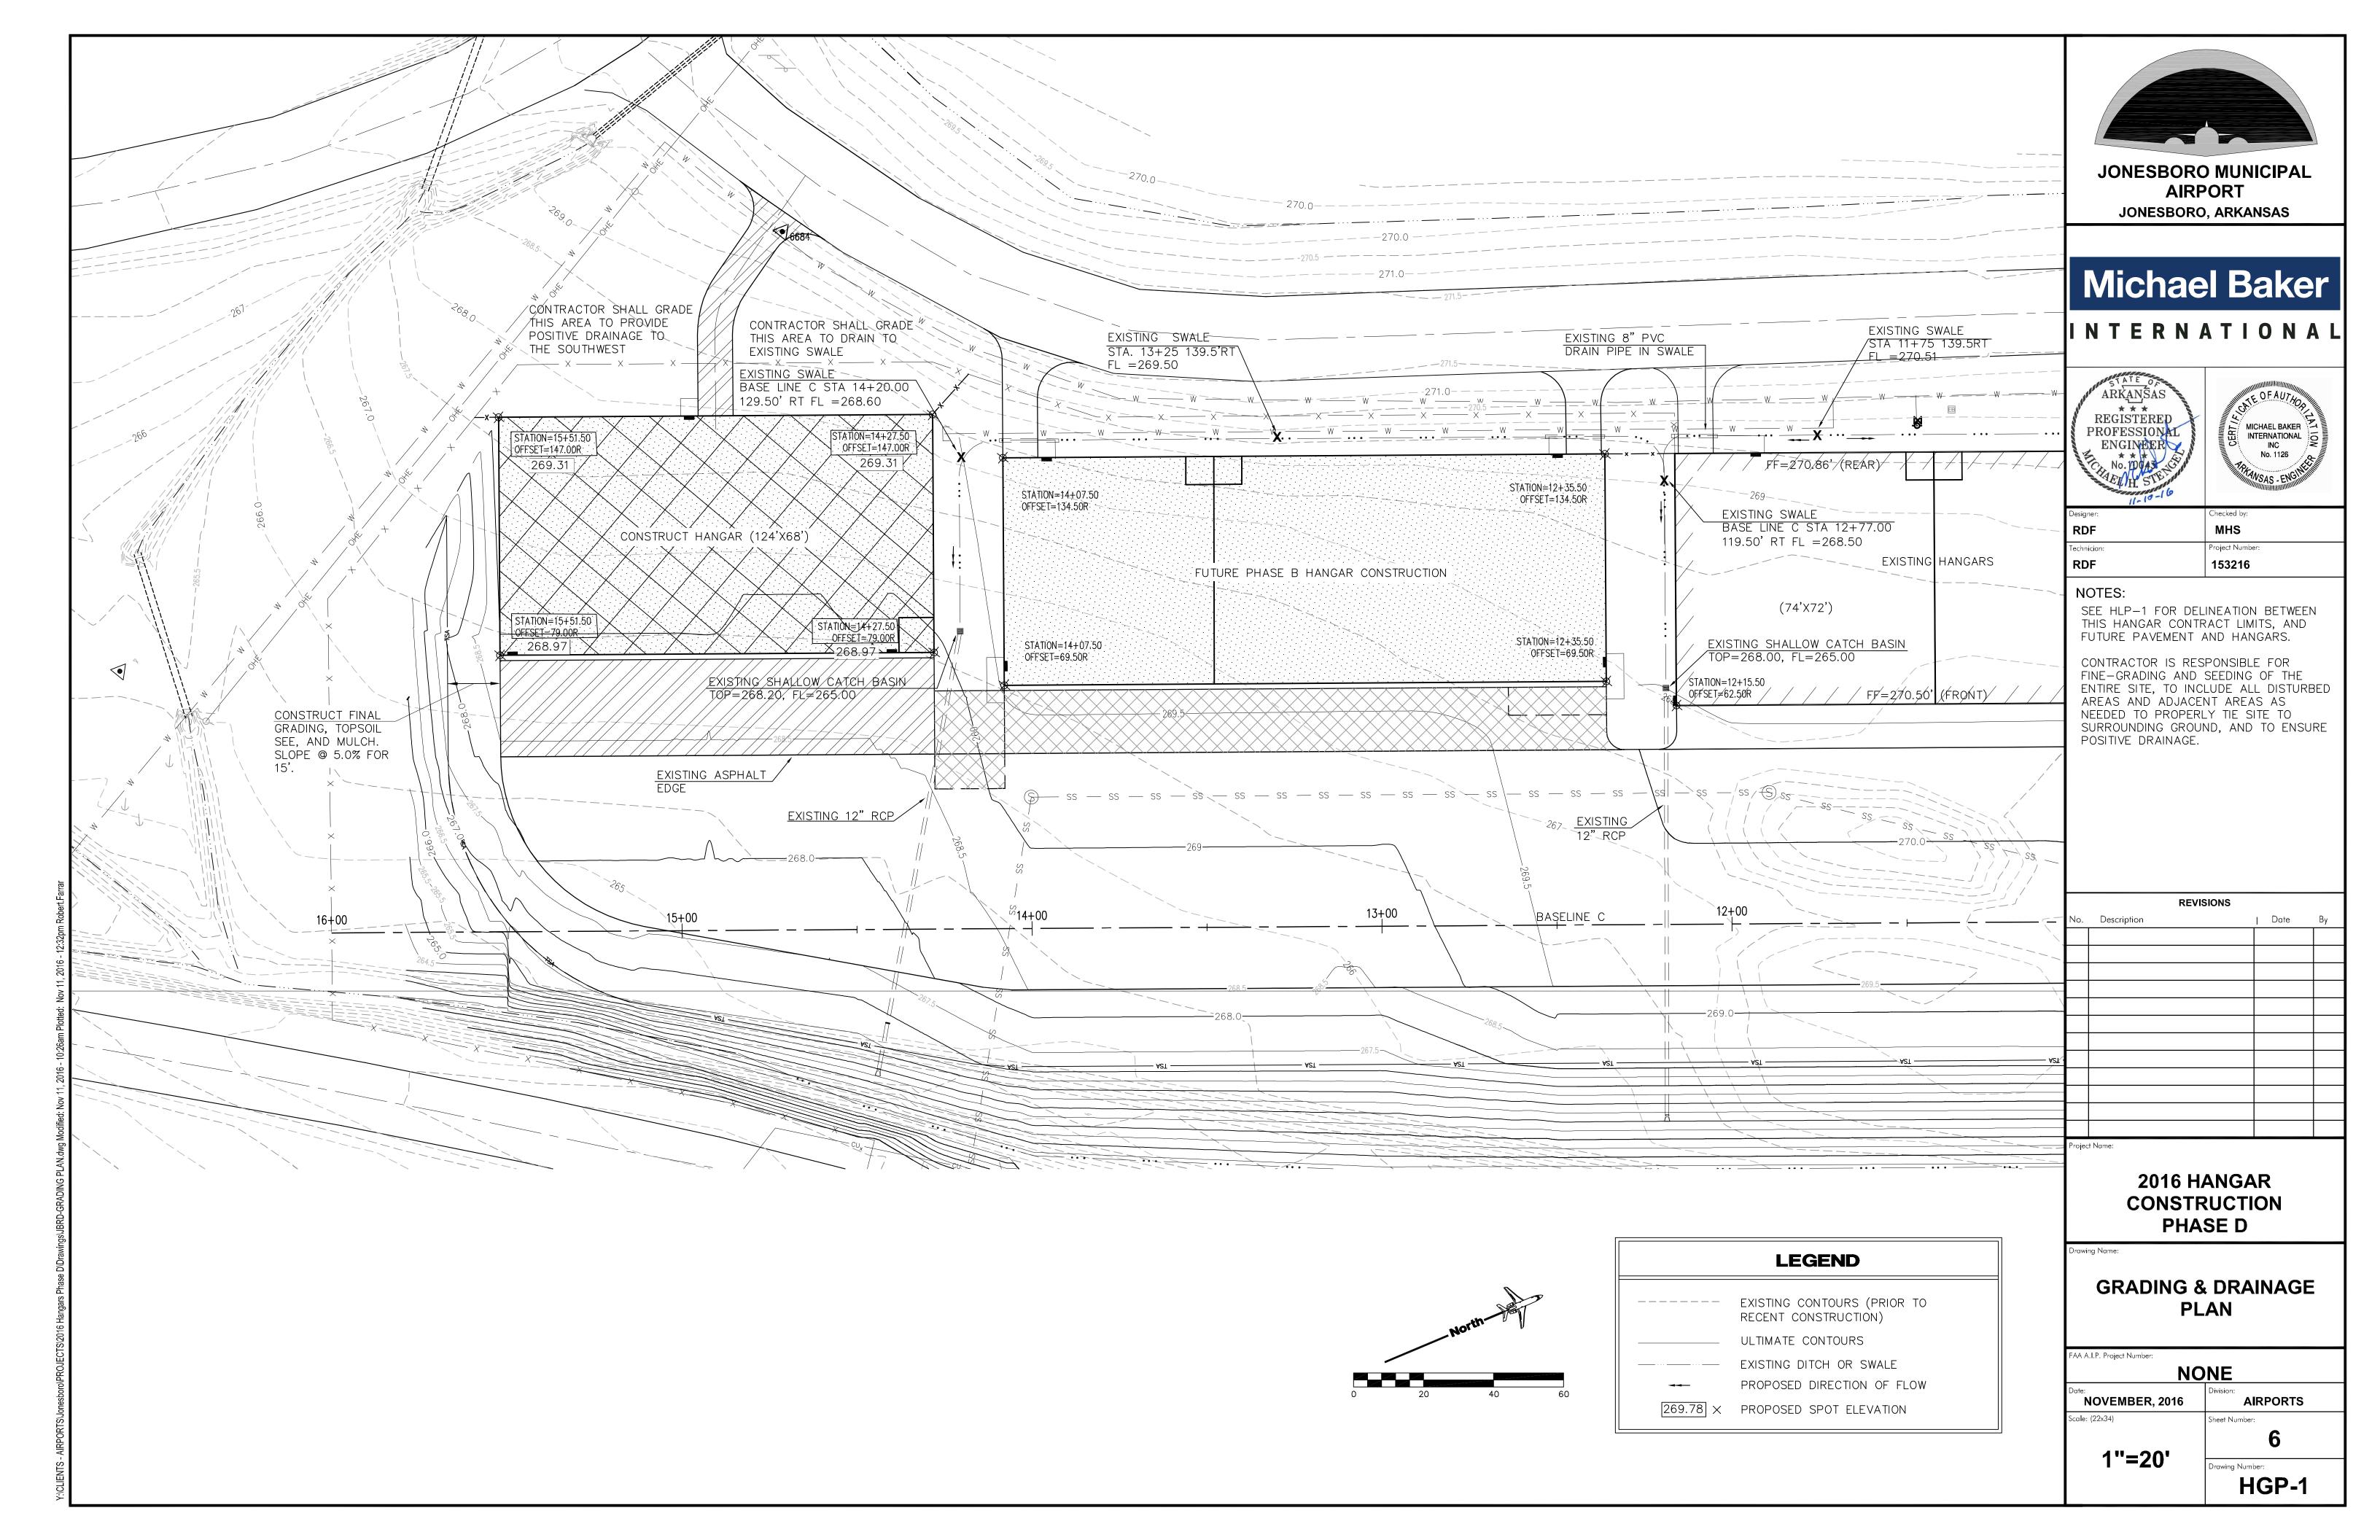

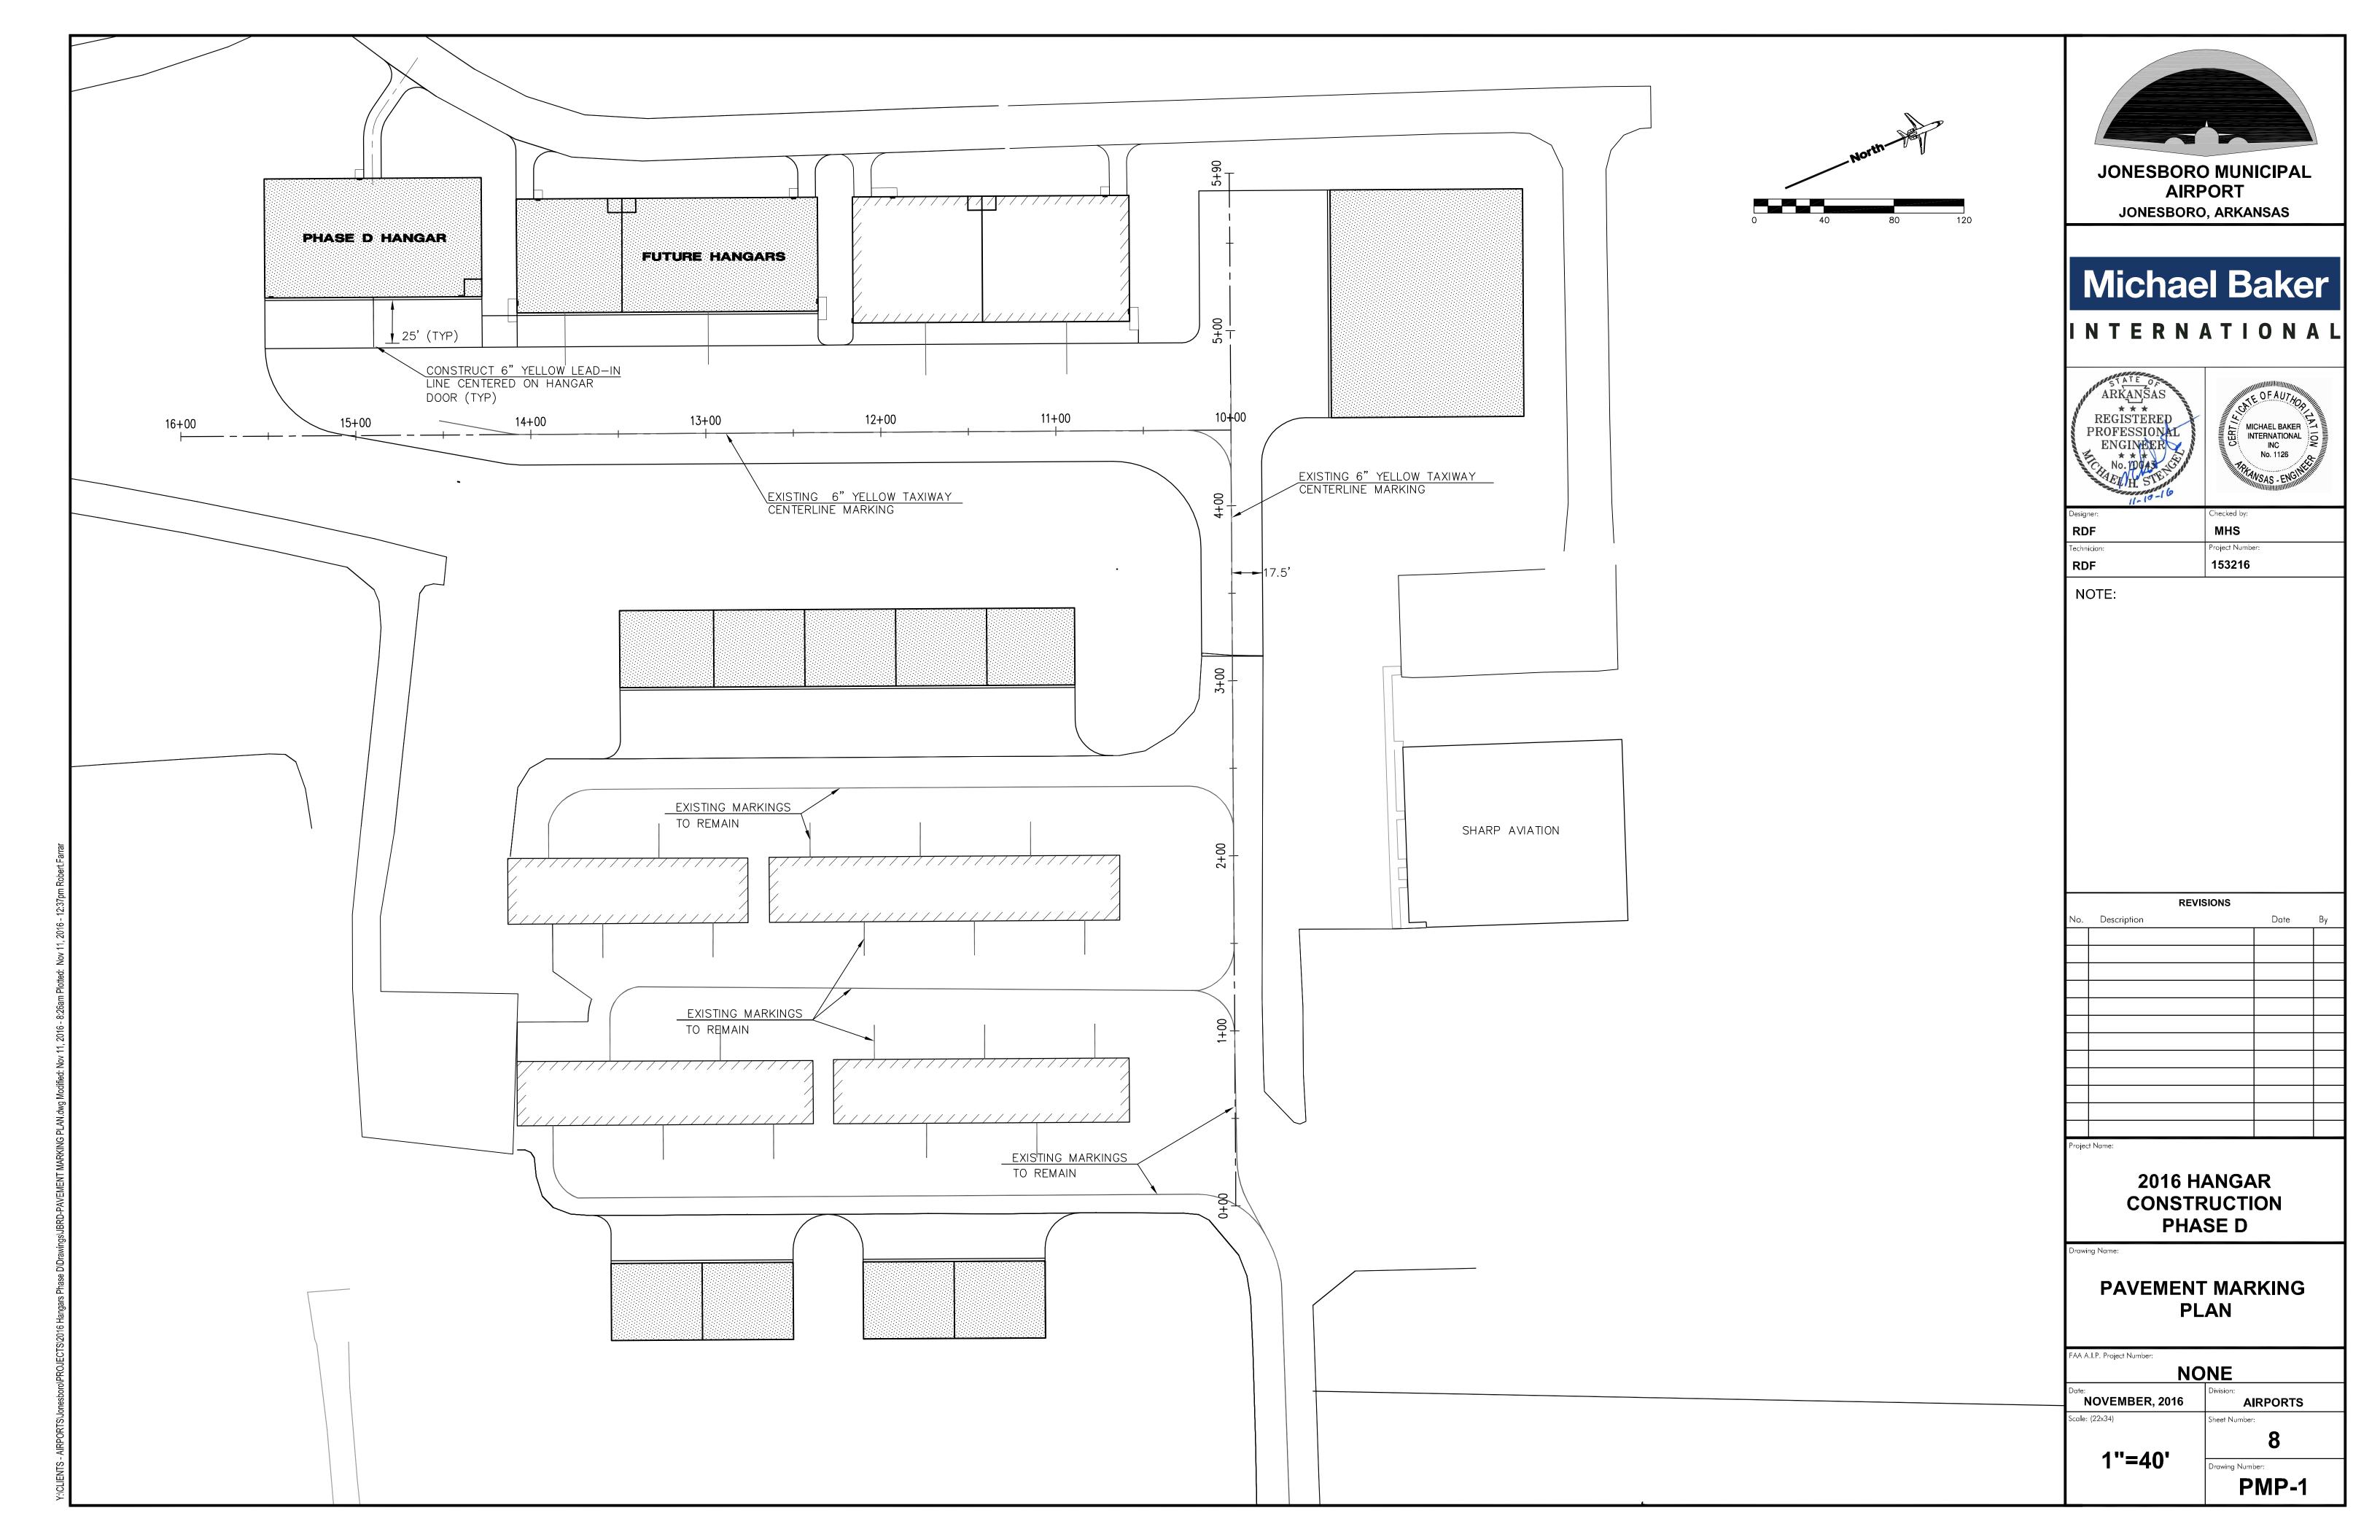

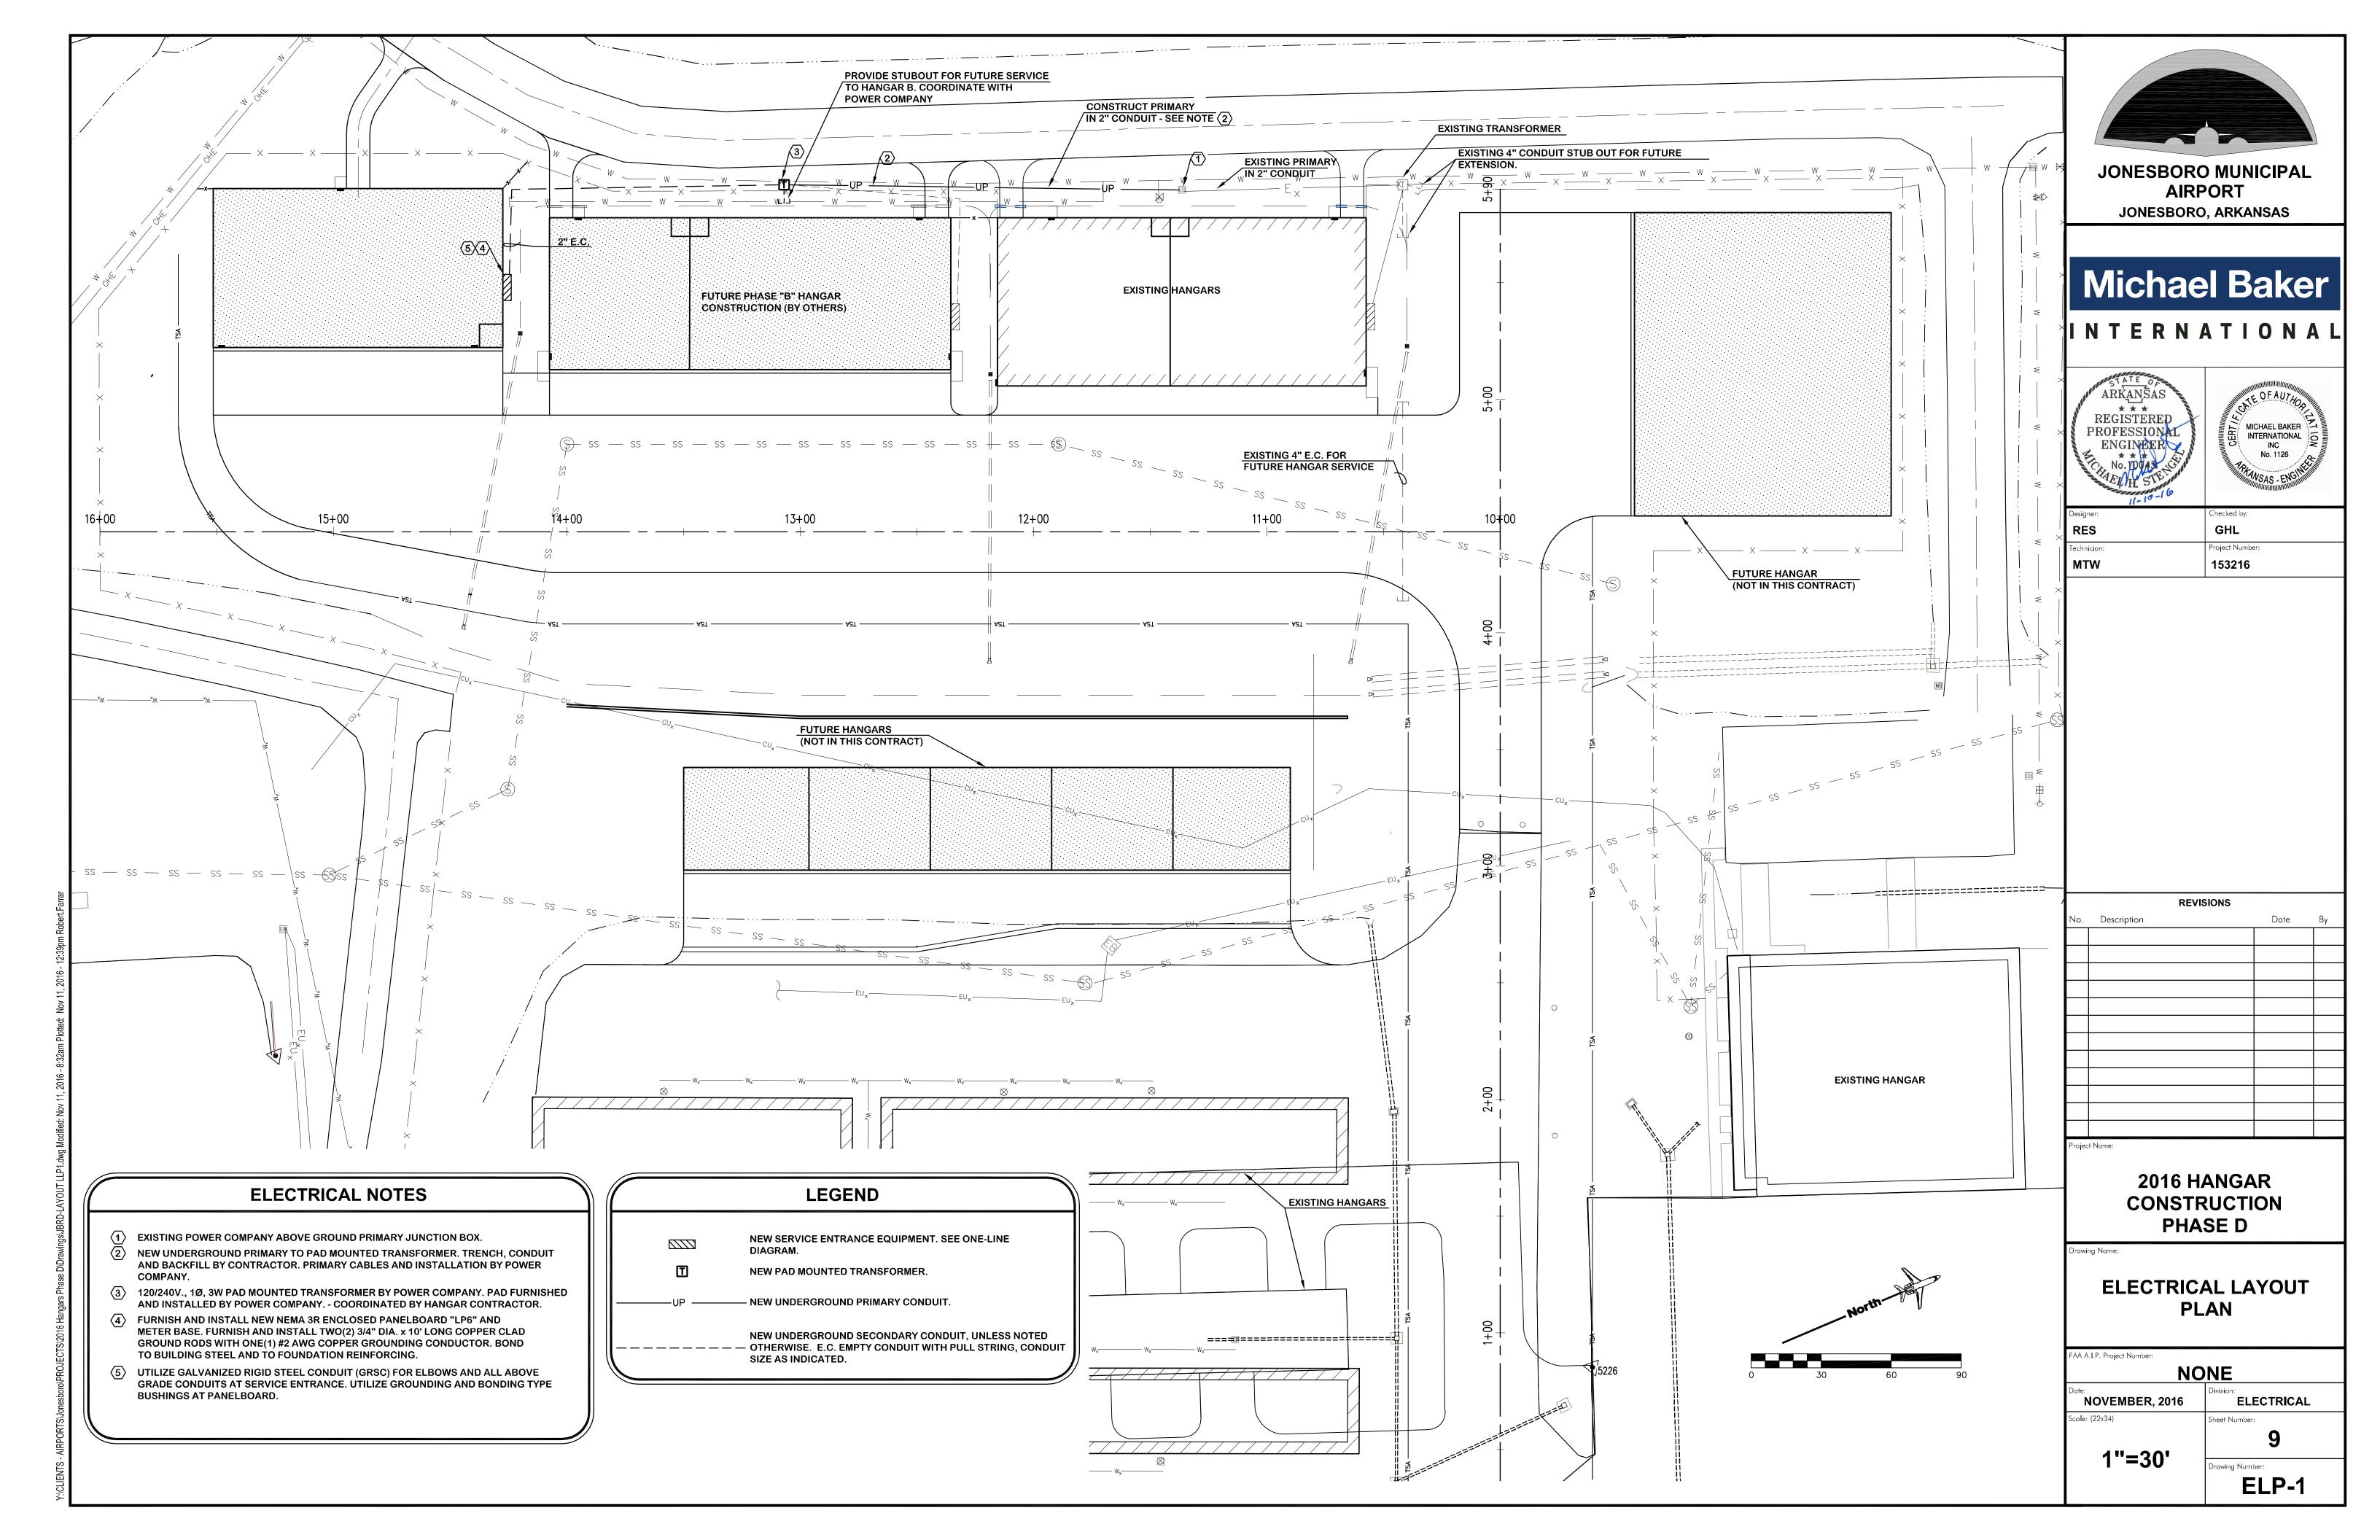

**INSTALLED PER JONESBORO CITY WATER &** 

LIGHT SPECIFICATIONS AND

REQUIREMENTS.

### CONDUIT TRENCH DETAIL IN EARTH -1 WAY FOR HANGAR POWER SECONDARY DISTRIBUTION

N.T.S.

### **DETAIL NOTES:**

- 1. CONTRACTOR SHALL STAKE THE DUCT INSTALLATION IN PLAN AND ELEVATION FOR NEW ELECTRICAL DUCTS TO AVOID EXISTING UTILITIES. STAKING PLAN SHALL BE APPROVED BY OWNER AND ENGINEER PRIOR TO WORK.
- 2. CONTRACTOR SHALL ADJUST THE DEPTH OF THE ELECTRICAL DUCTS AS REQUIRED TO MAINTAIN THE MINIMUM COVER REQUIRED INDICATED AND AVOID EXISTING UTILITIES.
- 3. OFFSETS AND BENDS OVER 10 DEGREES AND ELBOWS IN PVC CONDUIT RUNS SHALL BE SCHEDULE 80 PVC CONDUIT.
- 4. NO PVC SHALL EMERGE FROM THE GROUND OR CONCRETE SLAB OR ENCASEMENT, PVC SHALL CONVERT TO GALVANIZED RIGID STEEL CONDUIT PRIOR TO ITS EMERGENCE.

CAUTION BI

CAUTION BURIED ELECTRICAL LINE BELOW

### GENERAL NOTES

- 1. POWER MARKING TAPES SHALL BE DETECTABLE TYPE CONSTRUCTION WITH ORANGE BACKGROUND AND BLACK LETTERING, AS REQUIRED BY UTILITY COMPANY.
- 2. COMMUNICATIONS MARKING TAPES SHALL BE DETECTABLE TYPE CONSTRUCTION
- OR "FIBER OPTIC LINE" RESPECTIVELY.
- 3. TAPE SHALL BE DETECTABLE, DURABLE, HIGHLY VISIBLE, RESISTANT TO ELEMENTS, MEETING AND/OR EXCEEDING INDUSTRY STANDARDS.


### UNDERGROUND DETECTABLE WARNING TAPE

N.T.S.

### **GENERAL ELECTRICAL NOTES:**

- 1. ELECTRICAL WORK SHALL BE PREFORMED IN ACCORDANCE WITH THE CURRENT ACCEPTED EDITIONS OF THE NFPA 70 NATIONAL ELECTRICAL CODE, NFPA 101 LIFE SAFETY CODE, STATE ELECTRICAL CODE AND LOCAL ELECTRICAL CODE.
- 2. COORDINATE ELECTRICAL POWER SUPPLY WITH EQUIPMENT SUPPLIED.
- 3. ALL AIC RATINGS SHALL BE UL INTEGRATED PANEL RATINGS.
- 4. INSTALL AN EQUIPMENT GROUND GROUNDING CONDUCTOR IN ALL FEEDER AND BRANCH CIRCUITS.
- 5. INSTALL ALL CONDUCTORS AND CABLES IN CONDUIT UNLESS OTHERWISE NOTED.
- 6. INSTALL LUGS AS REQUIRED TO FIT WIRING.
- 7. ALL WIRING SHALL BE COPPER WITH 600 VOLT THHN-THWN-2 INSULATION UNLESS OTHERWISE NOTED.
- 8. MAINTAIN INTEGRITY OF ALL FIRE RATED WALLS DUE TO CONDUIT WALL
- 9. INSTALL TYPED PANEL SCHEDULE IN THE ELECTRICAL PANEL INDICATING WORK PREFORMED.

10.ALL SERVICE AND FEEDER CONDUITS SHALL BE GROUNDED ON BOTH ENDS.

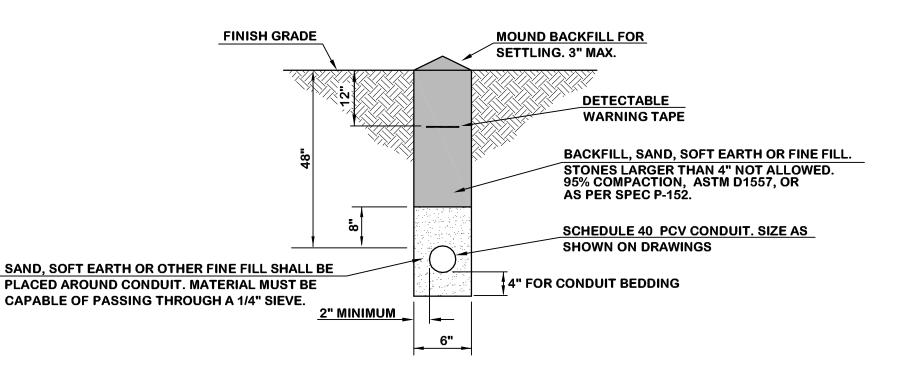

CONDUIT TRENCH DETAIL IN EARTH -1 WAY
FOR HANGAR POWER PRIMARY DISTRIBUTION

N.T.S.

TWO(2) 3/4" x 10'

**GROUND RODS, 20'** 

COPPER CLAD

SPACING

UTILITY PRIMARY NOTE: THE ELECTRICAL UTILITY POINT OF CONTACT IS KAREN MANGUM, PAD MOUNTED TRANSFORMER, JONESBORO CITY WATER AND LIGHT, 240/120V, 1Ø, 3W, SECONDARY (870) 935 - 5581 SECONDARY SERVICE TRENCH AND CONDUIT BY CONTRACTOR, CABLES BY UTILITY METER ON EXTERIOR WALL OF HANGAR, BASE BY CONTRACTOR 3 #3/0 IN A 2" CONDUIT TRANSIENT VOLTAGE SURGE SUPRESSOR, NEMA 4X ENCLOSURE AT 200A/2P SERVICE ENTRANCE. LOCATE AND TVSS CONNECT CONDUCTORS TO BREAKER SUCH THAT THEY ARE AS SHORT AND **42 CIRCUIT PANEL BOARD "LP7"** STRAIGHT AS POSSIBLE. THOR WITH 200A/2P MCB, 10kAIC RATED, SYSTEMS, INC. 240/120V, 1Ø, 3W, UL SERVICE NO.TSnc100WZ2S1P100 OR **ENTRANCE RATED, 20" WIDE NEMA** APPROVED EQUALS. 3R ENCLOSURE, PAD LOCKABLE, **NEUTRAL AND GROUND KITS,** 30A/2P NAMEPLATE "MAIN DISCONNECT. ♥ 240V HANGAR" AND " PANEL BOARD LP7 ". CIRCUIT BREAKERS SHALL BE **BOLT-ON TYPE. SCHNEIDER ELECTRIC "NQ" SERIES OR** APPROVED EQUALS. **EXOTHERMIC WELD** #2 IN 1" PVC

ONE-LINE DIAGRAM

PROPOSED HANGAR LOADS


(THREE BOX HANGARS)



### Michael Baker

JONESBORO, ARKANSAS

INTERNATIONA

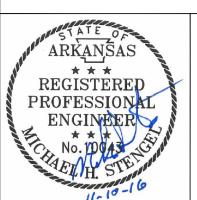



| Designer:   | Checked by:     |
|-------------|-----------------|
| RES         | GHL             |
| Technician: | Project Number: |
| Iмтw        | 153216          |

REVISIONS

No. Description

Date By

Project Name:

2016 HANGAR CONSTRUCTION PHASE D

Drawing Name:


FAA A.I.P. Project Number:

ELECTRICAL DETAILS PLAN

 Date:
 NOVEMBER, 2016
 Division:
 AIRPORTS

 Scale: (22x34)
 Sheet Number:
 10


 Drawing Number:
 ED-1

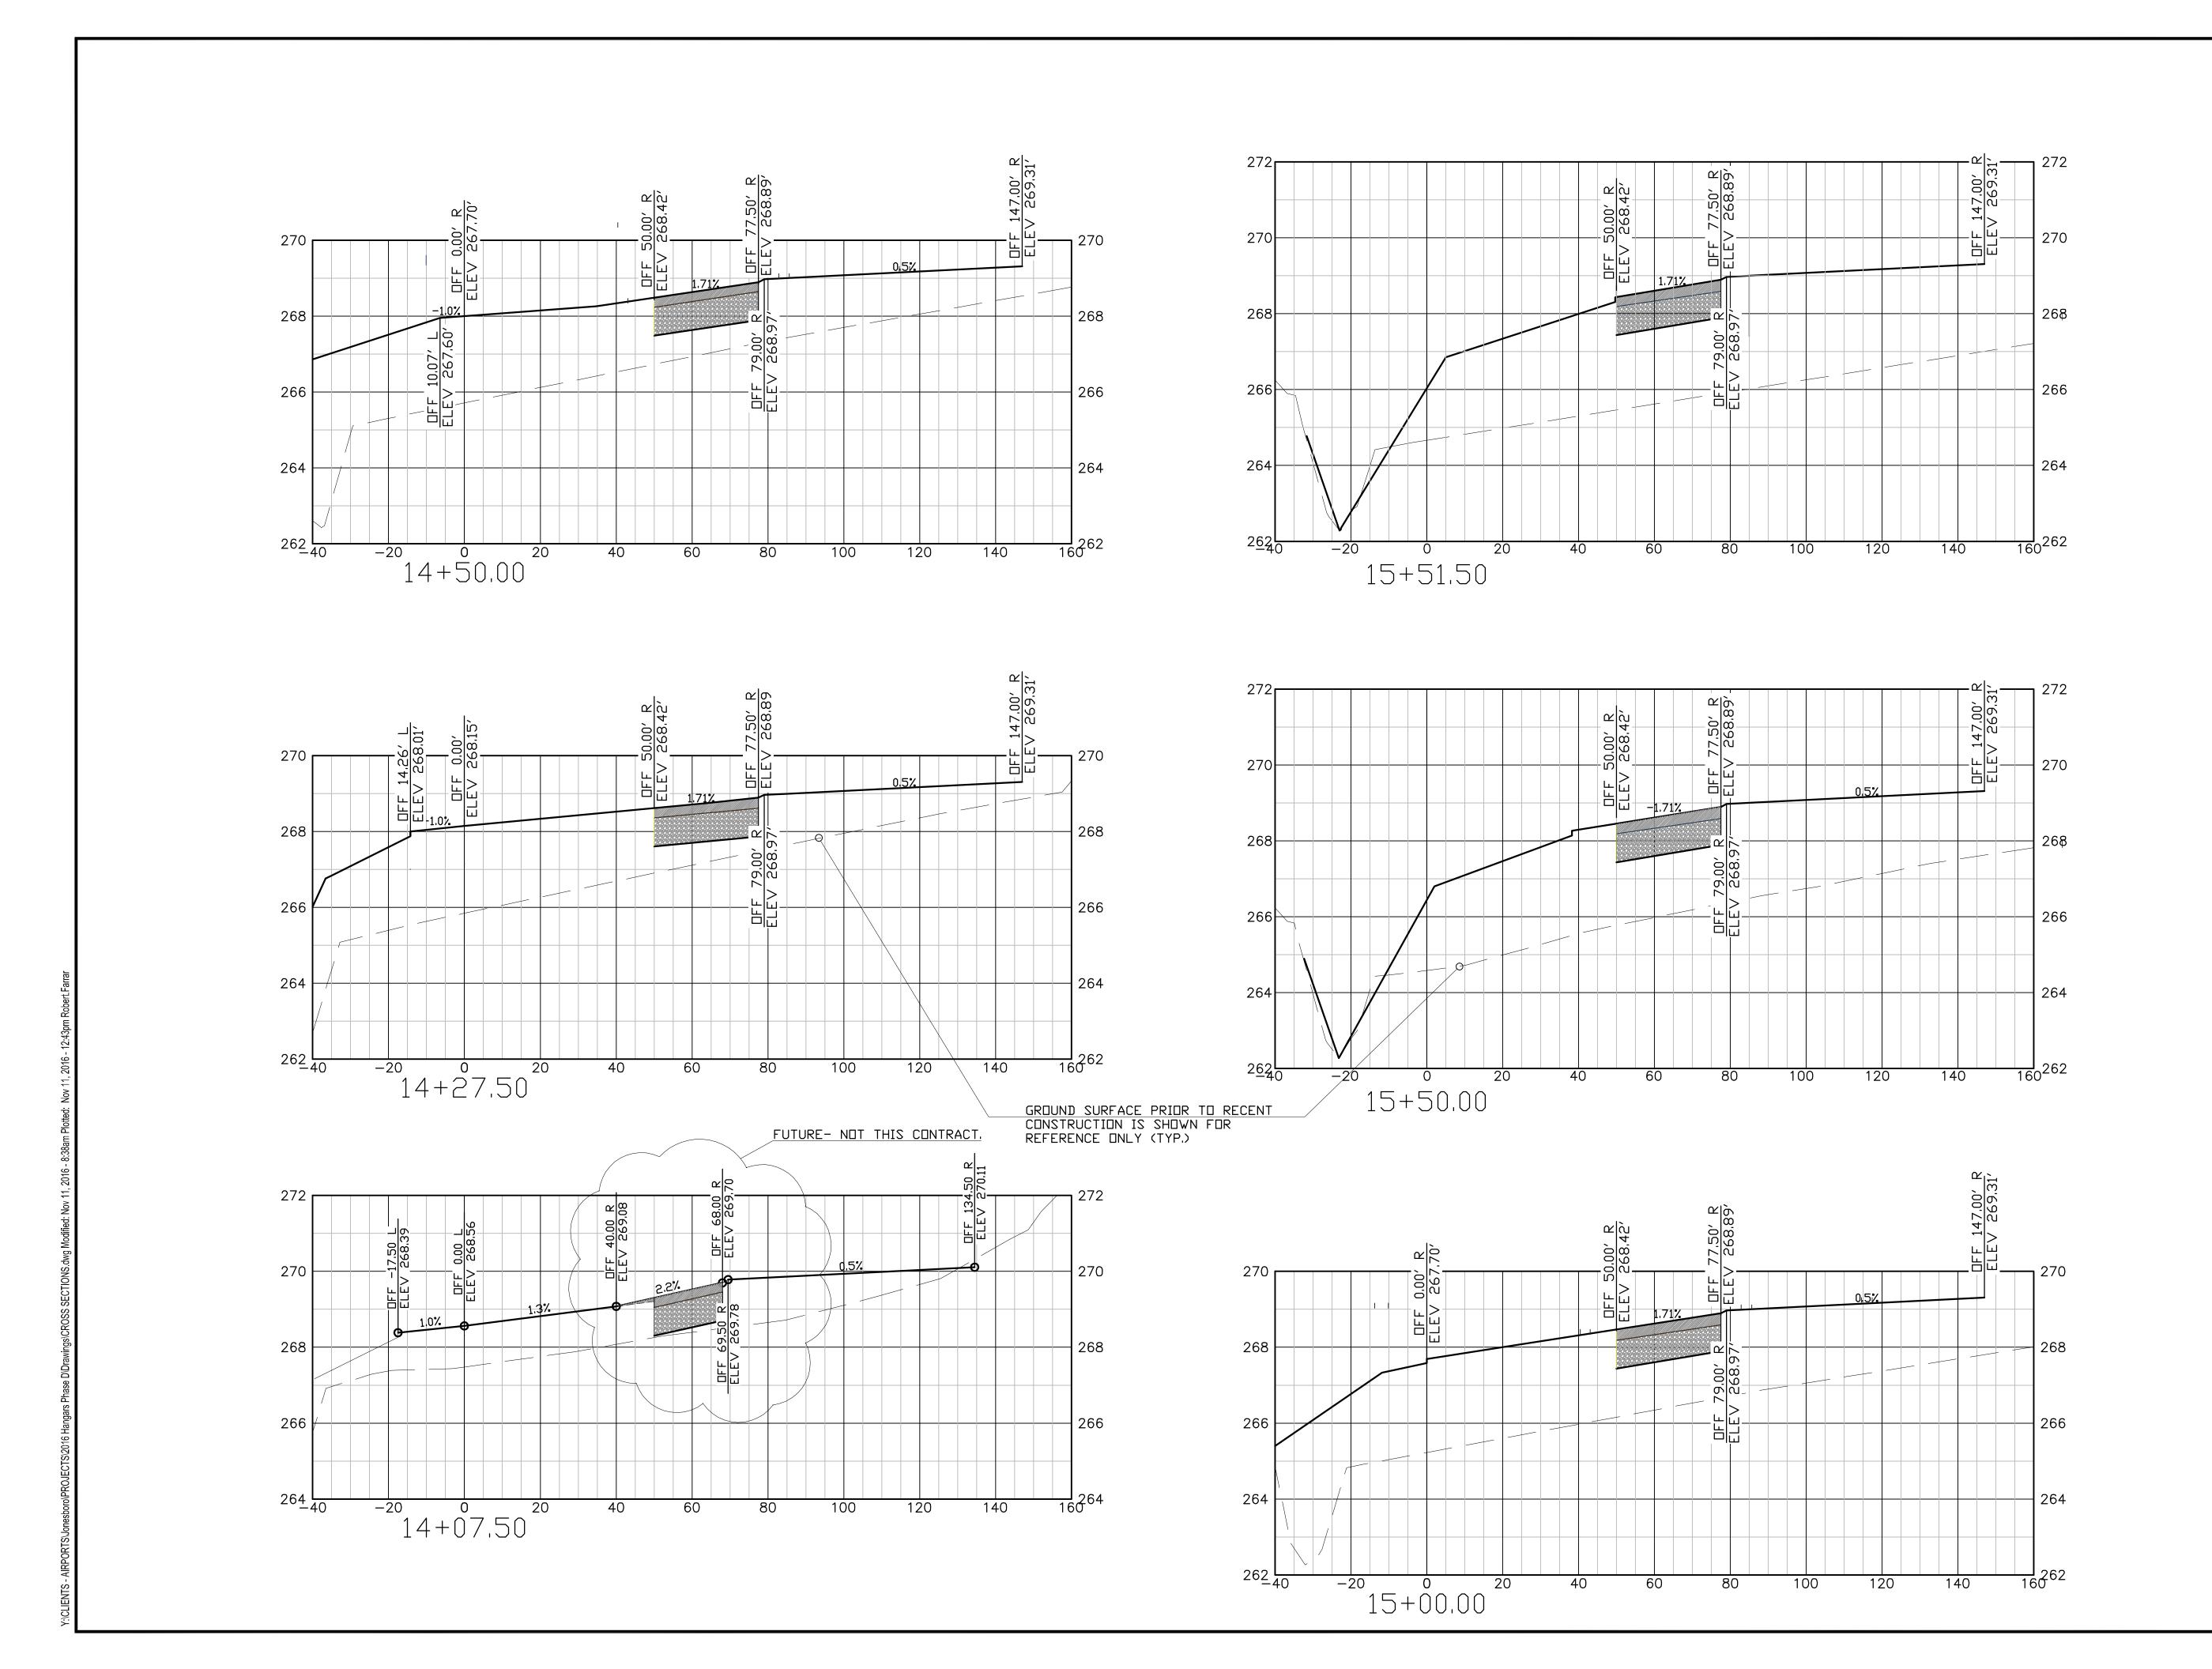



### Michael Baker

INTERNATIONAL

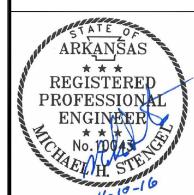



| **          |                 |
|-------------|-----------------|
| Designer:   | Checked by:     |
| MHS         | MHS             |
| Technician: | Project Number: |
| MWW         | 153216          |

NOTE:

CROSS SECTIONS REPRESENT
PERMANENT DEVELOPMENT. SEE
TYPICAL SECTIONS AND LAYOUT PLANS FOR
TEMPORARY GRADING AND DELINEATIONS OF
SITEWORK CONTRACT.

| REVISIONS     |             |      |    |  |
|---------------|-------------|------|----|--|
| No.           | Description | Date | Ву |  |
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|               |             |      |    |  |
| Project Name. |             |      |    |  |

Project Name:

2016 HANGAR CONSTRUCTION PHASE D

Drawing Name:

BASELINE C CROSS SECTIONS

| FAA A.I.P. Project Number: |                     |  |  |
|----------------------------|---------------------|--|--|
| NONE                       |                     |  |  |
| Date: NOVEMBER, 2016       | Division:  AIRPORTS |  |  |
| Scale: (22x34)             | Sheet Number:       |  |  |
| H: 1"=20'                  | 11                  |  |  |
| V: 1"=2'                   | Drawing Number:     |  |  |
|                            | XS-1                |  |  |
|                            |                     |  |  |

