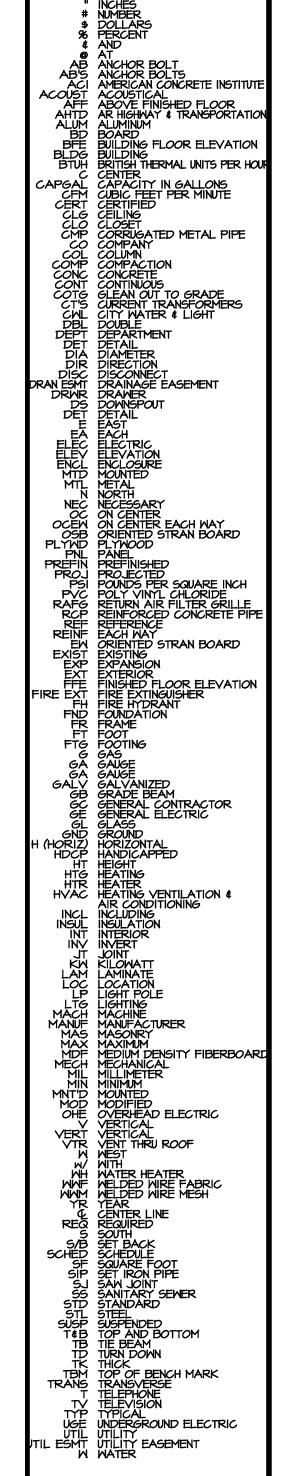


ARKANSAS DEVELOPMENT FINANCE AUTHORITY


A New Multi-Family Elderly Housing Development for:

# Emerald Village

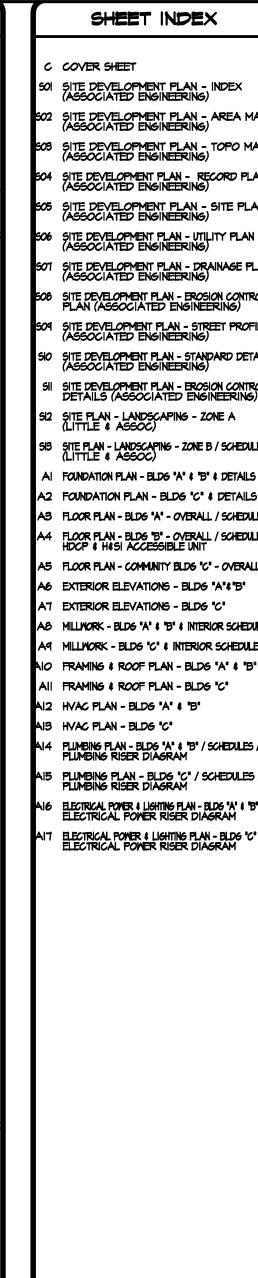1688 Patrick Street • Jonesboro, Arkansas 72401



ABBREVIATIONS





SCHEDULE OF SPECIAL INSPECTIONS

Inspection during the anchorage of other electrical equiparts instead to carry flammable, combustible, or highly toxic contents & their associated mechanical units inspection, during the installation of HVAC ductwork that will contain hazardous materials inspection during the installation of vibration isolation systems

INSPECTION AGENT

Testing Agency

3 Architect
4 Structural Engineer
5 Mechanical Engineer
6 Electrical Engineer
7 Steel Fabricator

1708.5 SEISMIC QUALIFICATION OF MECHANICAL & ELECTRICAL EQUIPMENT
Review certificate of compliance for designated 
certificate of compliance review 
seismic system components

LITTLE & ASSOCIATES

and/or testing agencis are subject to the approval of the Building Official and/or the Design Professional

This project requires minimum special inspections. Architect will inspect UL components of the framing to ensure design by our plans are followed. Images along with an Feld Report will be produced and filed.

2. The list of Special inspectors may be submitted as a separate document if noted so above

Are Requirements for Seismic Resistance included in the Statement of Special Inspections? Are Requirements for Mind Resistance included in the Statement of Special Inspections?

Encircle "Yes" or "No" as appropriate and date below:

Statement of Special Inspections

I. The inspection & testing agent(s) shall be engaged by the Owner or the Owner's Agent, and not by the Contractor or Subcontractor whose work is to be inspected or tested. Any conflict of interest must be disclosed to the Building Official prior to commencing work. The qualifications of the Special Inspector(

CNI / MEDIC ONE ADDITION

Review submittals

Field review
Field testing & review of laboratory reports

APPLICABLE TO THIS PROJECT

Y / N EXTENT AGENT DATE COMPLETE

Periodic
Periodic
Periodic

Periodic 2,3
Periodic 2,3,4
Periodic 2,3,4
Periodic 2,3,4

Periodic 8

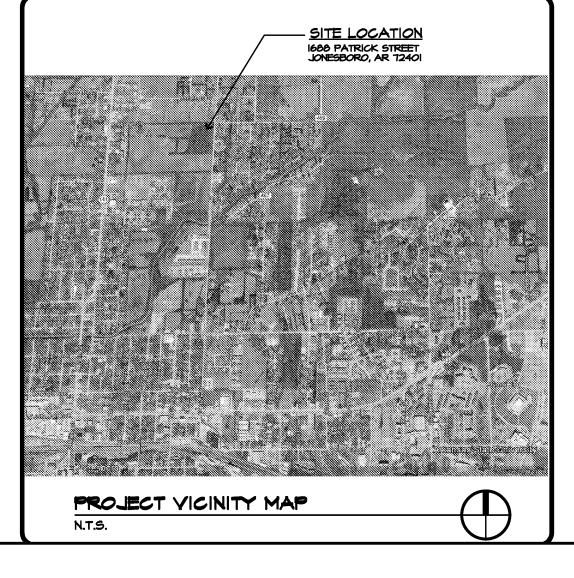
Periodic 2,3
Periodic 2,3

Periodic


Each Submittal 3,4

Periodic

Arkansas One-Call Dial 811 or 800-482-8998 www.arkonecall.com





PROJECT AREA:					
2 BR LIVING UNIT'S - (40) UNIT FLOOR AREA	1,157 sq.ft. (NET) 1,627 sq.ft. (GROSS)				
2 BR HDCP LIVING UNIT'S - (3) UNIT FLOOR AREA	1,157 sq.ft. (NET) 1,627 sq.ft. (GROSS)				
2 BR H&SI LIVING UNIT'S - (I) UNIT FLOOR AREA	1,157 sq.ft. (NET) 1,627 sq.ft. (GROSS)				
OFFICE / COMMUNITY UNIT - FLOOR AREA	875 sq.ft. (NET) I,II8 sq.ft. (GROSS)				
TOTAL PROJECT FLOOR AREA	49,469 sq.ft. (NET) 72,706 sq.ft. (GROSS)				
PARKING INFORMATION:	12,100 34.11. (01033)				
REQUIRED PARKING:					
STANDARD SPACES A.D.A ACCESSIBLE SPACES	(TT) SPACES (4) SPACES				
TOTAL REQUIRED SPACES	(BI) SPACES				
ACTUAL PARKING:					
STANDARD SPACES A.D.A ACCESSIBLE SPACES	(97) SPACES (4) SPACES				
TOTAL ACTUAL SPACES	(IOI) SPACES (EXCEEDS MIN. REQ'd)				

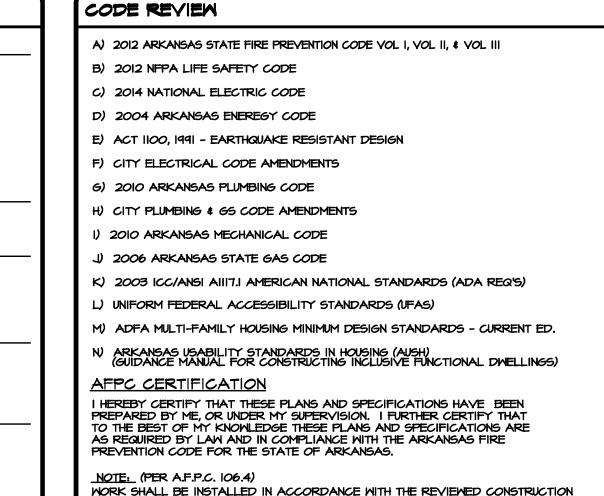

DOCUMENTS AND ANY CHANGES MADE DIRING CONSTRUCTION THAT ARE NOT

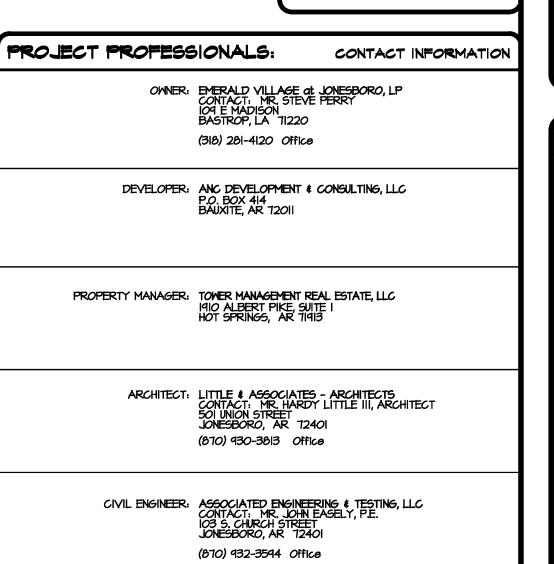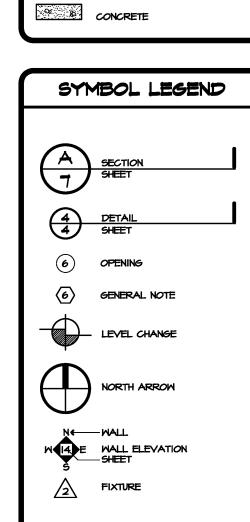IN COMPLIANCE WITH THE APPROVED CONSTRUCTION DOCUMENTS SHALL BE RESUBMITTED FOR APPROVAL AND AMENDED TO THIS SET OF CONSTRUCTION DOCUMENTS





MATERIAL LEGEND

WOOD (FINISH OR STUD WALL)

INSULATION (RIGID)

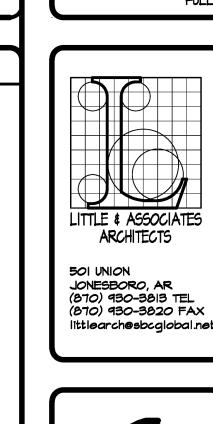
GYP. BOARD OR PLASTER

MASONRY BLOCK

WOOD (BLOCKING)


INSULATION (BATT)


METAL STUDS



DATE : 6/20/16 FILE: 47110CVR.dng

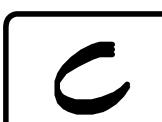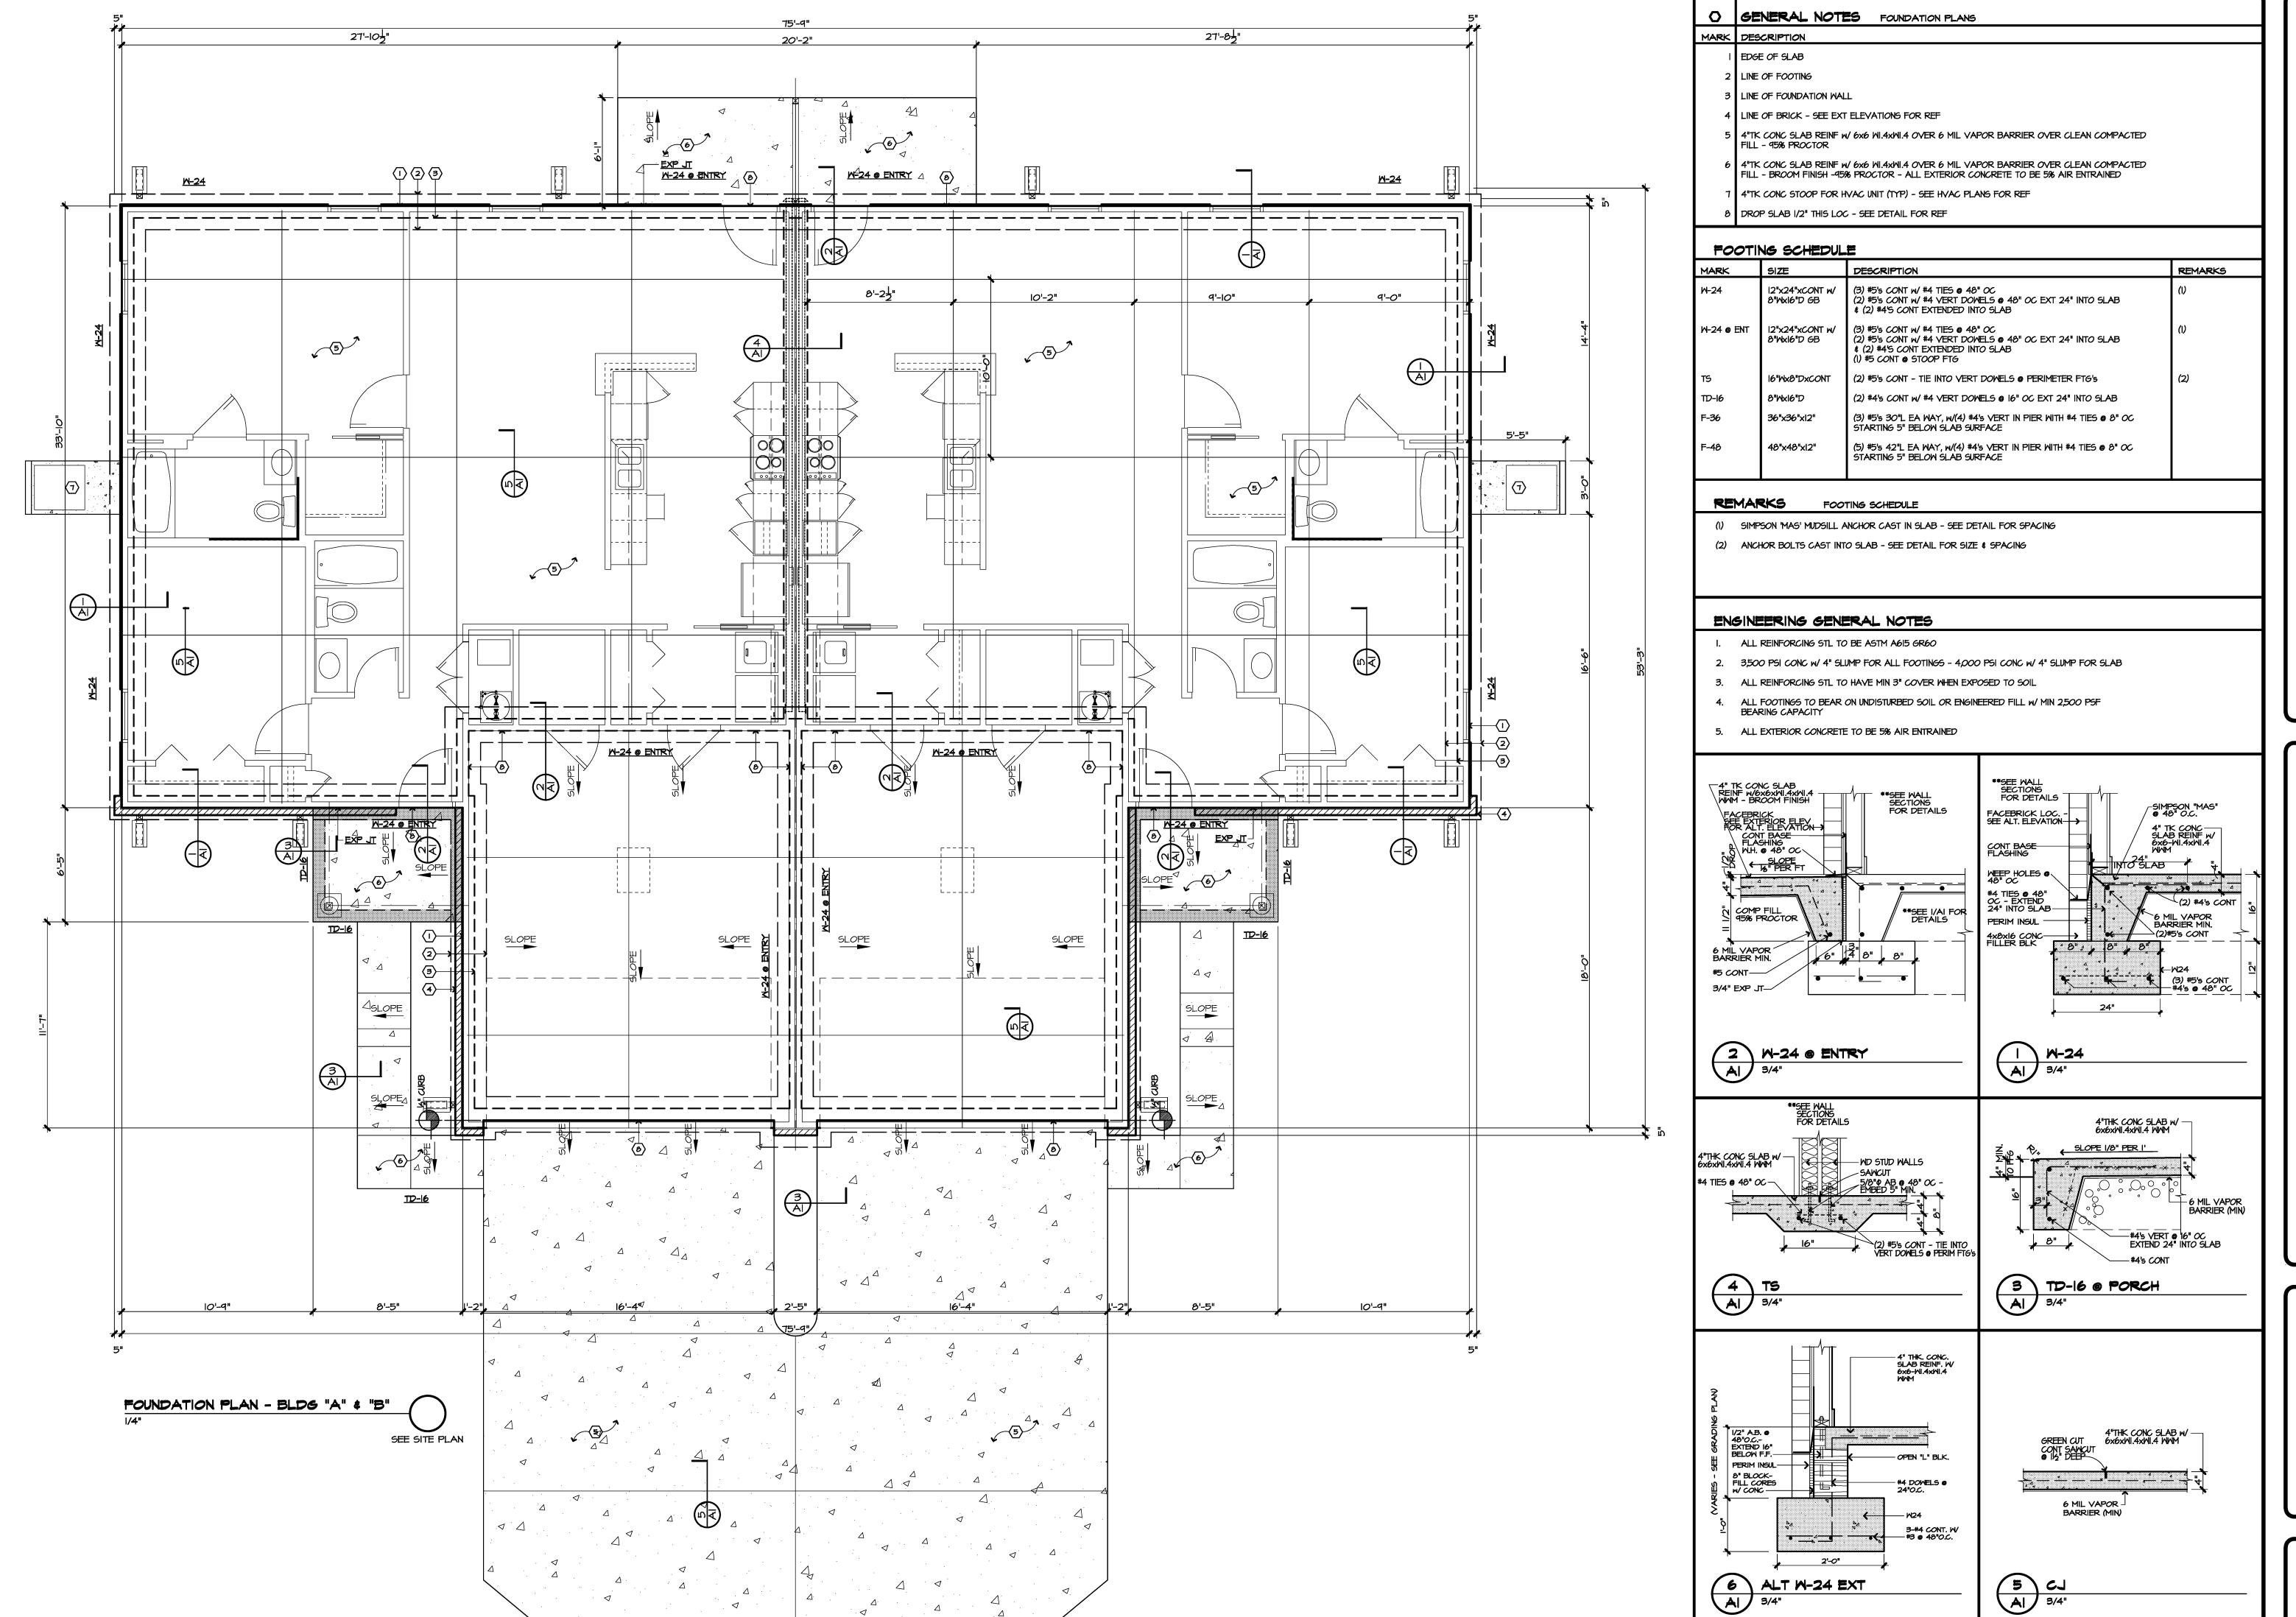PLOT:





IDATION PLAN - BLD6 "A" & "B" & DETAILS

LITTLE & ASSOCIATES
ARCHITECTS

SOI UNION
JONESBORO, AR
(870) 930-3813 TEL
(870) 930-3820 FAX
Ittleges basis global nat

(870) 930-3820 FAX littlearch@sbcglobal.net

FOUNDATION PLAN - BLDG "C"

1/4"

SEE SITE PLAN

O GENERAL NOTES FOUNDATION PLANS

MARK DESCRIPTION

I EDGE OF SLAB

2 LINE OF FOOTING

3 LINE OF FOUNDATION WALL4 LINE OF BRICK - SEE EXT ELEVATIONS FOR REF

5 4"TK CONC SLAB REINF W/ 6x6 WI.4xWI.4 OVER 6 MIL VAPOR BARRIER OVER CLEAN COMPACTED FILL - 95% PROCTOR

6 4"TK CONC SLAB REINF W/ 6x6 WI.4xWI.4 OVER 6 MIL VAPOR BARRIER OVER CLEAN COMPACTED FILL - BROOM FINISH -95% PROCTOR - ALL EXTERIOR CONCRETE TO BE 5% AIR ENTRAINED

7 4"TK CONC STOOP FOR HVAC UNIT (TYP) - SEE HVAC PLANS FOR REF

8 DROP SLAB 1/2" THIS LOC - SEE DETAIL FOR REF

FOOTING SCHEDULE


SIZE	DESCRIPTION	REMARKS
12"x24"xCONT w/ 8"Wx16"D GB	(3) #5'5 CONT W/ #4 TIES @ 48" OC (2) #5'5 CONT W/ #4 VERT DOWELS @ 48" OC EXT 24" INTO SLAB \$ (2) #4'5 CONT EXTENDED INTO SLAB	(i)
12"x24"xCONT w/ 8"Mx16"D GB	(3) #5's CONT w/ #4 TIES ● 48" OC (2) #5's CONT w/ #4 VERT DOWELS ● 48" OC EXT 24" INTO SLAB \$ (2) #4'S CONT EXTENDED INTO SLAB (I) #5 CONT ● STOOP FTG	W
16"Mx8"DxCONT	(2) #5's CONT - TIE INTO VERT DOWELS @ PERIMETER FTG's	(2)
8"Mx16"D	(2) #4'5 CONT W/ #4 VERT DOWELS @ 16" OC EXT 24" INTO SLAB	
32"x32"x 2"	(3) #5's 30"L EA WAY, w/(4) #4's VERT IN PIER WITH #4 TIES @ 8" OC STARTING 5" BELOW SLAB SURFACE	
	2"x24"xcont w/ 8"Wxl6"D 6B  2"x24"xcont w/ 8"Wxl6"D 6B  6"Wx8"Dxcont 8"Wxl6"D	12"x24"xCONT w/


### REMARKS FOOTING SCHEDULE

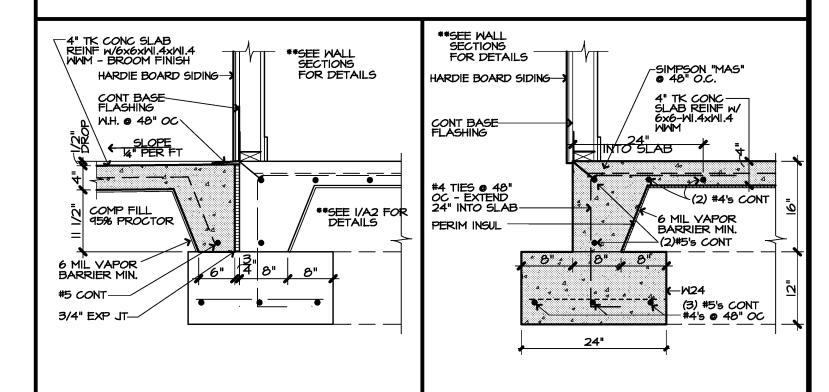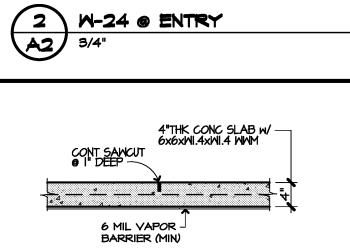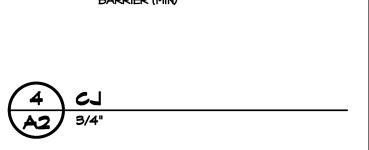
- (I) SIMPSON 'MAS' MUDSILL ANCHOR CAST IN SLAB SEE DETAIL FOR SPACING
- (2) ANCHOR BOLTS CAST INTO SLAB SEE DETAIL FOR SIZE & SPACING

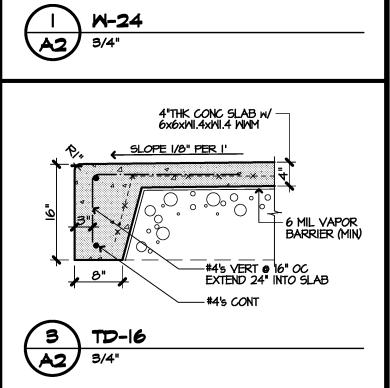
# Engineering general notes

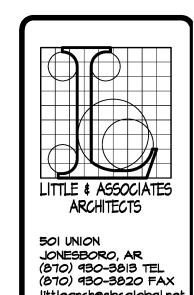
- I. ALL REINFORCING STL TO BE ASTM A615 GR60
- 2. 3,500 PSI CONC W/ 4" SLUMP FOR ALL FOOTINGS 4,000 PSI CONC W/ 4" SLUMP FOR SLAB
- 3. ALL REINFORCING STL TO HAVE MIN 3" COVER WHEN EXPOSED TO SOIL
- 4. ALL FOOTINGS TO BEAR ON UNDISTURBED SOIL OR ENGINEERED FILL W/ MIN 2,500 PSF BEARING CAPACITY
- 5. ALL EXTERIOR CONCRETE TO BE 5% AIR ENTRAINED











COMM. NO.: 6|4|5 DATE : 6/20/|6 FILE:

(870) 930-3820 FAX littlearch@sbcglobal.net





O GENERAL NOTES FLOOR PLANS

- ADA ACCESSIBLE 36" W (34" MIN. CLEAR) METAL CLAD INSULATED EXTERIOR DOOR UNIT W/ DOUBLE PEEP HOLE'S -
- 2. DEADBOLT LOCK W/ INTERIOR THUMB LATCH DOOR HARDWARE TYPICAL AT ALL UNIT'S
- ADA ACCESSIBLE 36" W (34" MIN. CLEAR) INTERIOR DOOR UNIT TYPICAL AT ALL UNIT'S
- "NO" SLIDING GLASS DOOR'S ARE BEING INSTALLED IN THIS PROJECT
- ARCHITECTURAL ROOFING SHINGLES, ANTI-FUNGAL, 30-YR WARRANTY, USE 151b. ROOF FELT UNDER TYPICAL AT ALL BLDG'S
- 6 5" "SEAMLESS" PRE-FINISHED CONTINUOUS METAL GUTTER SYSTEM AT ENTIRE ROOF PERIMETER (EXLUDING GABLE'S) -
- 2"D x 3"W PRE-FINISHED METAL DOWNSPOUT'S TYPICAL AT ALL BLDG'S
- 8. SPLASH BLOCKS AT ALL DOWNSPOUT'S TYPICAL AT ALL BLDG'S
- VINYL ROOF GABLE VENT TYPICAL AT ALL BLDG'S
- COVERED CONCRETE ENTRY PAD w/ MIN. SLOPE OF 1/4" PER FOOT PROVIDED FOR ALL UNIT'S
- COVERED ENTRY & CEILING & WALL COMPONENT'S ARE NON-COMBUSTIBLE MATERIAL'S TYPICAL AT ALL BLDG'S
- EXTERIOR VINYL SHUTTER'S AT EA SIDE OF ALL FRONT WINDOW OPENING'S WITH VINYL SIDING SEE EXTERIOR ELEVATIONS
- MALL MOUNTED EXTERIOR LIGHT FIXTURE W/ C.F.L. BULB'S AT ALL ENTRY/EXIT DOOR'S TYPICAL AT ALL BLDG'S
- PROVIDE HOUSING DEVELOPMENT SIGN W/ FAIR HOUSING LOGO AT THE MAIN ENTRANCE OF THE DEVELOPMENT
- EQUIP EACH UNIT WITH READILY ACCESSIBLE DRY CHEMICAL FIRE EXTINGUISHER TYPICAL AT ALL UNIT'S
- ALL BASE CABINET'S SHALL HAVE DUAL SIDETRACK DRAWER'S TYPICAL AT ALL UNIT'S
- 2'-0" x 2'-0" PANTRY CABINET w/ (5) PULL-OUT DRAWER's TYPICAL AT ALL UNIT's (EXCEED's MIN. REQ.)
- 30"x60" PRE-MANUFACTURED FIBERGLASS TUB/SHOWER UNIT TYPICAL AT ALL NON-HDCP UNIT'S SHEETROCK TO BE INSTALLED BEHIND UNIT
- ADA ACCESSIBLE 34"x60" PRE-MANUFACTURED "ROLL-IN" SHOWER UNIT COMPLETE W/ ALL ADA REQ'd ACCESSORIE'S -TYPICAL AT ALL "LEVEL-5" HDCP UNIT'S - SHEETROCK TO BE INSTALLED BEHIND THE UNIT
- ALL HALLWAY'S ARE 4'-6" (54") WIDE MIN. TYPICAL AT ALL UNIT'S (EXCEED'S MIN. REQ.)
- PROVIDE ENERGY STAR RATED CEILING FAN W/ LIGHT KIT IN ALL BEDROOM'S & LIVING ROOM'S TYPICAL AT ALL UNIT'S
- INSTALL AIR HANDLER AT MAIN FLOOR LEVEL ON WOOD MECH PLATFORM, CONNECT CONDENSATE DRAIN TO PLUMBING WASTE & FULLY INSULATE THE ENTIRE CLOSET SPACE WHERE AIR HANDLER IS LOCATED - TYPICAL AT ALL UNIT'S
- 23. 40 GALLON ELECTRIC WATER HEATER W/ 0.42 E.F. RATING, INSTALLED AT MAIN FLOOR LEVEL W/ DRAIN PAN -TYPICAL AT ALL UNIT'S
- ALL HVAC REFRIGERATION LINE'S SHALL BE INSULATED TYPICAL AT ALL UNIT'S
- INSTALL A HARD-WIRED SMOKE DETECTOR W/ BATTERY BACK-UP AT HALLWAY & IN EVERY BEDROOM NEAR THE DOOR UNIT - TYPICAL AT ALL UNIT'S
- 26. INSULATE ALL MATER PIPING (HOT & COLD) LOCATED IN EXTERIOR WALL'S TYPICAL AT ALL BLDG'S
- ENERGY EFFICIENT FLUORESCENT LIGHT FIXTURE'S IN KITCHEN, BATH'S & UTILITY SPACE'S- TYPICAL AT ALL UNIT'S & OFFICE/COMM.
- 3 1/2"TK BLOWN CELLULOSE EXTERIOR WALL INSULATION (R-16 RATING) ALL EXTERIOR WALLS, GARAGE WALLS, MECHANICAL ROOM WALLS, & STORAGE ROOM WALLS - TYPICAL AT ALL BLDG'S
- BLOWN CELLULOSE ATTIC INSULATION (R-38 RATING) INCL. ABOVE GARAGE & STORAGE ROOM TYPICAL AT ALL BLDG'S
- INSTALL EXTERIOR HOUSE WRAP AT ALL EXTERIOR WALL'S TYPICAL AT ALL BLDG'S
- MTL GRAB BARS W/ SOLID BLK'G IN WALLS PER ADA FIG #29 BLK'G TO BE INSTALLED IN ALL UNITS
- MTL TOWEL BARS W/ SOLID BLK'G IN WALLS TO BE INSTALLED IN ALL BATHROOMS
- DOORBELL/CHIME KIT TO BE PROVIDED FOR ALL UNITS
- PROVIDE 2.5 G.P.M. OR LESS BATHROOM & KITCHEN FAUCETS TYPICAL AT ALL UNIT'S

# ADVANCED ENERGY FEATURE'S:

- PROVIDE 2.5 G.P.M. OR LESS SHOWER HEAD'S ANTI-SCALD VALVES TYPICAL AT ALL UNIT'S
  - PROVIDE 3/4"TK INSULATION ON ALL HOT WATER PIPE'S ABOVE SLAB TYPICAL AT ALL UNIT'S
- MIN. FOUNDATION INSULATION TO BE R-3 OR GREATER TYPICAL AT ALL UNIT'S
- ELECTRIC HEAT PUMP SYSTEM w/ 7.8 HSPF RATING & 15 SEER RATING TYPICAL AT ALL UNIT'S (EXCEED'S MIN. REQ.)
- ALL EXTERIOR WINDOW'S SHALL MEET OR EXCEED THE FOLLOWING CRITERIA: (TYPICAL AT ALL BLDG'S)
- FRAME'S & SASH CONSTRUCTED OF EXTRUDED VINYL
- (2) OR MORE PANE'S OF ARGON GAS FILLED INSULATED GLASS W/ AT LEAST PANE W/ LOW-E COATING - U-FACTOR RATING OF 0.30 (EXCEED'S MIN REQ.)
- SOLAR HEAT GAIN COEFFICIENT (SHGC) RATING OF 0.30 (EXCEED'S MIN. REQ.)

# UNIVERSAL DESIGN REQUIREMENT'S:

- SEVEN PERCENT (1%) OF ALL UNIT'S COMPLY W/ THE LEVEL-5 DESIGN CRITERIA TOTALING (3) UNIT'S FOR THIS PROJECT
- ALL UNIT'S COMPLY W/ THE DESIGN CRITERIA IN THE "AUSH" MANUAL
- ALL UNIT'S HAVE "CLOSED-FIST" OPERABILITY THROUGHOUT THE ENTIRE UNIT INCLUDING THE FOLLOWING: \* SINGLE HANDLE DOOR LEVER'S VS. DOORKNOB'S
- \*\* PUSH STICK LIGHTING AND ENVIROMENTAL CONTROL'S
- \*\*\* CABINET DOOR'S CAN BE OPENED W/ A CLOSED FIST \*\*\*\* SINGLE HANDLE FAUCET'S IN ALL BATHROOM'S & KITCHEN'S
- ALL UNIT'S HAVE ENVIRONMENTAL CONTROL'S W/ VISUAL & TACTILE CUE'S INCLUDING "ROCKER" TYPE SWITCHE'S & DIGITAL PROGRAMMABLE THERMOSTAT'S W/ RAISED BUTTON'S - ALL (3) UNIT'S HAVE FLASHING DOORBELL ALARM FOR HS&I

# DEVELOPMENT AMENITY LIST & DESCRIPTION'S: (ALL EQUIPMENT & APPLIANCE'S ENERGY STAR RATED)

- KITCHEN APPLIANCE'S AS FOLLOW'S: ABOVE-THE-RANGE MICROWAVE OVEN, DISHWASHER, GARBAGE DISPOSAL, & SIDE-BY-SIDE REFRIGERATOR W/ICE MAKER - ALL ENERGY STAR QUALIFIED OR EQUIVALENT
- 42. INDIVIDUAL STORAGE UNIT'S FOR ALL RESIDENT'S
- INDIVIDUAL PATIO AREA FOR ALL RESIDENT'S
- EXERCISE ROOM W/ EQUIPMENT FOR USE TO ALL RESIDENT'S THIS CONTRACT
- COMPUTER LAB WITH 4-IN-I PRINTER FOR USE TO ALL RESIDENT'S
- COMMUNITY SPACE ON SITE FLAT SCREEN T.V. W/ DVD PLAYER THIS CONTRACT
- COVERED PORCH AREA ATTACHED TO COMMUNITY BLDG FOR USE TO ALL RESIDENT'S
- PICNIC AREA W/ PICNIC TABLES FOR USE TO ALL RESIDENT'S
- TWO BARBECUE GRILLS FOR USE TO ALL RESIDENT'S LOCATED AT PAVILION / PICNIC AREA WASHER'S & DRYER'S FURNISHED IN ALL UNIT'S AT NO COST TO THE RESIDENT - THRU WALL MTL DRYER VENT W/ PEST FREE CAP
- PRIVACY FENCING RUNNING ALONG THREE SIDES OF PROPERTY BOUNDARY LINE
- 53. DECORATIVE FENCING RUNNING ALONG THE FRONT PROPERTY BOUNDARY LINE

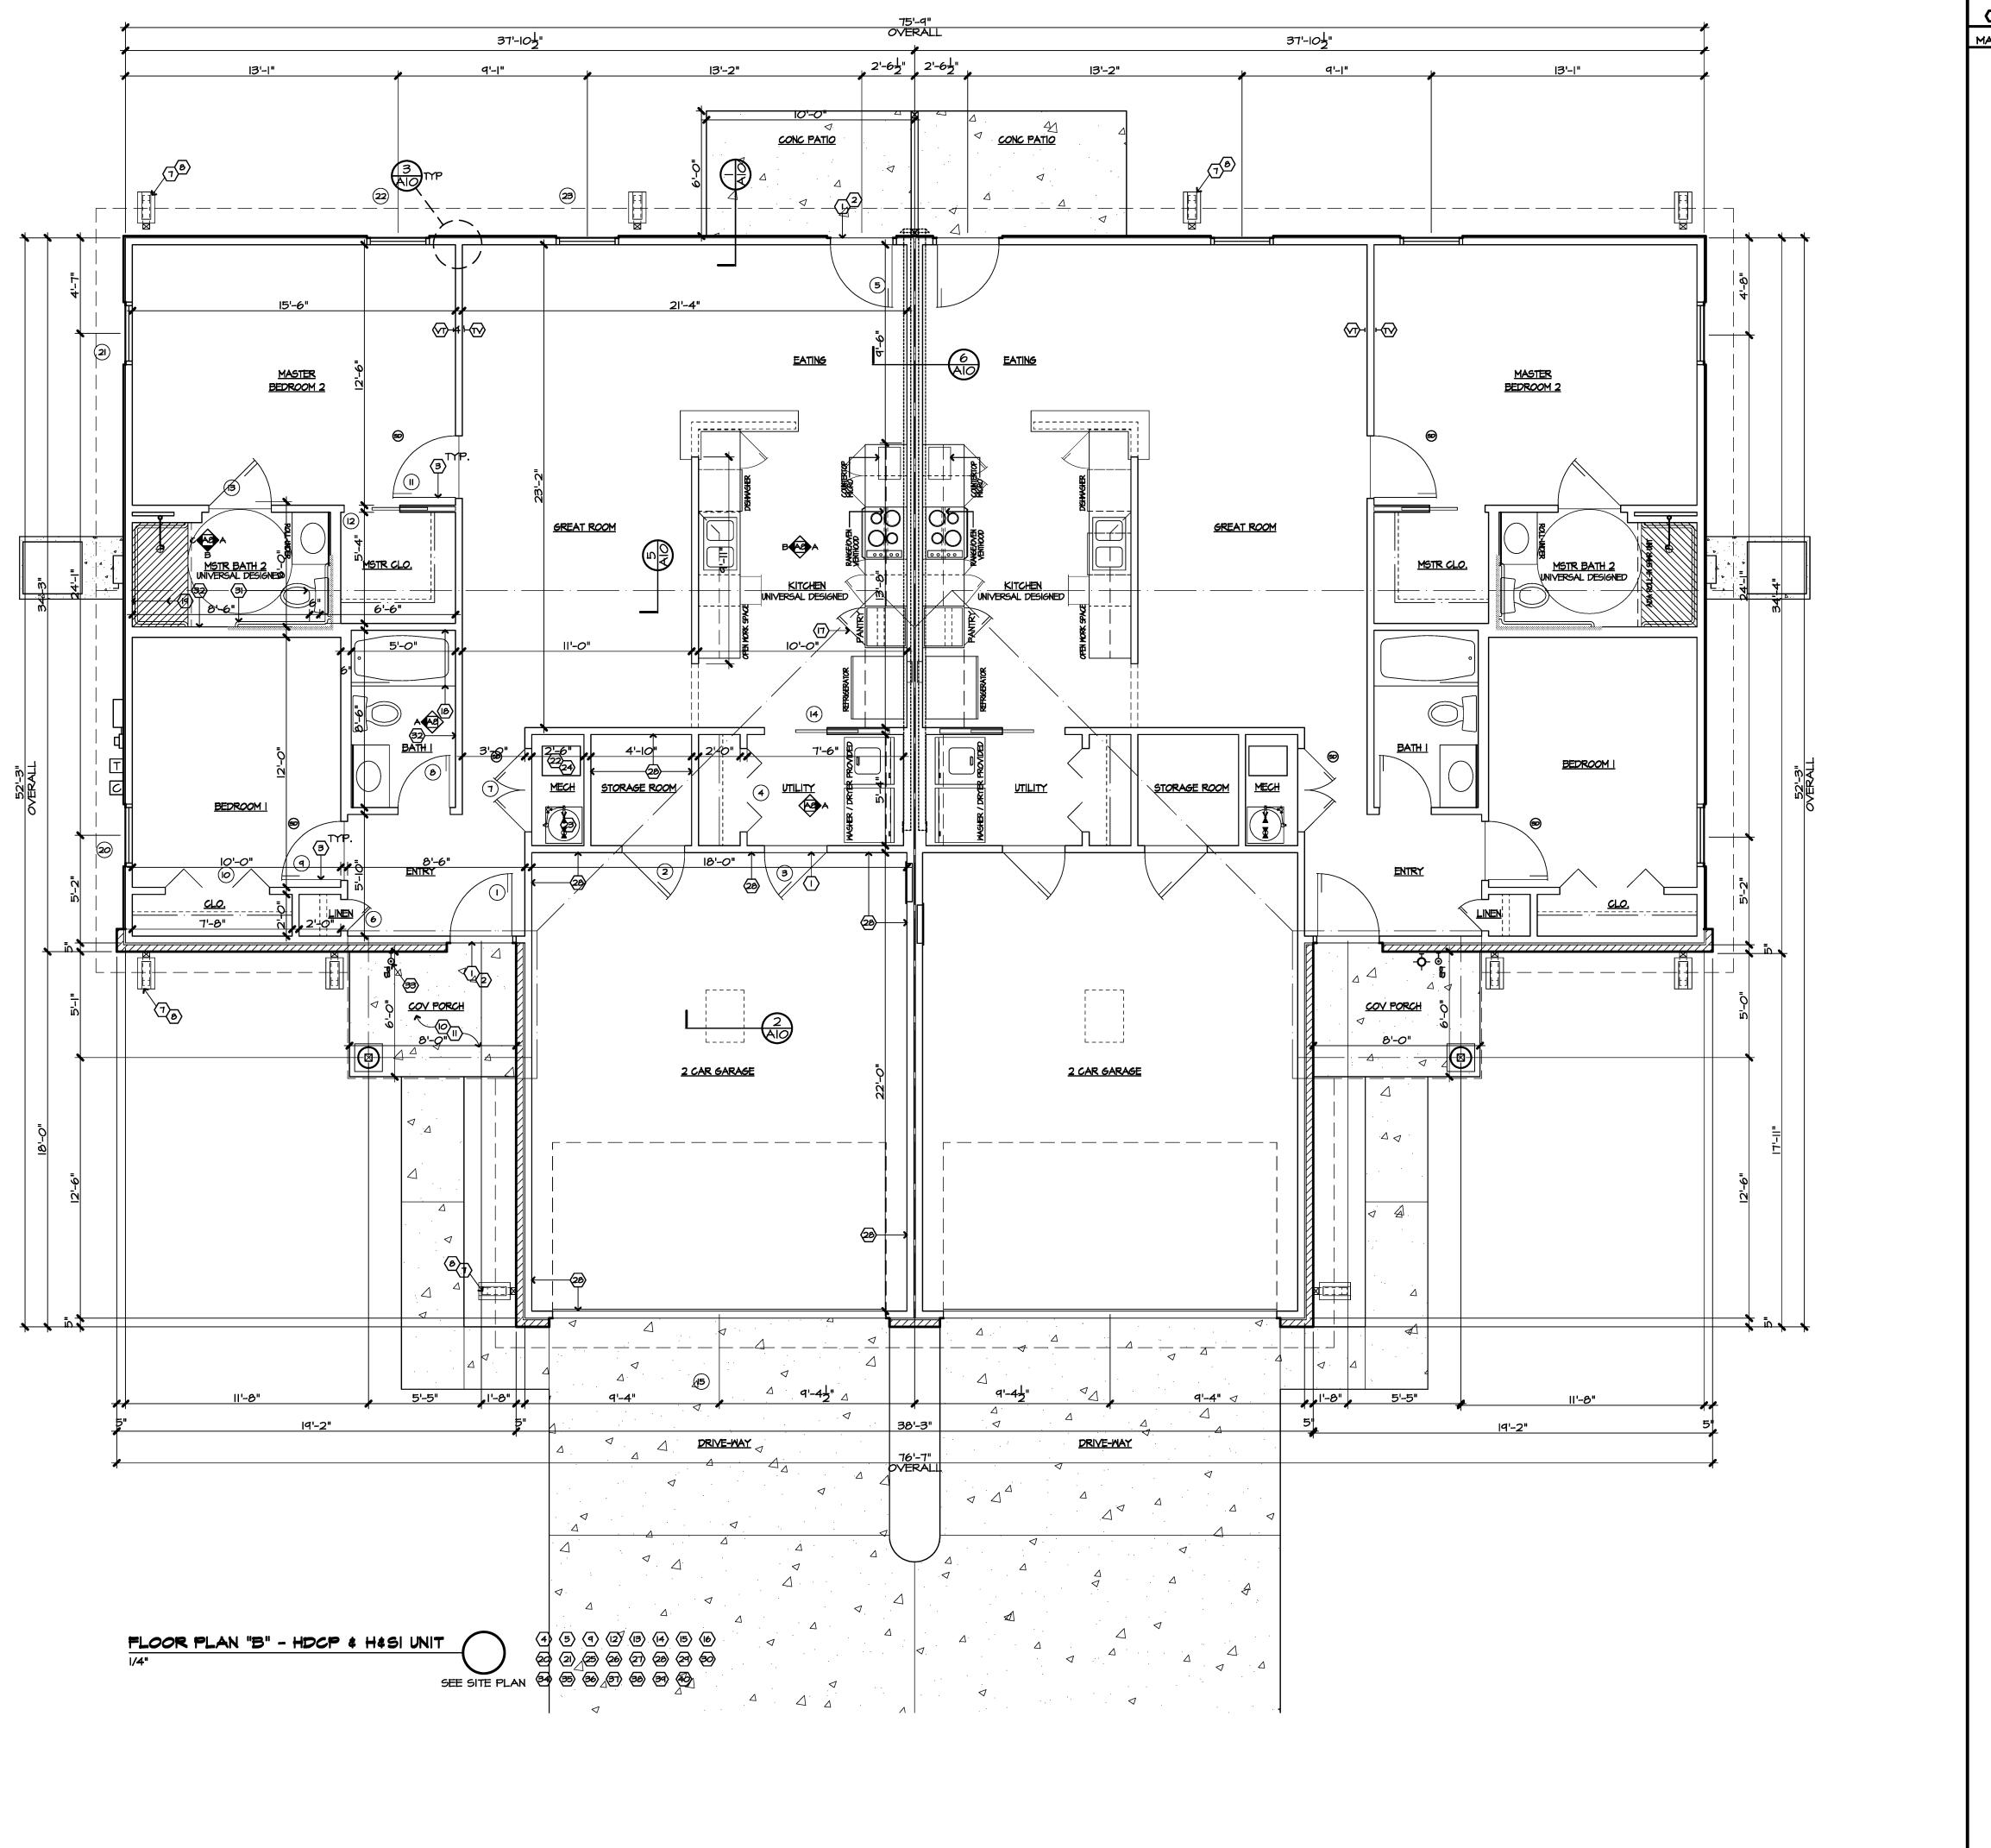
- FENCED COMMUNITY GARDEN AREA



ITTLE & ASSOCIATES



DATE : 6/20/16



O GENERAL NOTES FLOOR PLANS

MARK DESCRIPTION

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- 8. SPLASH BLOCKS AT ALL DOWNSPOUT'S TYPICAL AT ALL BLDG'S

(5'x5' MIN. DESIGN STD.) - TYPICAL AT ALL BLDG'S (EXCEED'S MIN. REQ.)

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- COVERED CONCRETE ENTRY PAD w/ MIN. SLOPE OF 1/4" PER FOOT PROVIDED FOR ALL UNIT'S
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- \*\*\*\* SINGLE HANDLE FAUCET'S IN ALL BATHROOM'S & KITCHEN'S - ALL UNIT'S HAVE ENVIRONMENTAL CONTROL'S W/ VISUAL & TACTILE CUE'S INCLUDING "ROCKER" TYPE
- SWITCHE'S & DIGITAL PROGRAMMABLE THERMOSTAT'S W/ RAISED BUTTON'S
- ALL (3) UNIT'S HAVE FLASHING DOORBELL ALARM FOR HS&I
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- & SIDE-BY-SIDE REFRIGERATOR W/ICE MAKER ALL ENERGY STAR QUALIFIED OR EQUIVALENT 42. INDIVIDUAL STORAGE UNIT'S FOR ALL RESIDENT'S
- INDIVIDUAL PATIO AREA FOR ALL RESIDENT'S
- EXERCISE ROOM W/ EQUIPMENT FOR USE TO ALL RESIDENT'S THIS CONTRACT
- COMPUTER LAB WITH 4-IN-I PRINTER FOR USE TO ALL RESIDENT'S
- COMMUNITY SPACE ON SITE FLAT SCREEN T.V. W/ DVD PLAYER THIS CONTRACT

FREE INTERNET ACCESS AT COMMUNITY BUILDING AT NO COST TO RESIDENTS

- COVERED PORCH AREA ATTACHED TO COMMUNITY BLDG FOR USE TO ALL RESIDENT'S
- PICNIC AREA W/ PICNIC TABLES FOR USE TO ALL RESIDENT'S
- TWO BARBECUE GRILLS FOR USE TO ALL RESIDENT'S LOCATED AT PAVILION / PICNIC AREA
- WASHER'S & DRYER'S FURNISHED IN ALL UNIT'S AT NO COST TO THE RESIDENT THRU WALL MTL DRYER VENT W/ PEST FREE CAP
- PRIVACY FENCING RUNNING ALONG THREE SIDES OF PROPERTY BOUNDARY LINE
- 53. DECORATIVE FENCING RUNNING ALONG THE FRONT PROPERTY BOUNDARY LINE
- 54. VIDEO SURVELLANCE
- FENCED COMMUNITY GARDEN AREA
- 56. BUS SHELTER

littlearch@sbcglobal.net


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JONESBORO, AR


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DATE : 6/20/16

DATE: 6/20/16



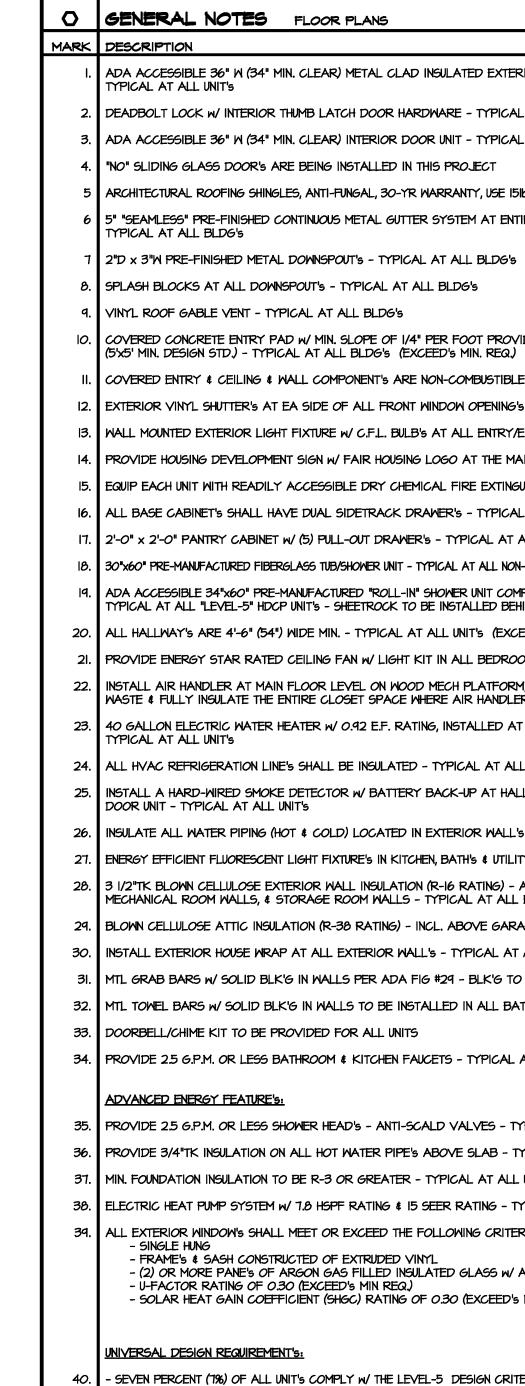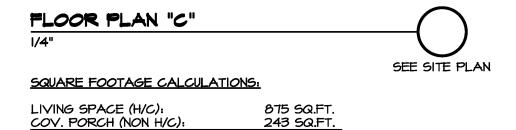COVERED AREA ENTERTAINMENT CENTER COMMON ROOM 5'-3" 4 EXERCISE ROOM (12) <u>OFFICE</u> <u>LOBBY</u> COMPUTER LAB 13'-7" ALL-IN-ONE 37'-0" OVERALL



I,IIB SQ.FT.

TOTAL AREA:


- ADA ACCESSIBLE 36" W (34" MIN. CLEAR) METAL CLAD INSULATED EXTERIOR DOOR UNIT W/ DOUBLE PEEP HOLE'S -
- 2. DEADBOLT LOCK W/ INTERIOR THUMB LATCH DOOR HARDWARE TYPICAL AT ALL UNIT'S
- ADA ACCESSIBLE 36" W (34" MIN. CLEAR) INTERIOR DOOR UNIT TYPICAL AT ALL UNIT'S
- "NO" SLIDING GLASS DOOR'S ARE BEING INSTALLED IN THIS PROJECT
- 5 ARCHITECTURAL ROOFING SHINGLES, ANTI-FUNGAL, 30-YR WARRANTY, USE 151b. ROOF FELT UNDER TYPICAL AT ALL BLDG'S
- 6 5" "SEAMLESS" PRE-FINISHED CONTINUOUS METAL GUTTER SYSTEM AT ENTIRE ROOF PERIMETER (EXLUDING GABLE'S) -
- 7  $\mid$  2"D  $\times$  3"W PRE-FINISHED METAL DOWNSPOUT'S TYPICAL AT ALL BLDG'S
- 8. SPLASH BLOCKS AT ALL DOWNSPOUT'S TYPICAL AT ALL BLDG'S
- COVERED CONCRETE ENTRY PAD w/ MIN. SLOPE OF 1/4" PER FOOT PROVIDED FOR ALL UNIT'S
- COVERED ENTRY & CEILING & WALL COMPONENT'S ARE NON-COMBUSTIBLE MATERIAL'S TYPICAL AT ALL BLDG'S
- EXTERIOR VINYL SHUTTER'S AT EA SIDE OF ALL FRONT WINDOW OPENING'S WITH VINYL SIDING SEE EXTERIOR ELEVATIONS
- 13. MALL MOUNTED EXTERIOR LIGHT FIXTURE W/ C.F.L. BULB'S AT ALL ENTRY/EXIT DOOR'S TYPICAL AT ALL BLDG'S
- PROVIDE HOUSING DEVELOPMENT SIGN W/ FAIR HOUSING LOGO AT THE MAIN ENTRANCE OF THE DEVELOPMENT
- EQUIP EACH UNIT WITH READILY ACCESSIBLE DRY CHEMICAL FIRE EXTINGUISHER TYPICAL AT ALL UNIT'S
- ALL BASE CABINET'S SHALL HAVE DUAL SIDETRACK DRAWER'S TYPICAL AT ALL UNIT'S
- 2'-0" x 2'-0" PANTRY CABINET w/ (5) PULL-OUT DRAWER'S TYPICAL AT ALL UNIT'S (EXCEED'S MIN. REQ.)
- 30"x60" PRE-MANUFACTURED FIBERGLASS TUB/SHOWER UNIT TYPICAL AT ALL NON-HDCP UNIT'S SHEETROCK TO BE INSTALLED BEHIND UNIT
- ADA ACCESSIBLE 34"x60" PRE-MANUFACTURED "ROLL-IN" SHOWER UNIT COMPLETE W/ ALL ADA REQ'd ACCESSORIE'S -TYPICAL AT ALL "LEVEL-5" HDCP UNIT'S - SHEETROCK TO BE INSTALLED BEHIND THE UNIT
- ALL HALLWAY'S ARE 4'-6" (54") WIDE MIN. TYPICAL AT ALL UNIT'S (EXCEED'S MIN. REQ.)
- PROVIDE ENERGY STAR RATED CEILING FAN W/LIGHT KIT IN ALL BEDROOM'S & LIVING ROOM'S TYPICAL AT ALL UNIT'S
- 22. INSTALL AIR HANDLER AT MAIN FLOOR LEVEL ON WOOD MECH PLATFORM, CONNECT CONDENSATE DRAIN TO PLUMBING WASTE & FULLY INSULATE THE ENTIRE CLOSET SPACE WHERE AIR HANDLER IS LOCATED - TYPICAL AT ALL UNIT'S
- 23. 40 GALLON ELECTRIC WATER HEATER W/ 0.92 E.F. RATING, INSTALLED AT MAIN FLOOR LEVEL W/ DRAIN PAN -
- 24. ALL HVAC REFRIGERATION LINE'S SHALL BE INSULATED TYPICAL AT ALL UNIT'S
- 25. INSTALL A HARD-WIRED SMOKE DETECTOR W/ BATTERY BACK-UP AT HALLWAY & IN EVERY BEDROOM NEAR THE DOOR UNIT - TYPICAL AT ALL UNIT'S
- 26. INSULATE ALL WATER PIPING (HOT & COLD) LOCATED IN EXTERIOR WALL'S TYPICAL AT ALL BLDG'S
- ENERGY EFFICIENT FLUORESCENT LIGHT FIXTURE'S IN KITCHEN, BATH'S & UTILITY SPACE'S- TYPICAL AT ALL UNIT'S & OFFICE/COMM.
- 26. 3 1/2"TK BLOWN CELLULOSE EXTERIOR WALL INSULATION (R-16 RATING) ALL EXTERIOR WALLS, GARAGE WALLS, MECHANICAL ROOM WALLS, & STORAGE ROOM WALLS - TYPICAL AT ALL BLDG'S
- 29. BLOWN CELLULOSE ATTIC INSULATION (R-38 RATING) INCL. ABOVE GARAGE & STORAGE ROOM TYPICAL AT ALL BLDG'S
- INSTALL EXTERIOR HOUSE WRAP AT ALL EXTERIOR WALL'S TYPICAL AT ALL BLDG'S
- MTL GRAB BARS W/ SOLID BLK'G IN WALLS PER ADA FIG #29 BLK'G TO BE INSTALLED IN ALL UNITS
- 32. MTL TOWEL BARS W/ SOLID BLK'G IN WALLS TO BE INSTALLED IN ALL BATHROOMS
- DOORBELL/CHIME KIT TO BE PROVIDED FOR ALL UNITS
- PROVIDE 2.5 G.P.M. OR LESS BATHROOM & KITCHEN FAUCETS TYPICAL AT ALL UNIT'S

# ADVANCED ENERGY FEATURE'S:

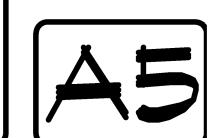- PROVIDE 2.5 G.P.M. OR LESS SHOWER HEAD'S ANTI-SCALD VALVES TYPICAL AT ALL UNIT'S
- 36. PROVIDE 3/4"TK INSULATION ON ALL HOT WATER PIPE'S ABOVE SLAB TYPICAL AT ALL UNIT'S
- MIN. FOUNDATION INSULATION TO BE R-3 OR GREATER TYPICAL AT ALL UNIT'S
- ELECTRIC HEAT PUMP SYSTEM w/ 1.8 HSPF RATING & 15 SEER RATING TYPICAL AT ALL UNIT'S (EXCEED'S MIN. REQ.)
  - ALL EXTERIOR WINDOW'S SHALL MEET OR EXCEED THE FOLLOWING CRITERIA: (TYPICAL AT ALL BLDG'S)
  - FRAME'S & SASH CONSTRUCTED OF EXTRUDED VINYL
  - (2) OR MORE PANE'S OF ARGON GAS FILLED INSULATED GLASS W/ AT LEAST PANE W/ LOW-E COATING - U-FACTOR RATING OF 0.30 (EXCEED'S MIN REQ.)
  - SOLAR HEAT GAIN COEFFICIENT (SHGC) RATING OF 0.30 (EXCEED'S MIN. REQ.)

# UNIVERSAL DESIGN REQUIREMENT'S:

- SEVEN PERCENT (196) OF ALL UNIT'S COMPLY W/ THE LEVEL-5 DESIGN CRITERIA TOTALING (3) UNIT'S FOR THIS PROJECT
  - ALL UNIT'S COMPLY W/ THE DESIGN CRITERIA IN THE "AUSH" MANUAL - ALL UNIT'S HAVE "CLOSED-FIST" OPERABILITY THROUGHOUT THE ENTIRE UNIT INCLUDING THE FOLLOWING:
  - \* SINGLE HANDLE DOOR LEVER'S VS. DOORKNOB'S
  - \*\* PUSH STICK LIGHTING AND ENVIROMENTAL CONTROL'S \*\*\* CABINET DOOR'S CAN BE OPENED W/ A CLOSED FIST
  - \*\*\*\* SINGLE HANDLE FAUCET'S IN ALL BATHROOM'S & KITCHEN'S - ALL UNIT'S HAVE ENVIRONMENTAL CONTROL'S W/ VISUAL & TACTILE CUE'S INCLUDING "ROCKER" TYPE
  - SWITCHE'S & DIGITAL PROGRAMMABLE THERMOSTAT'S W/ RAISED BUTTON'S - ALL (3) UNIT'S HAVE FLASHING DOORBELL ALARM FOR HS&I
  - DEVELOPMENT AMENITY LIST & DESCRIPTION'S: (ALL EQUIPMENT & APPLIANCE'S ENERGY STAR RATED)
- KITCHEN APPLIANCE'S AS FOLLOW'S: ABOVE-THE-RANGE MICROWAVE OVEN, DISHWASHER, GARBAGE DISPOSAL, & SIDE-BY-SIDE REFRIGERATOR W/ICE MAKER - ALL ENERGY STAR QUALIFIED OR EQUIVALENT
- 42. INDIVIDUAL STORAGE UNIT'S FOR ALL RESIDENT'S
- INDIVIDUAL PATIO AREA FOR ALL RESIDENT'S
- EXERCISE ROOM W/ EQUIPMENT FOR USE TO ALL RESIDENT'S THIS CONTRACT
- COMPUTER LAB WITH 4-IN-I PRINTER FOR USE TO ALL RESIDENT'S
- FREE INTERNET ACCESS AT COMMUNITY BUILDING AT NO COST TO RESIDENTS
- COMMUNITY SPACE ON SITE FLAT SCREEN T.V. W/ DVD PLAYER THIS CONTRACT
- COVERED PORCH AREA ATTACHED TO COMMUNITY BLDG FOR USE TO ALL RESIDENT'S
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- 50. TWO BARBECUE GRILLS FOR USE TO ALL RESIDENT'S LOCATED AT PAVILION / PICNIC AREA
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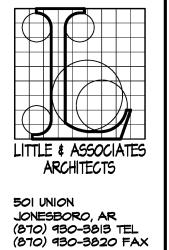
JONESBORO, AR

(870) 930-3813 TEL (870) 930-3820 FAX littlearch@sbcglobal.net

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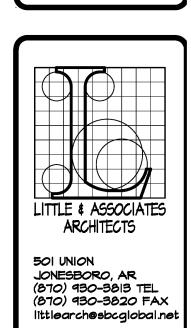
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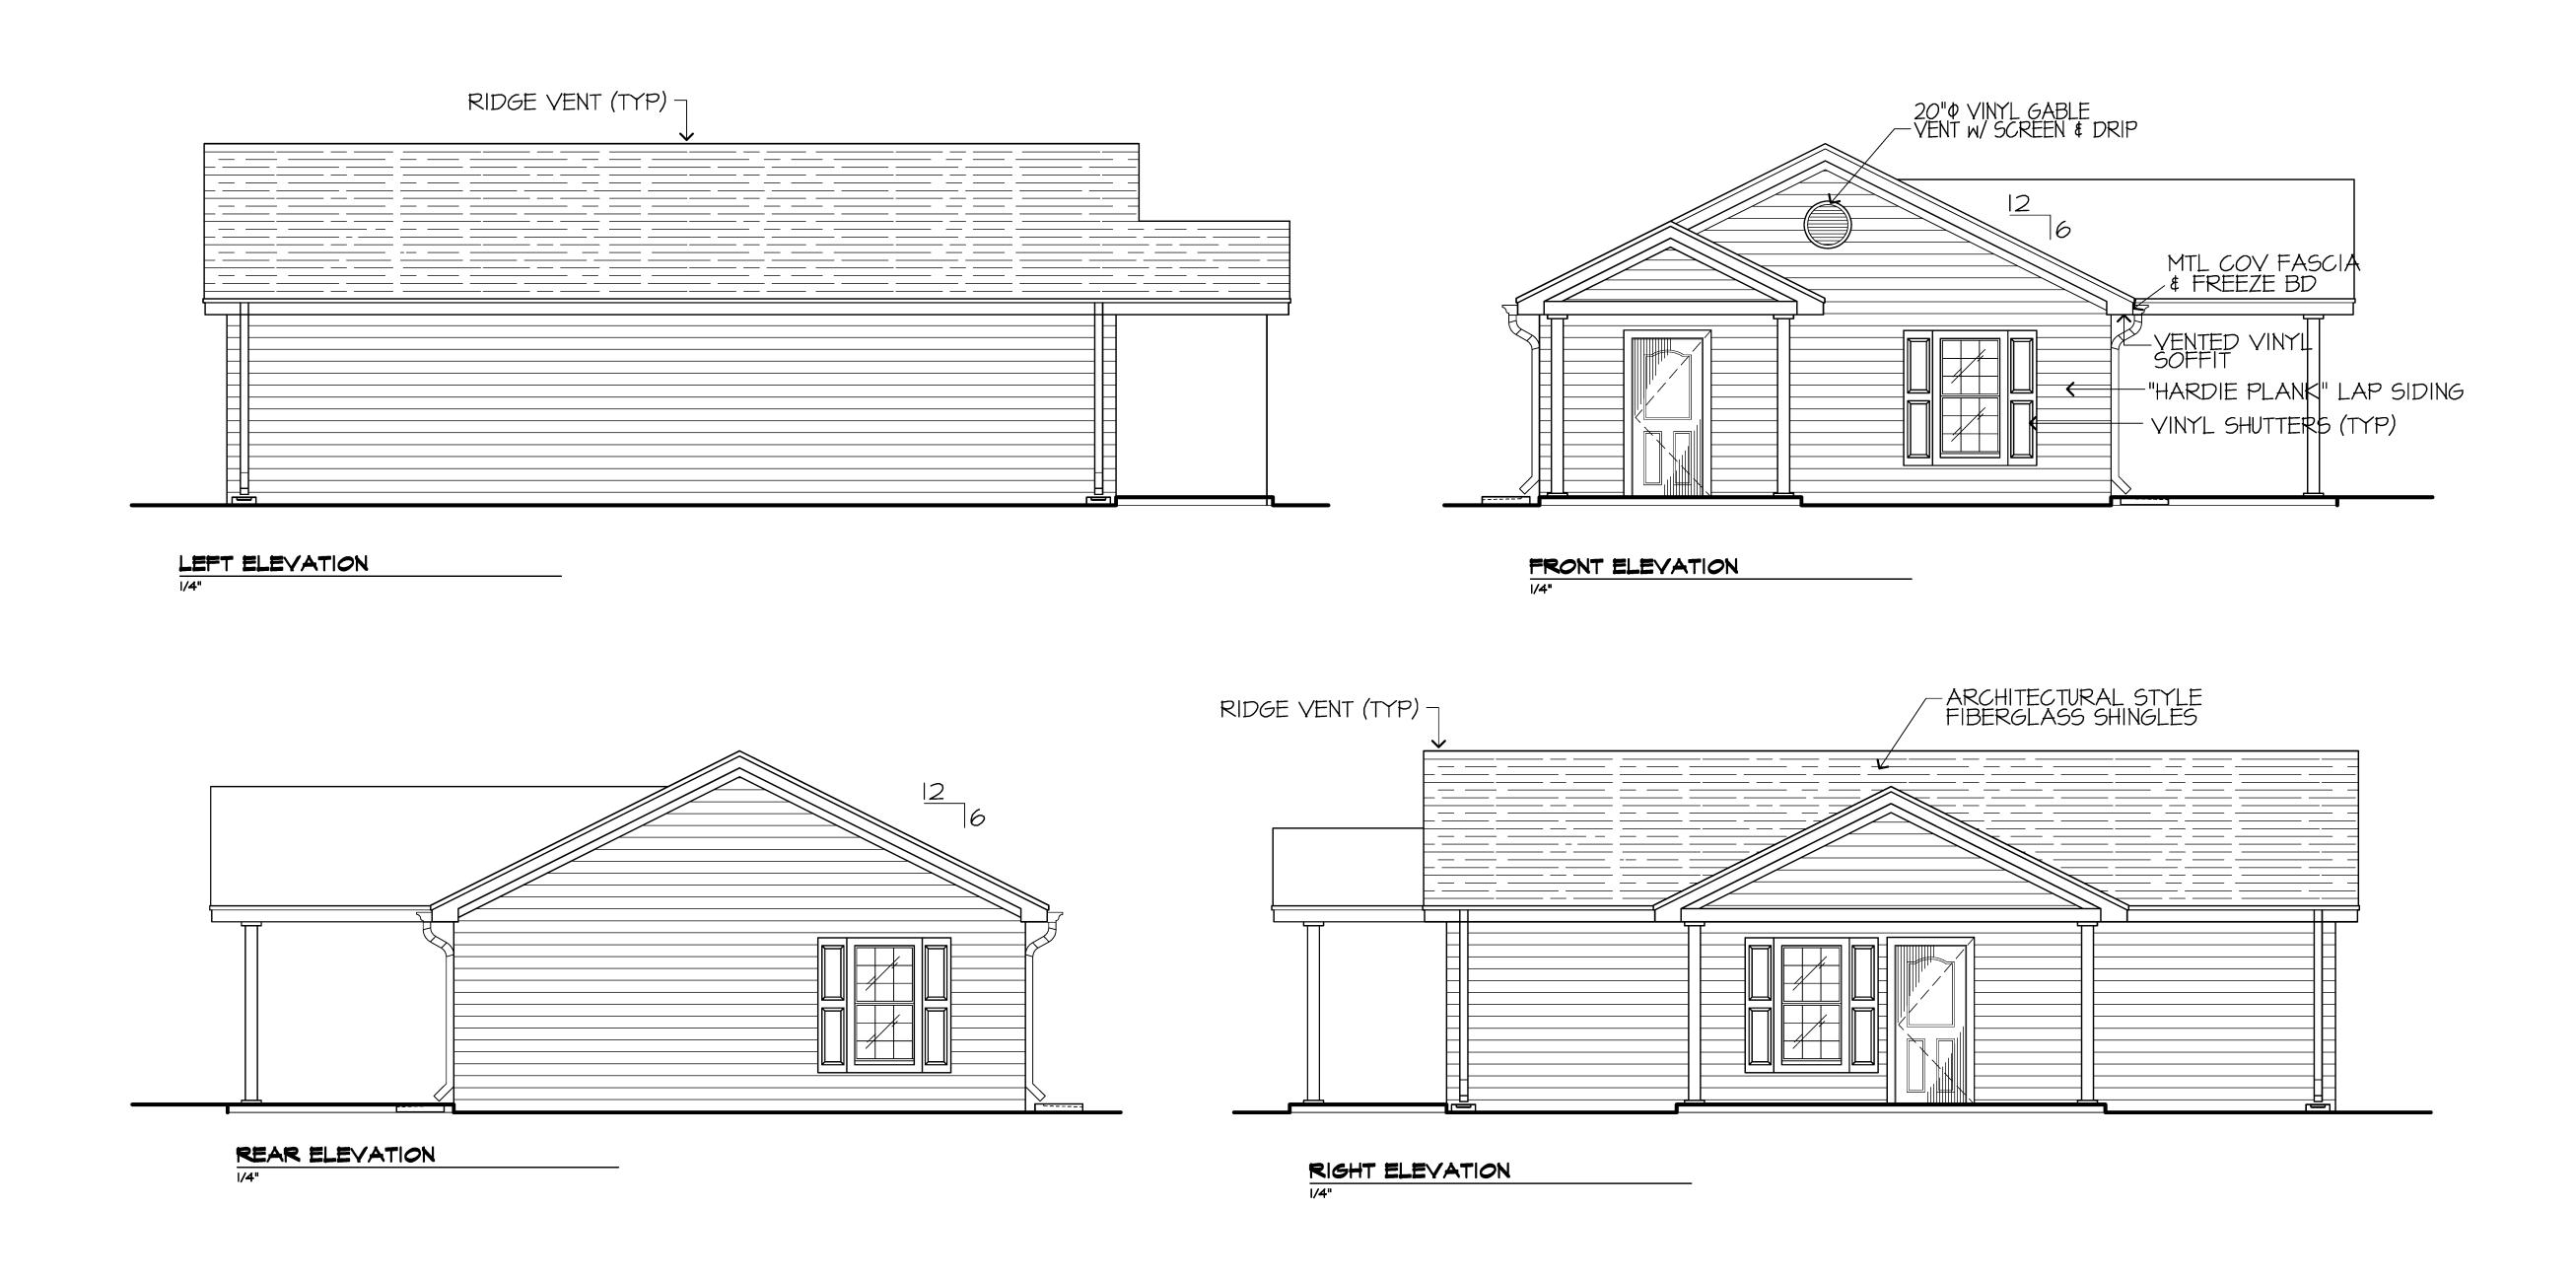
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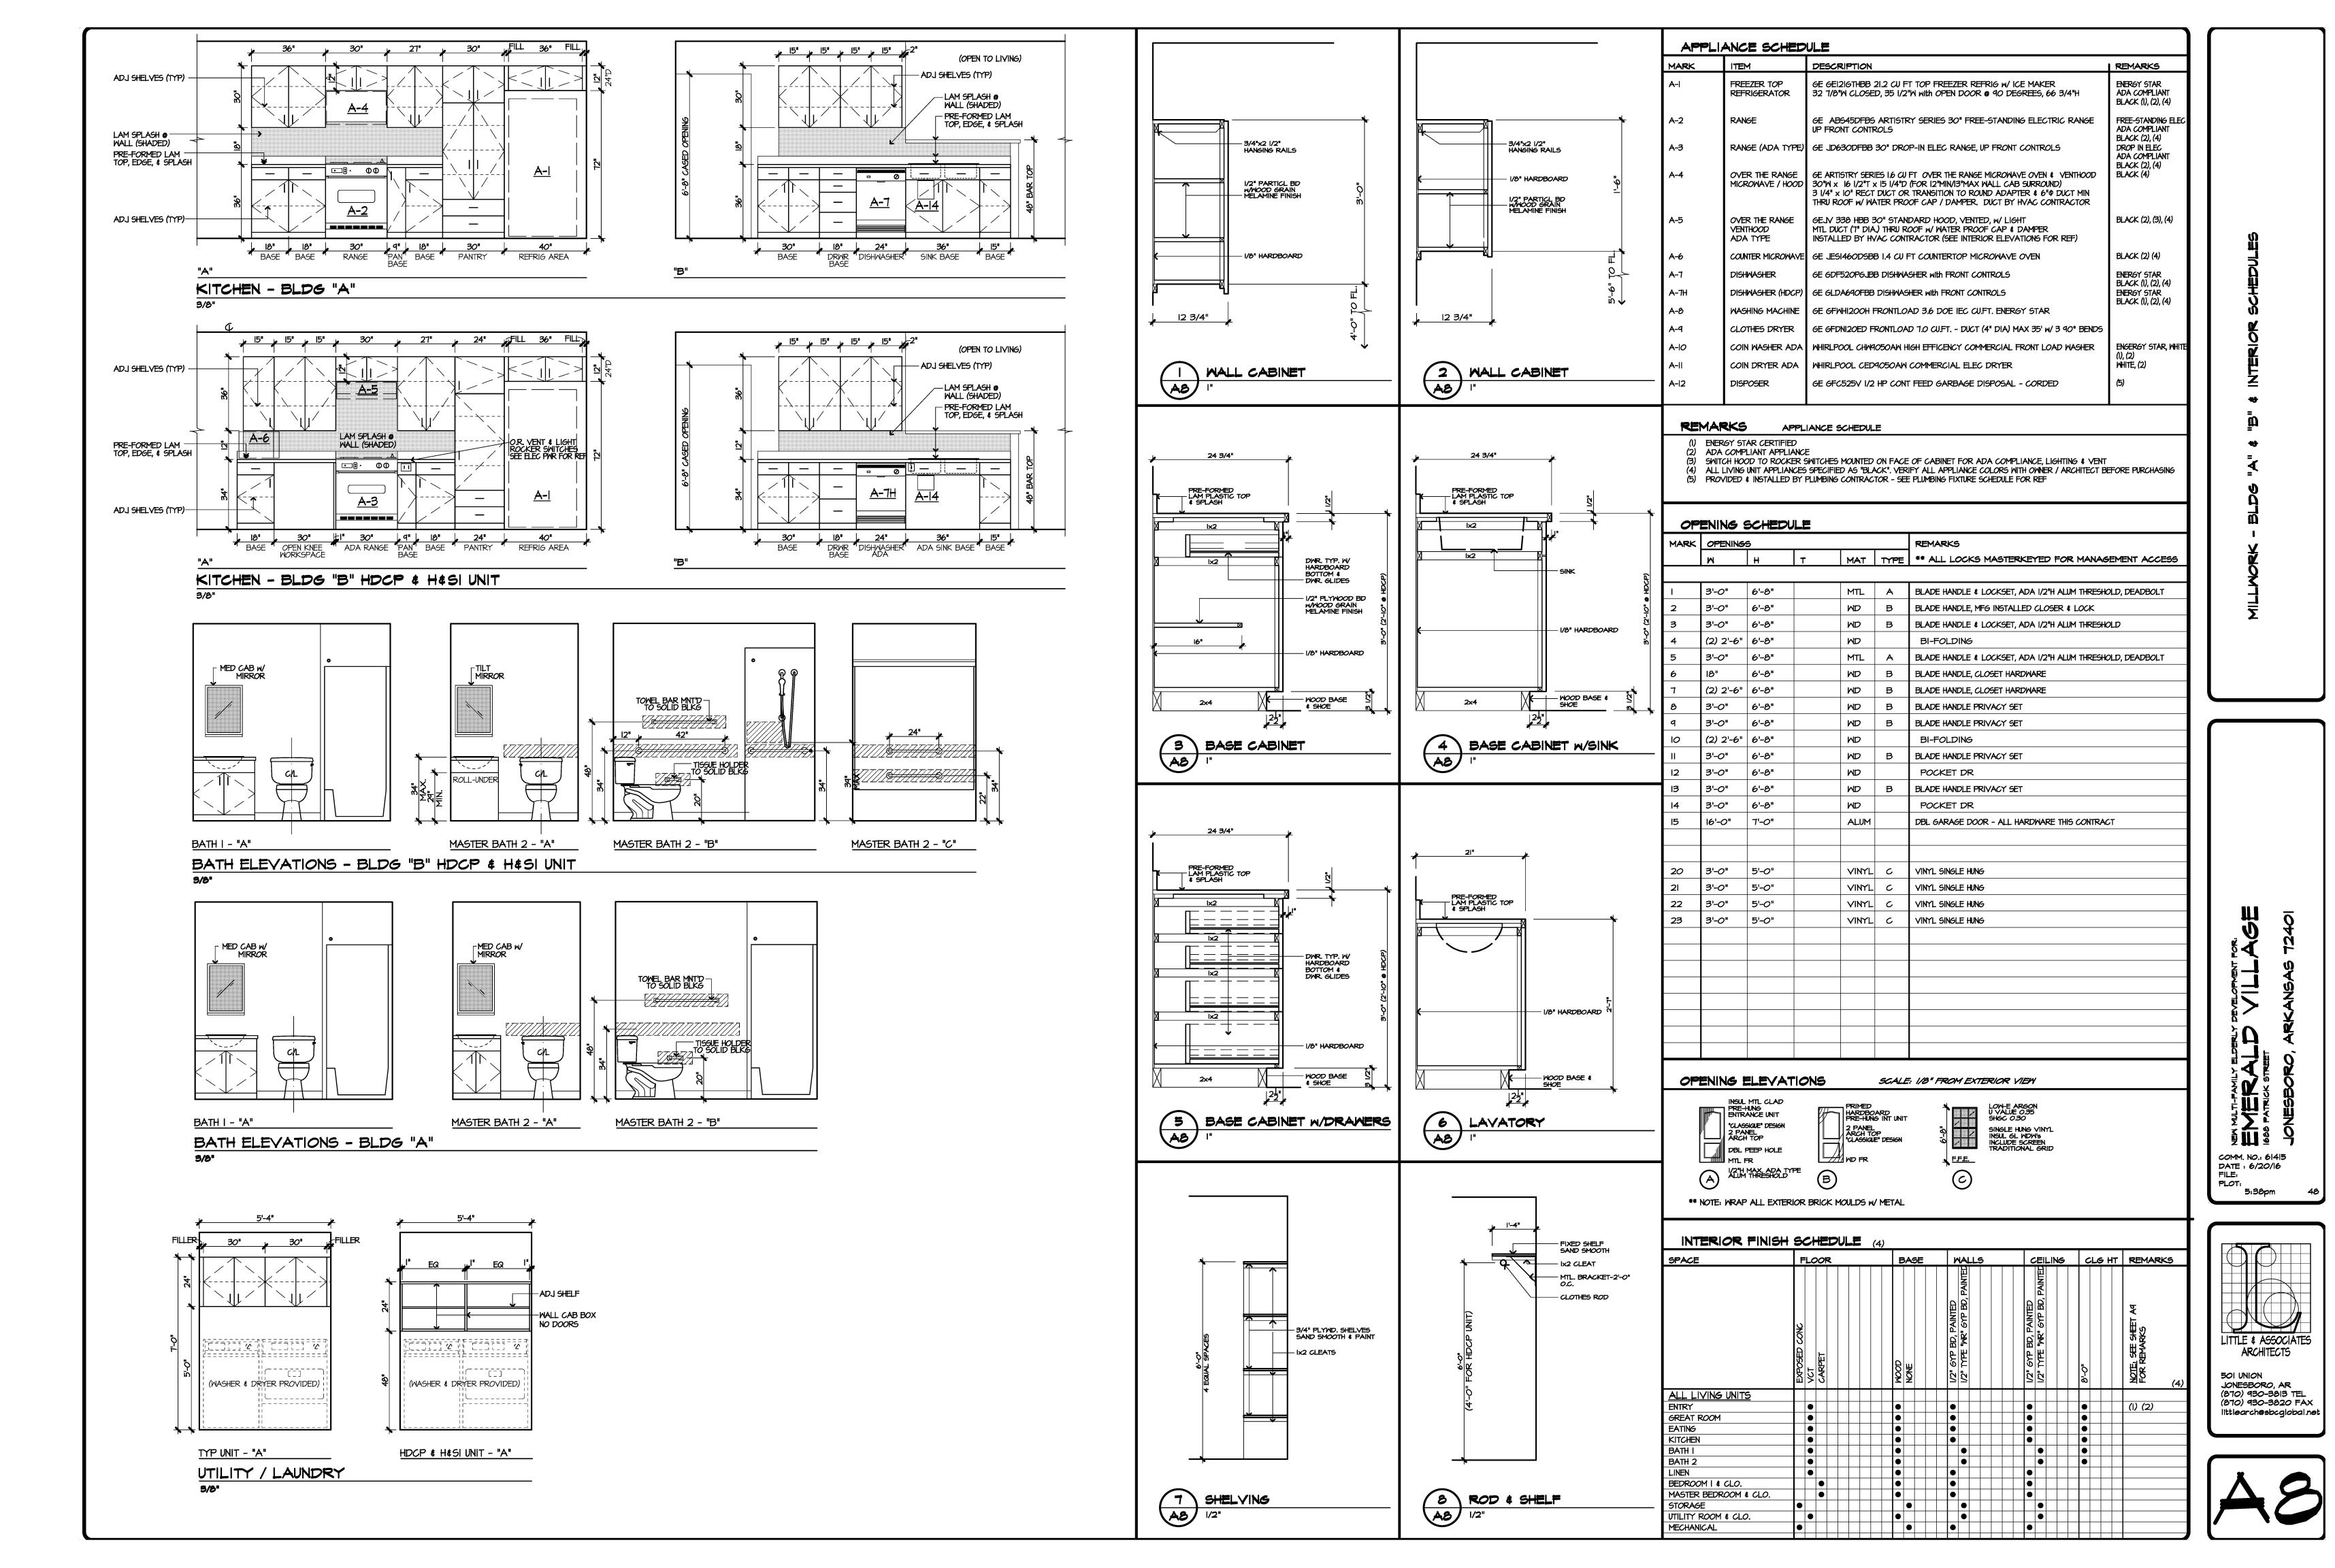




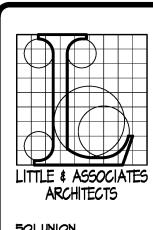


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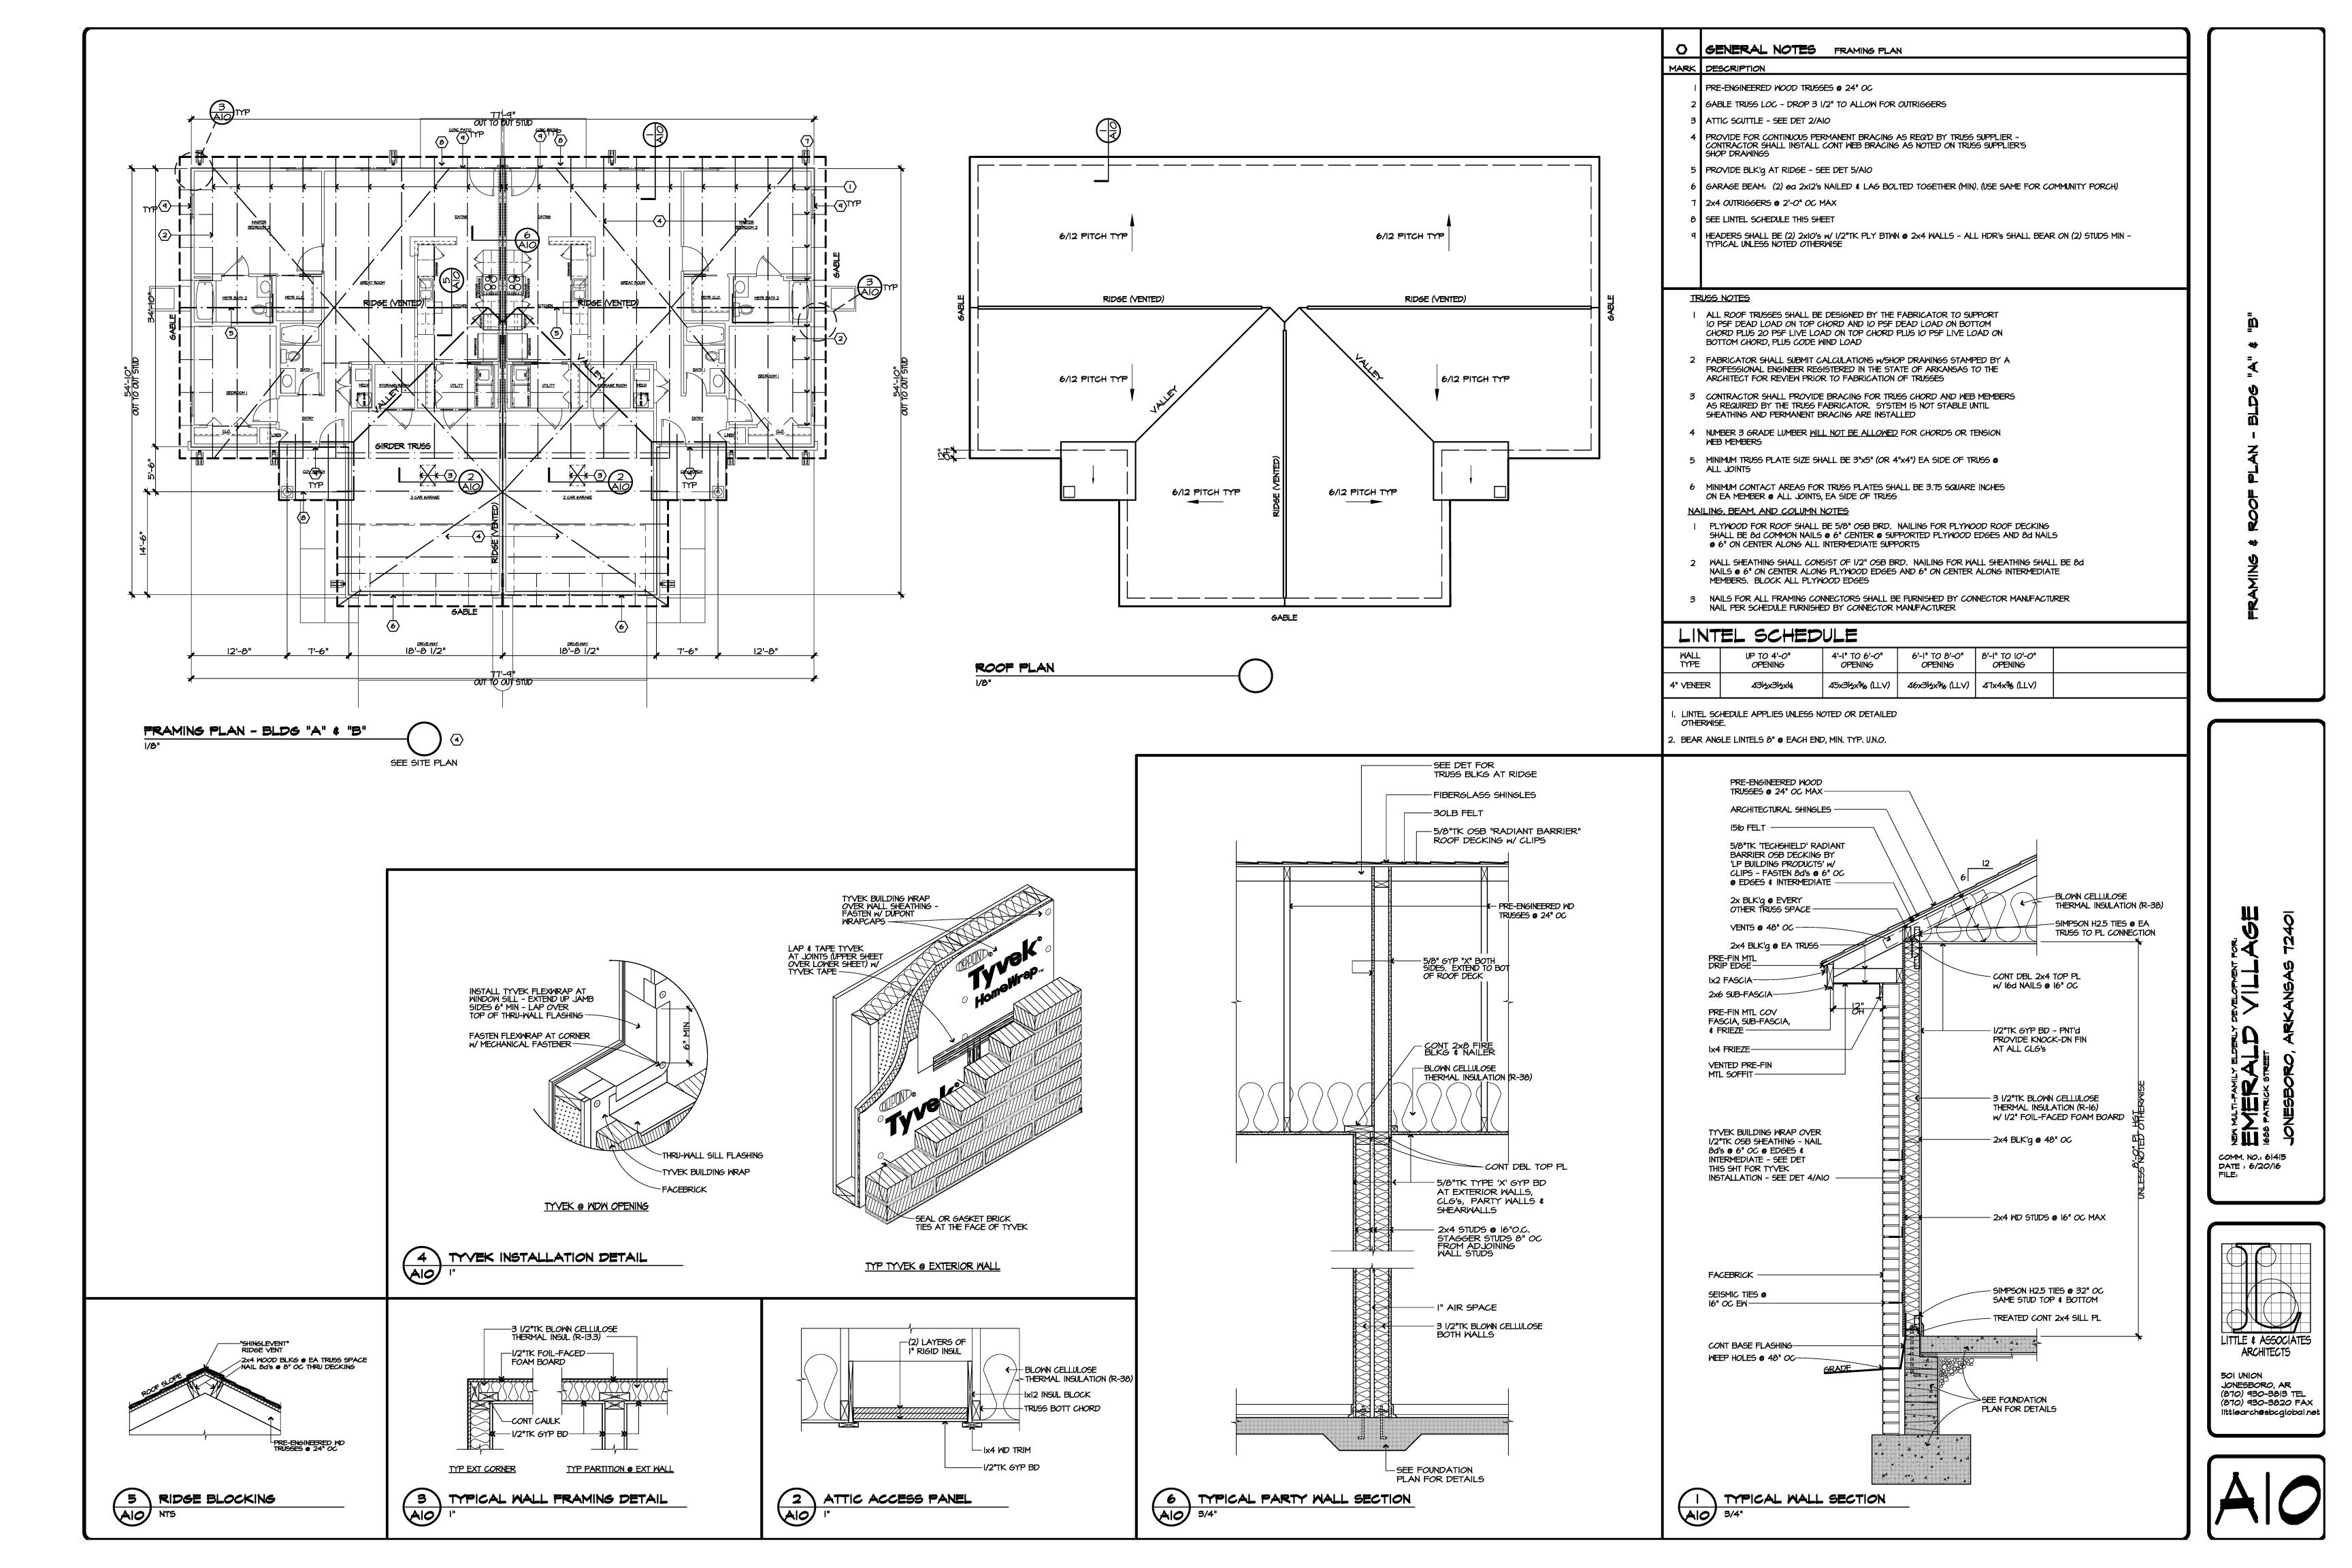


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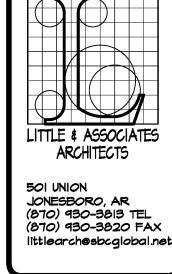


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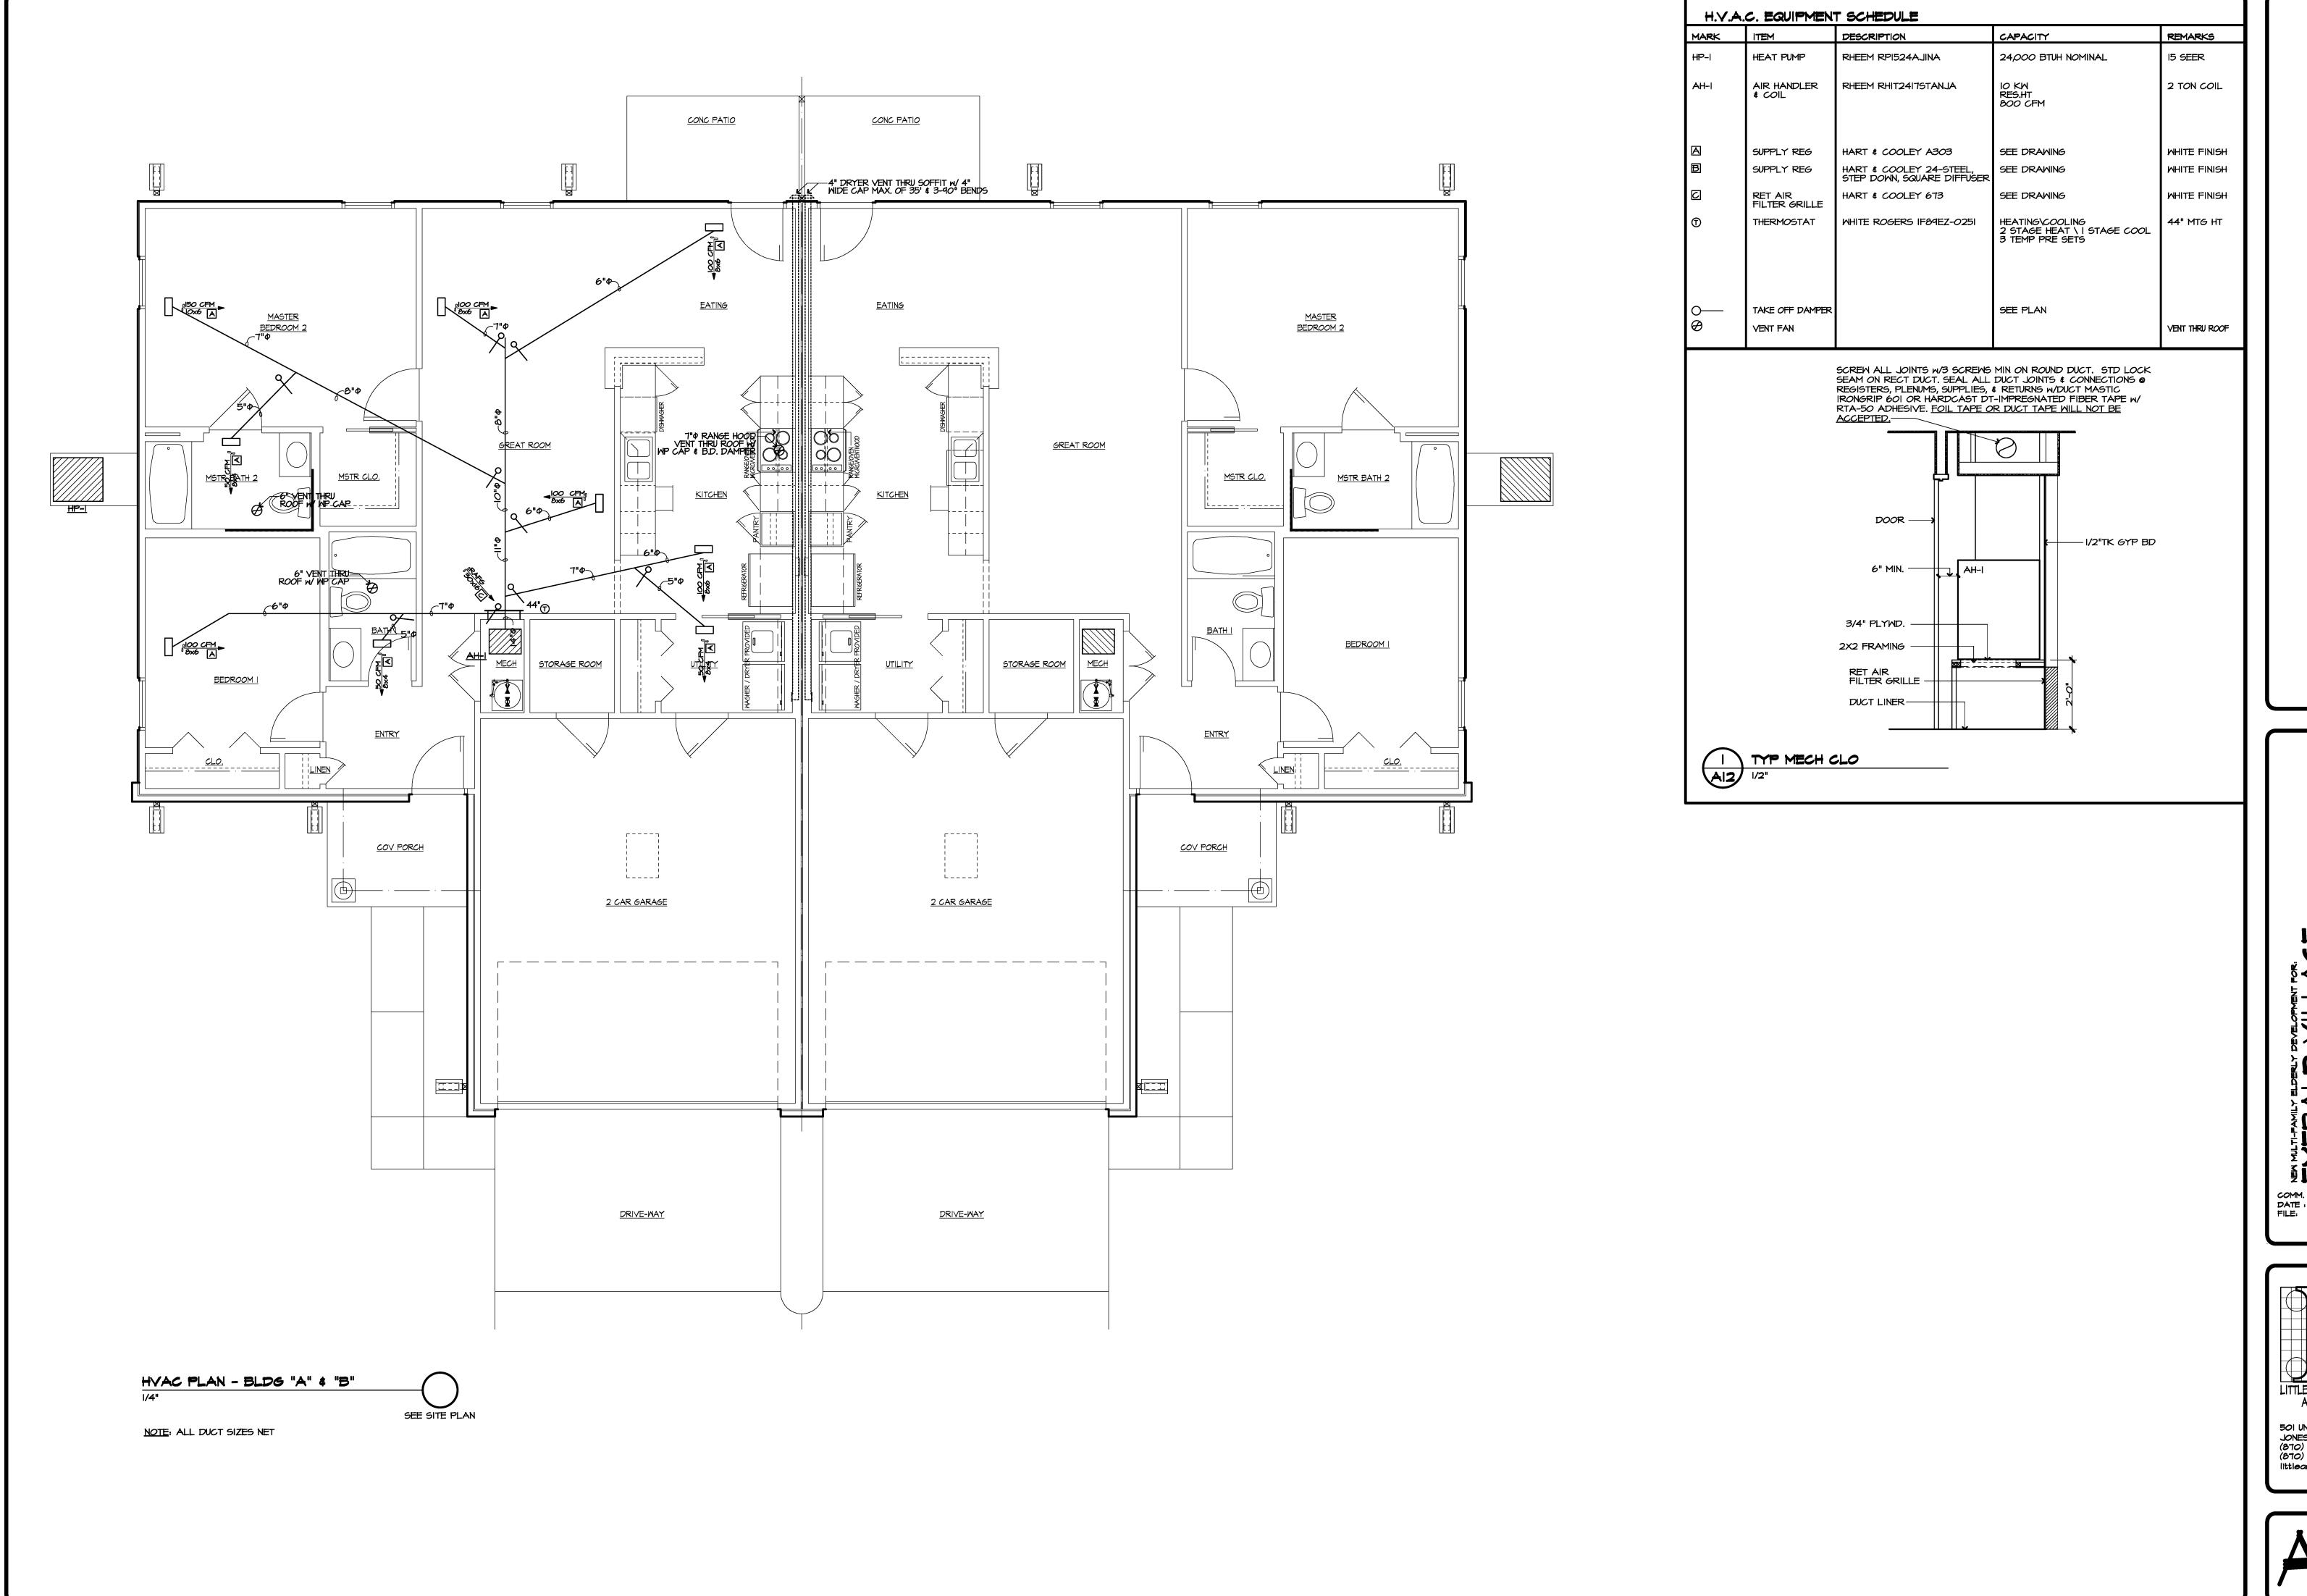
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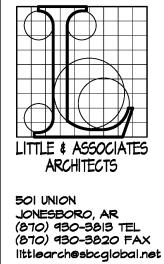
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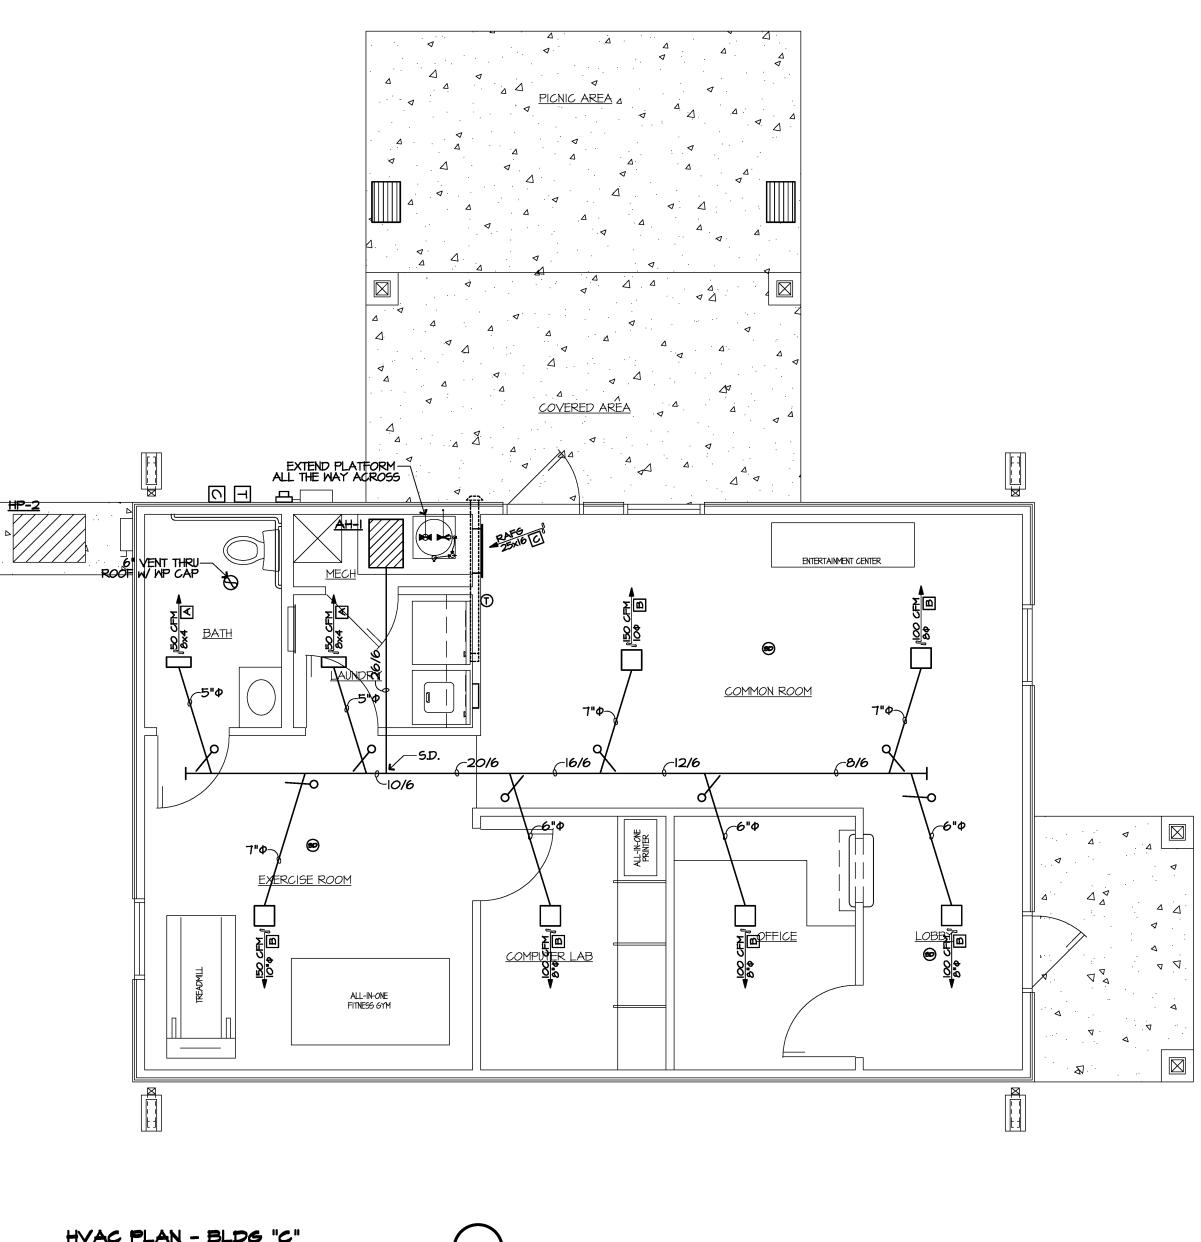
HVAC PLAN - BLDG "A" & "B"

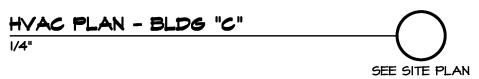
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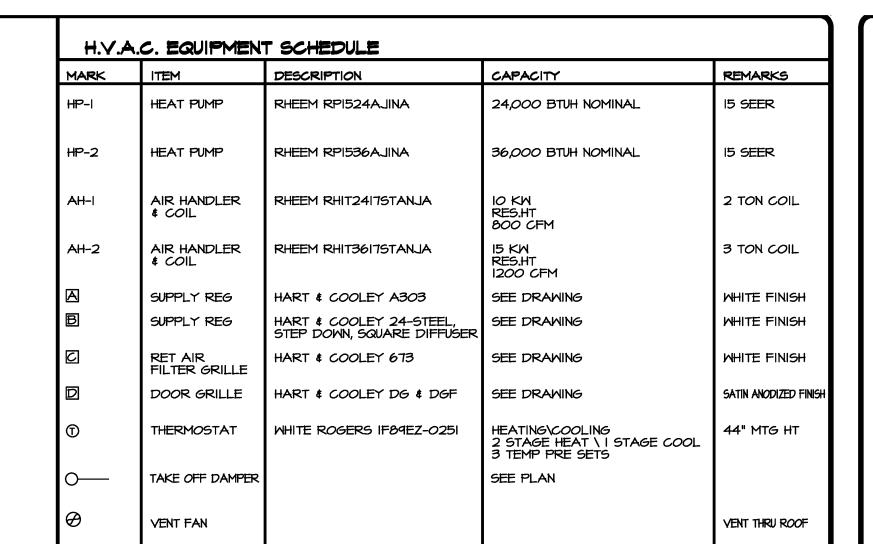


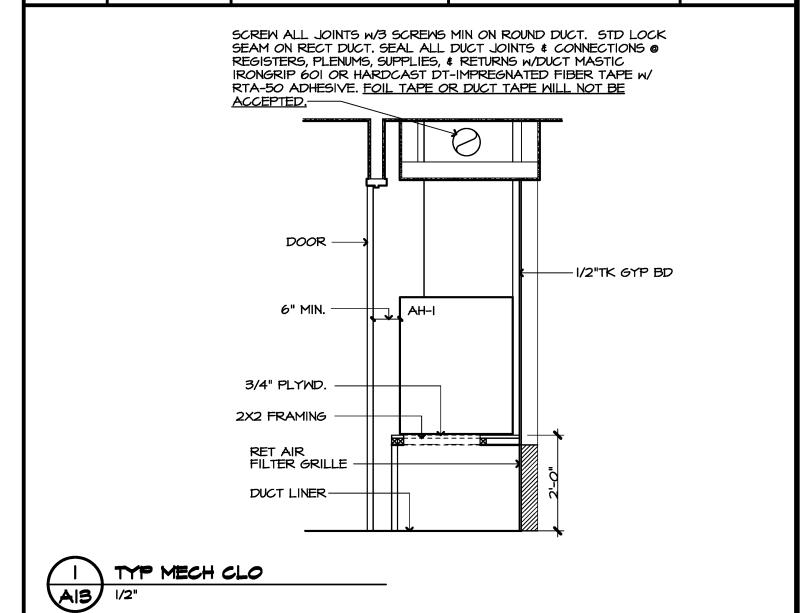






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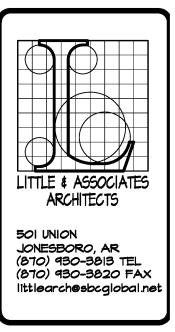



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OF 1688 FATRICK STREET

ONESBORO, ARKANSAS 12401






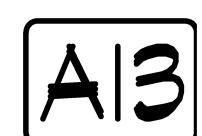REMARKS

# PLUMBING FIXTURE SCHEDULE

PLUMBING FIXTURE SCHEDULE

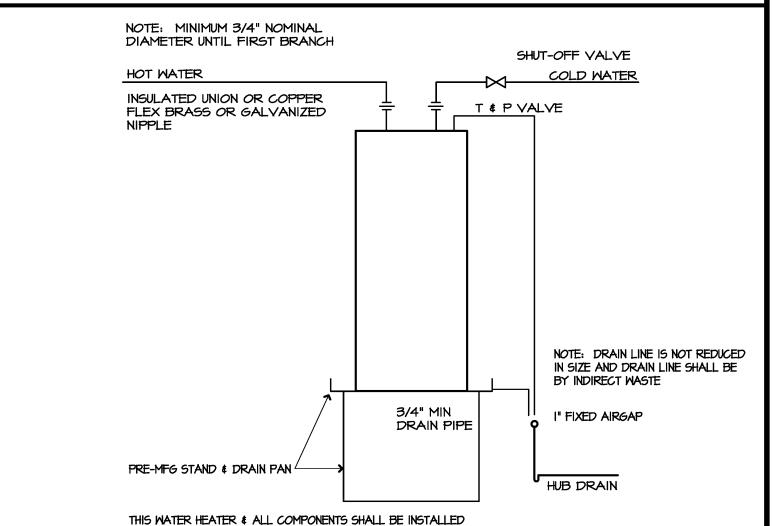
- (2) FIXTURE SUPPLIES & DRAIN SHALL EXTEND NO MORE THAN 6" OUT FROM WALL & SHALL PROVIDE 29" MIN. FLOOR TO BOTTOM - 29" CLEAR UNDER MIN, SINK RIM 34"H MAX - SEE MILLWORK FOR REF
- (3) FLUSH HANDLE ON TANK TO BE ON OPEN SIDE OF STALL (ENFORCED)
- (4) DO NOT INSTALL TUB UNIT UNTIL WALL HAS BEEN INSULATED & GYP BD INSTALLED BEHIND TUB
- (5) PROVIDED & INSTALLED BY PLUMBING CONTRACTOR SEE APPLIANCE SCHED FOR REF
- (6) PROVIDE PRE-MFG STAND & AUXILIARY DRAIN PAN, H&C CUT OFF VALVES @ WATER HEATER SEE DETAIL I/M
- (1) HUBB DRAINS @ MECHANICAL UNITS SHALL <u>NOT</u> BE INSTALLED IN RETURN AIR SPACE -EXTEND ABOVE MECH PLATFORM WHERE APPLICABLE
- (8) WATER LINE FROM ICE MAKER OUTLET BOX TO REFRIGERATOR TO BE PROVIDED & INSTALLED THIS CONTRACT
- (9) LOOSE FLEX COPPER LINES RUN THROUGH CABINETS WILL NOT BE ACCEPTED. LINES MUST BE CONCEALED IN WALL & FIXED TO PRE-MFG BOX
- (IO) MOUNT ORIFICE @ 34"H MAX FOR ADA REQUIREMENTS
- (II) MOP SINK FAUCET TO BE MOUNTED TO SECURE WD BLOCKING IN WALL COORDINATE REQ W/FRAMER - DO <u>NOT</u> INSTALL WITHOUT BLOCKING IN WALL






<u>P-10</u> PLUMBING CONTRACTOR REMARKS

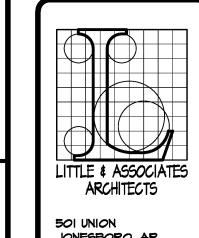THIS WATER HEATER & ALL COMPONENTS SHALL BE INSTALLED PER THE APC - ARKANSAS PLUMBING CODE 2006



DATE : 6/20/16 FILE:

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NOTE: ALL PLUMBING FIXTURES IN BLDG "B" TO BE HDCP ACCESSIBLE SEE FLOOR PLAN BLDG "B" FOR REFERENCE
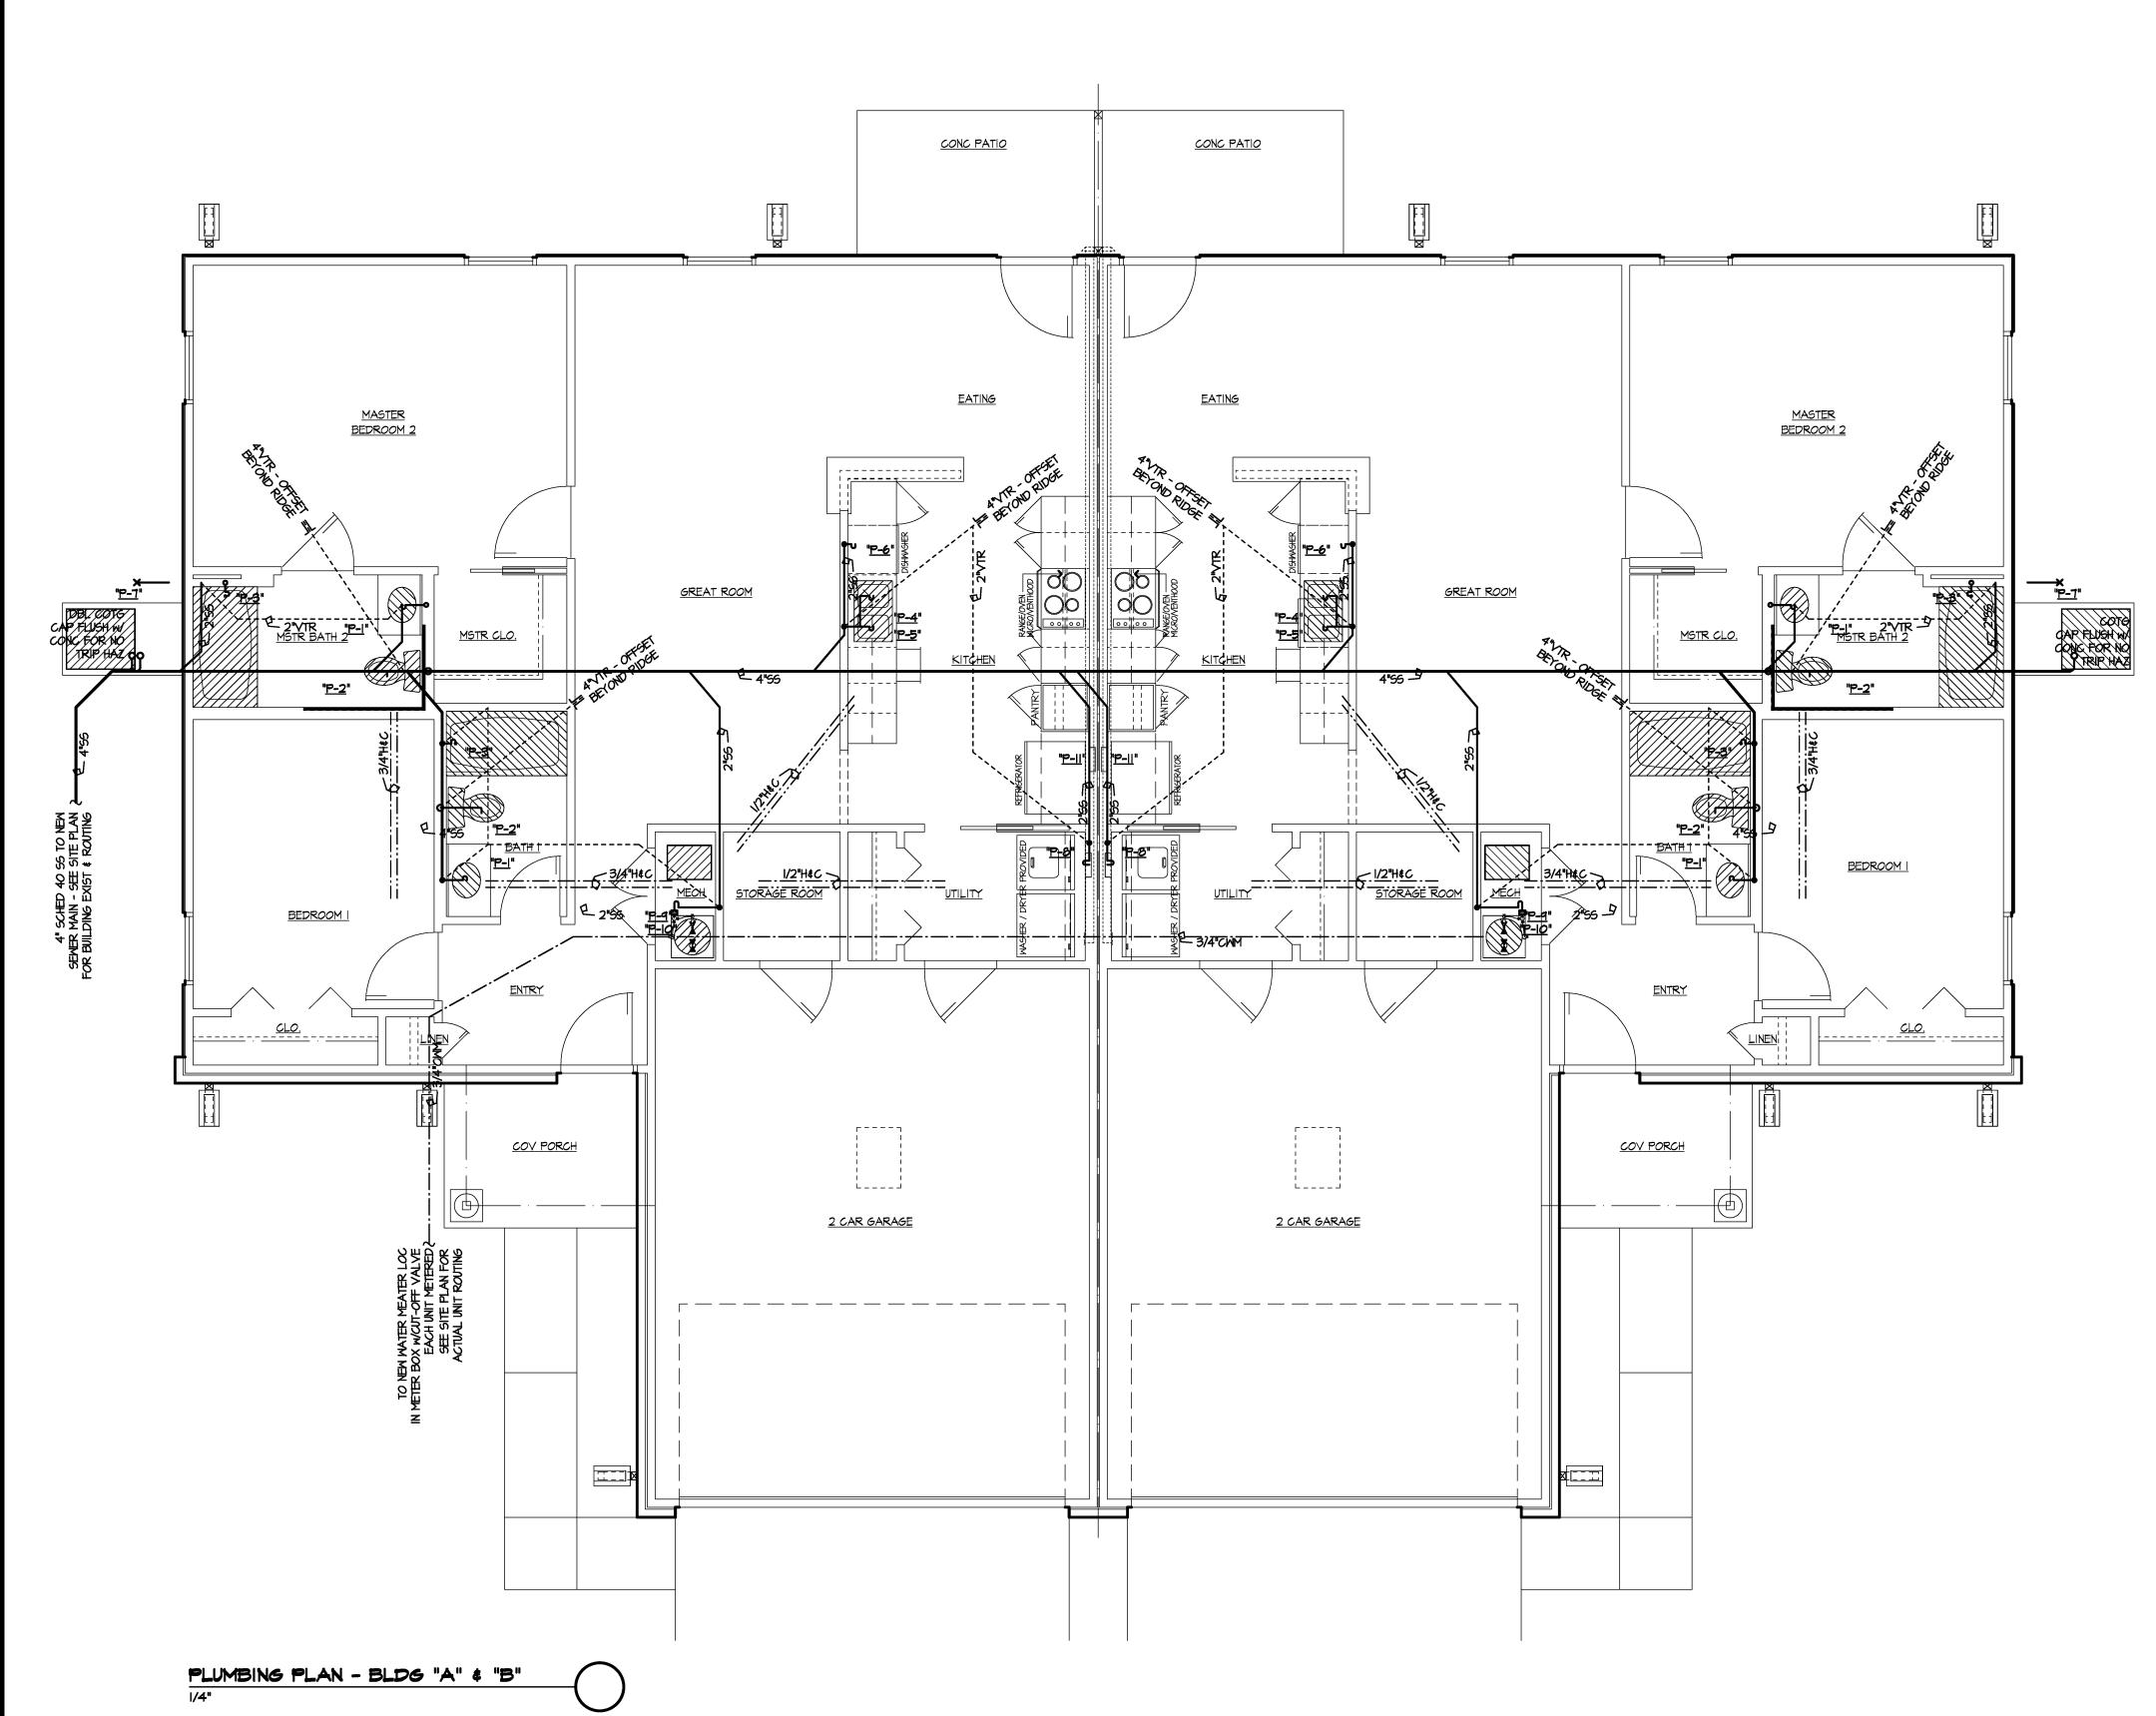
> SEMER AND WATER MAIN LOCATION TO ALTERNATE SIDES -4 UNITS PER CONNECTION - SEE SITE UTILITY PLAN FOR REF


NOTE: ALL FIXTURES IN COMMUNITY BLDG TO BE HDCP ACCESSIBLE

SEE SITE PLAN

PLUMBING FIXTURE SCHEDULE								
MARK	ITEM	DESCRIPTION	REMARKS					
<u> </u>	LAVATORY	22x37 (3 BR) 22x31 (2 BR) MARBLE TOP & INTEGRATED BOWL with CHICAGO 420-ABCP FAUCET	(2)					
<u>P-l</u> HDCP	LAVATORY ADA TYPE	AMERICAN STANDARD LUCERN 0355.012 w/ CHICAGO 420-ABCP FAUCET & MATTS CA-411 CONCEALED CARRIERS	(2)					
<u>P-2</u>	WATER CLOSET	GERBER MAXWELL 21-918 with GLAZED WOOD SEAT	(1), (3)					
<u>P-2</u> HDCP	WATER CLOSET ADA TYPE	GERBER MAXWELL 21-918 with GLAZED WOOD OPEN FRONT SEAT	(1), (3)					
<u>P-3</u>	TUB / SHOWER	AKER OPTS-6032 W/ FACTORY INSTALLED ROD & CURTAIN DELTA TI3420-PDSOS FAUCET	(1), (4)					
<u>P-3</u> HDCP	TUB / SHOWER ADA TYPE	MAAX OPS-6030-R5 W/ FACTORY INSTALLED ROD & CURTAIN COMPLETE W/ ADA-ANSI PACKAGE INCLUDING SEAT - DELTA TI3H333 TRIM & HAND SHOWER, & DIV VALVE	(1), (4)					
<u>P-4</u>	SS SINK	DAYTON D-23322-4 55 SINK W/ CHICAGO 432ABCP FAICET & SPRAY DEARBORN BRASS II STRAINER						
<u>P-4</u> HDCP	SS SINK ADA TYPE	DAYTON GE-23321-4 w/ CHICAGO 432ABCP FAUCET & SPRAY DEARBORN BRASS II BASKET STRAINER	(2)					
<u>P-5</u>	DISPOSAL	GE GFC525V I/2 HP CONT FEED GARBAGE DISPOSAL - CORDED	<b>(5)</b>					
<u>P-6</u>	DISHMASHER CONNECTION	INSTALLED BY PLUMBING CONTRACTOR						
<u>P-7</u>	HOSE BIBB	WOODFORD MODEL 25P AUTOMATIC DRAINING FREEZELESS WALL FAUCET						
<u>P-8</u>	MASHING MACH CONNECTION	OATEY 3875  WNIBCO #74 VALVES						
<u>p-q</u>	MATER HEATER	AO SMITH ELEC 4O GAL ELEC WATER HEATER INCLUDE PRE-MFG STAND & DRAIN PAN	(6)					
<u>P-10</u>	HUB DRAIN	2" PROSET TRAP GUARD HUB DRAIN W/WADE 2490 FIXED AIR GAP MOUNTED @ TOP OF DRAIN	(7)					
<u>P-II</u>	ICE MAKER CONNECTION	OATEY I.M.O.B. w/ SUPPLY VALVE	(9)					
<u>P-I2</u>	WATER COOLER	PORTABLE WATER COOLER - PROVIDED THIS CONTRACT	(6)					
<u>P-I3</u>	MOP SINK	FIAT MSB2424 MOP BASIN, DELTA 28T9 FAUCET, 832-AA HOSE & BRACKET, 889-CC MOP BRACKET	(11)					
<u>P- 4</u>	FLOOR DRAIN	PROSET T25630-F-P 2: TRAP GAURD FLOOR DRAIN w/ 5" NICKEL BRONZE STRAINER						

# REMARKS PLUMBING FIXTURE SCHEDULE

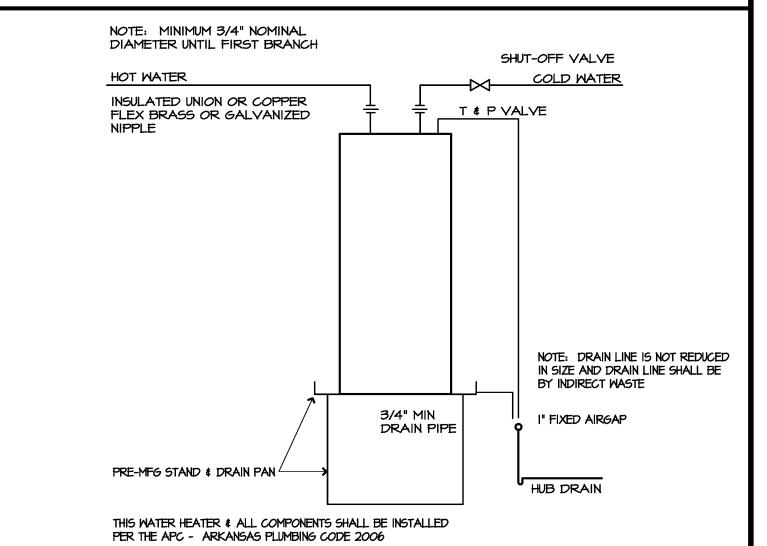- (I) MHI
- (2) FIXTURE SUPPLIES & DRAIN SHALL EXTEND NO MORE THAN 6" OUT FROM WALL & SHALL PROVIDE 29" MIN. FLOOR TO BOTTOM 29" CLEAR UNDER MIN, SINK RIM 34"H MAX SEE MILLWORK FOR REF
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HEAD NEW MULTI-FAMILY ELDERLY DEVELOPMENT FOR:

1. THE MEN MULTI-FAMILY ELDERLY DEVELOPMENT FOR:

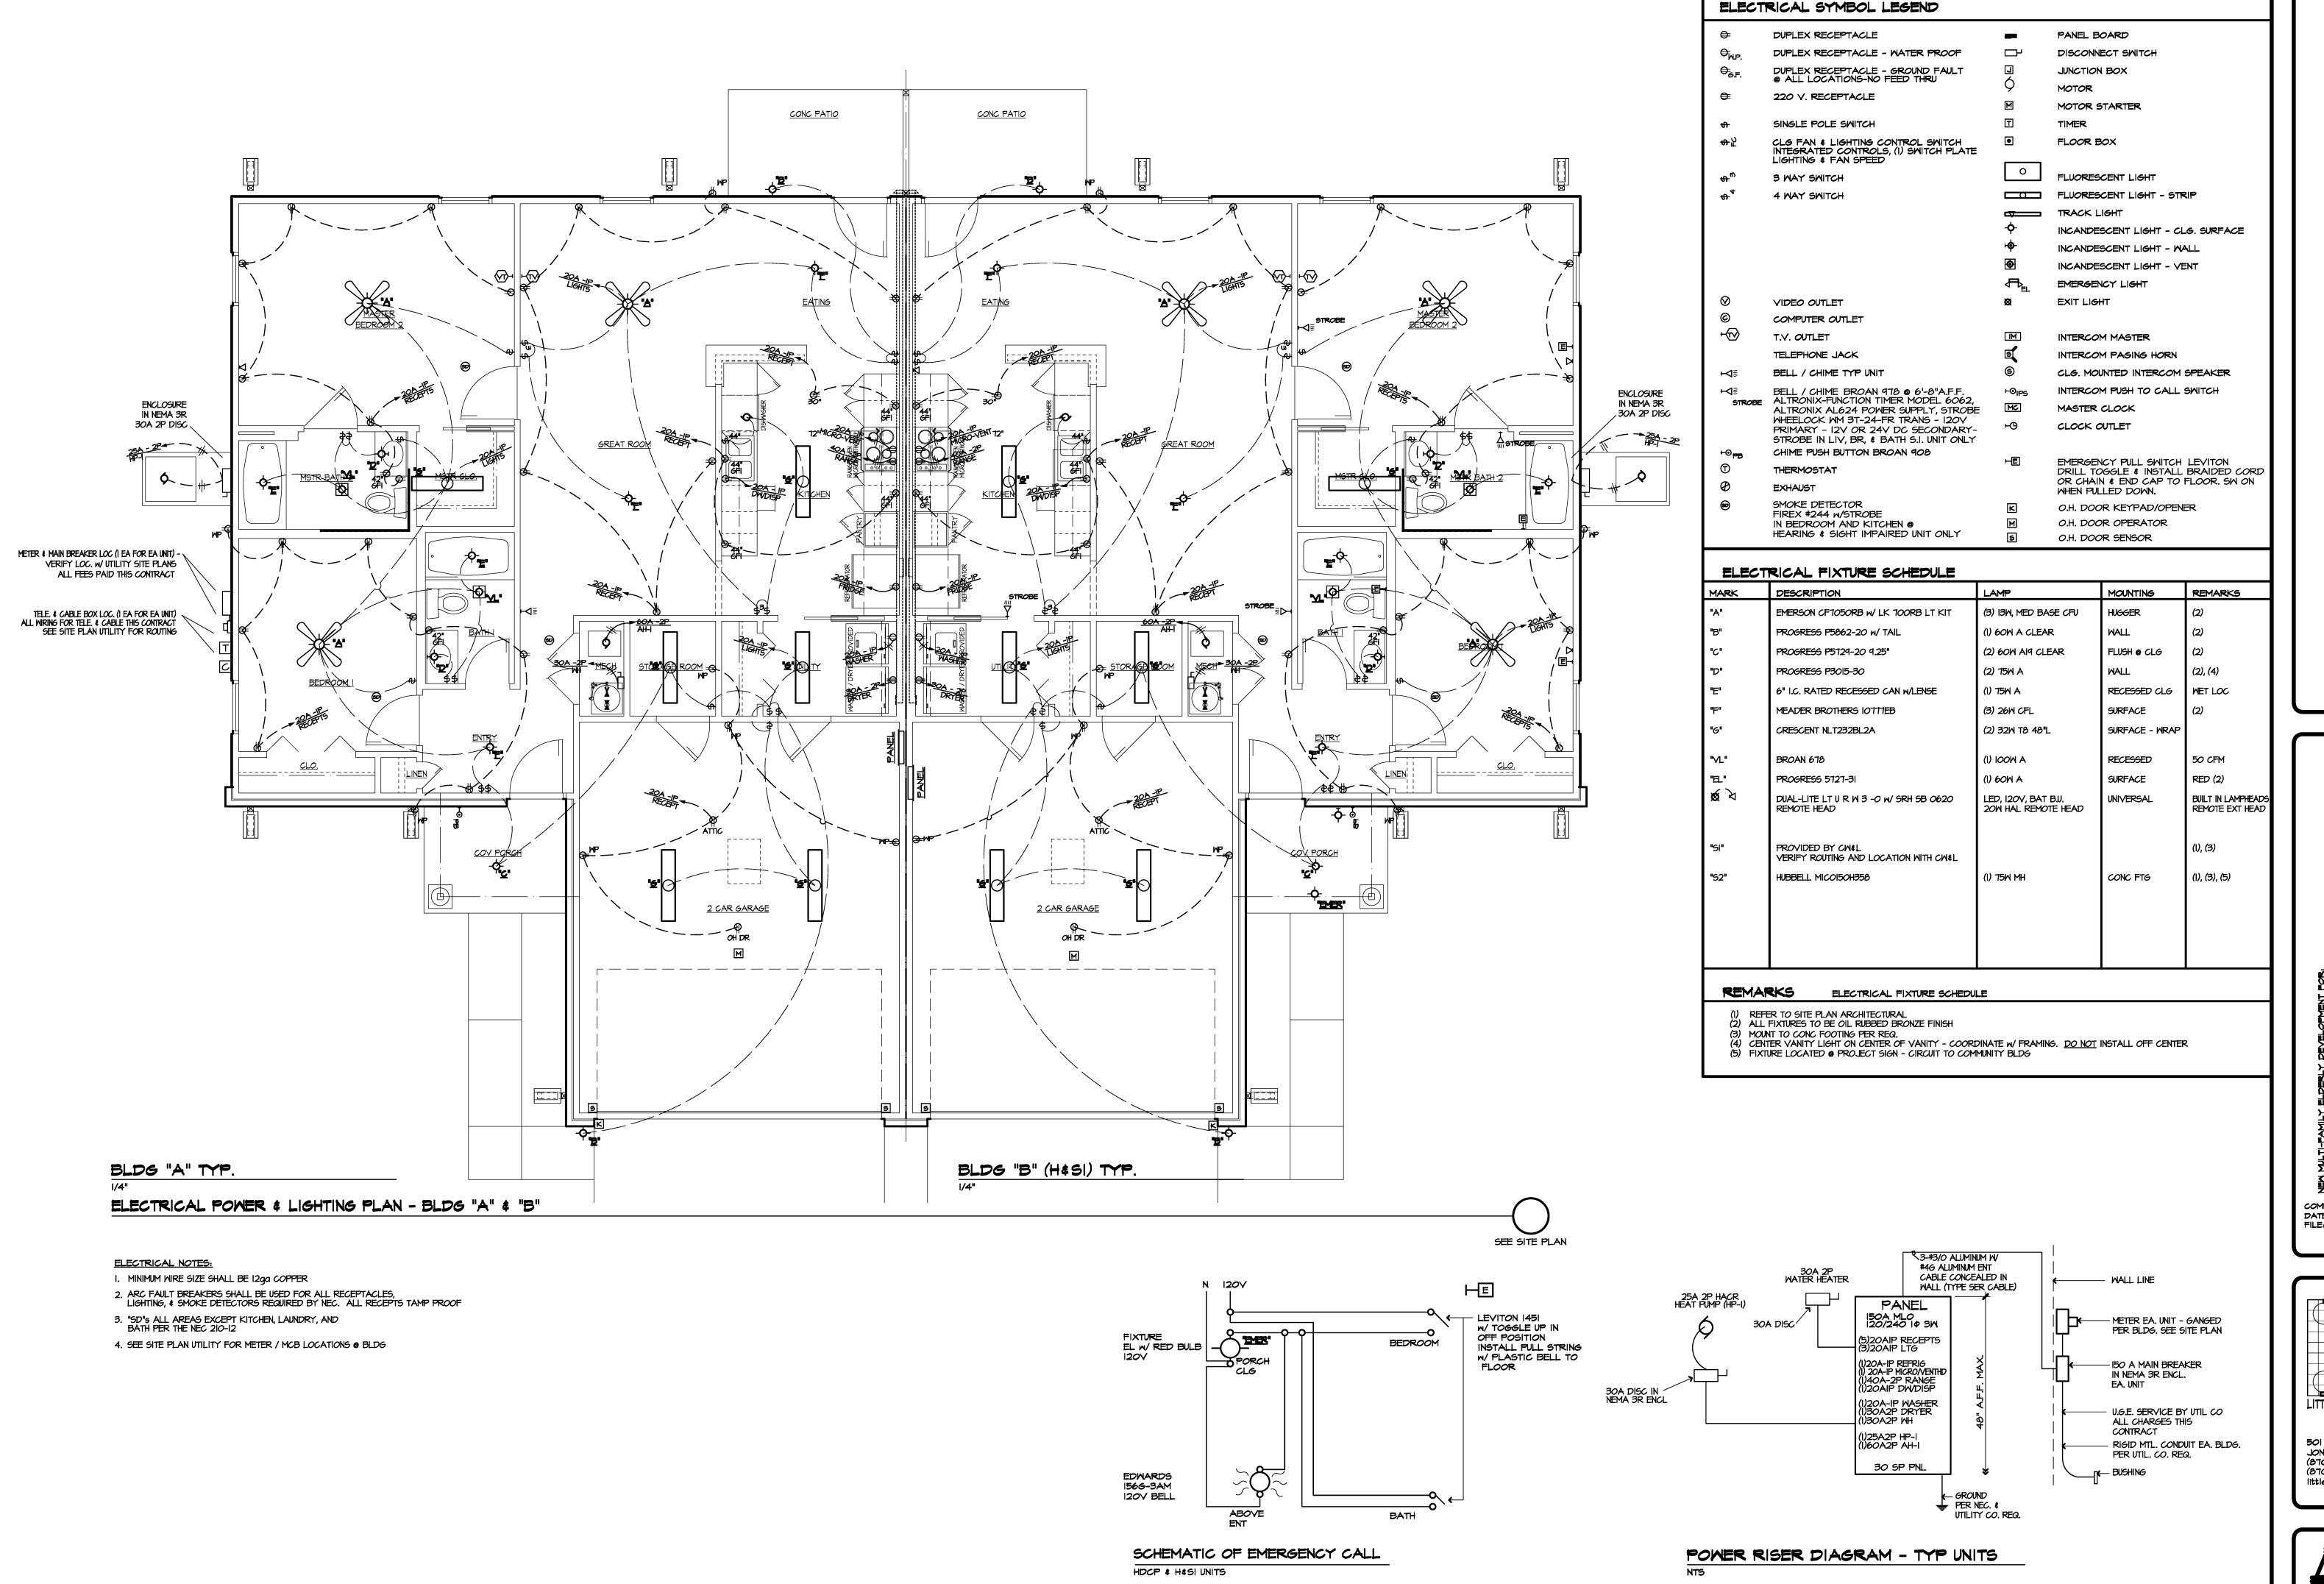
1. THE MALTI-FAMILY ELDERLY DEVELOPMENT FOR:

1. THE MEN MULTI-FAMILY ELDERLY ELDE



LITTLE & ASSOCIATES





Lectrical power & Lighting Plan - Bldg "A" & "E Lectrical power riser diagram

HEN MULTI-FAMILY ELDERLY DEVELOPMENT FOR:


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LITTLE & ASSOCIATES
ARCHITECTS

SOI UNION
JONESBORO, AR
(870) 930-3813 TEL

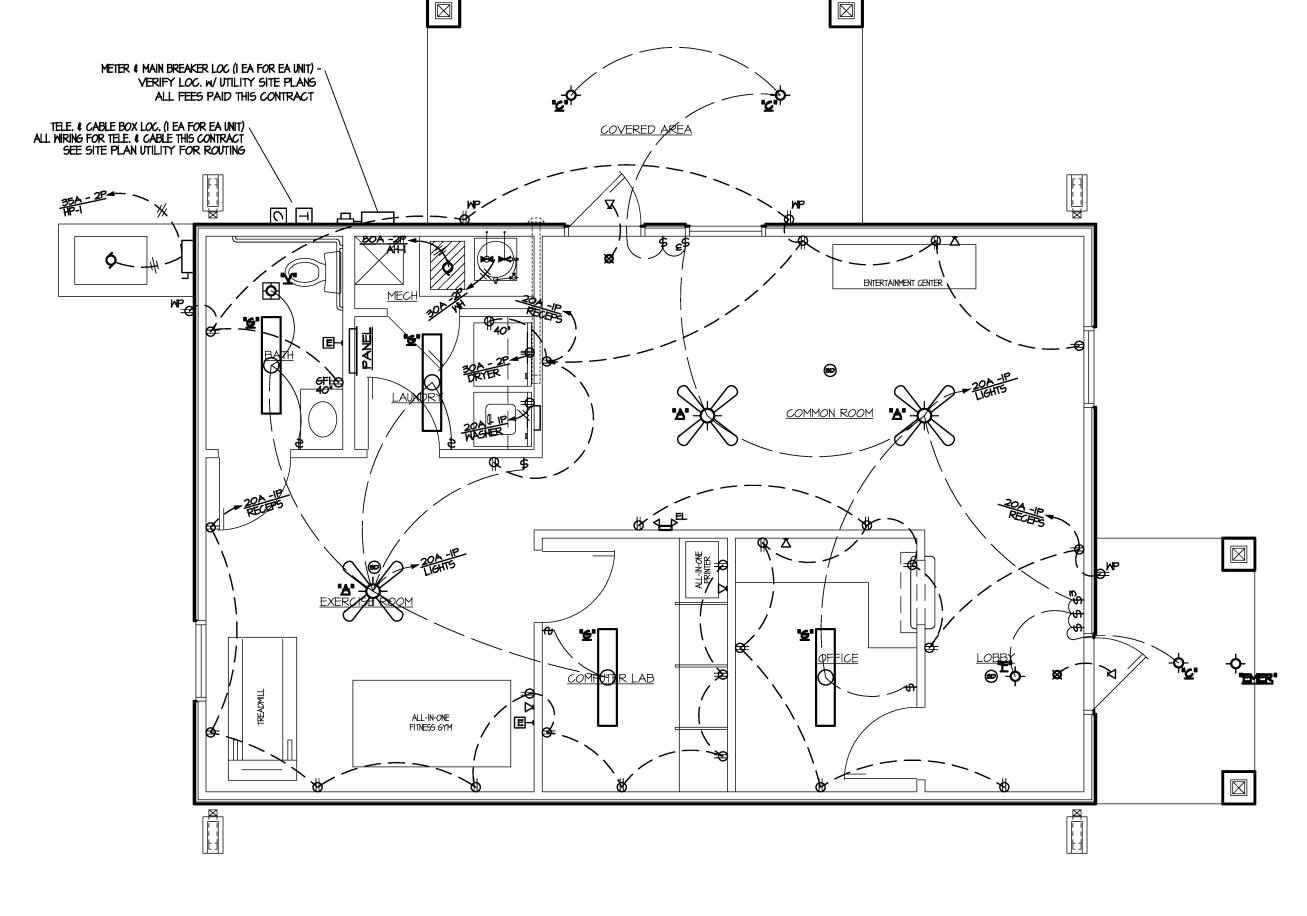(670) 930-3820 FAX littlearchesboglobal.net







# ELECTRICAL NOTES:

- I. MINIMUM WIRE SIZE SHALL BE 12ga COPPER
- ARC FAULT BREAKERS SHALL BE USED FOR ALL RECEPTACLES, LIGHTING, \$ SMOKE DETECTORS REQUIRED BY NEC. ALL RECEPTS TAMP PROOF
- 3. "SD"s ALL AREAS EXCEPT KITCHEN, LAUNDRY, AND BATH PER THE NEC 210-12
- 4. SEE SITE PLAN UTILITY FOR METER / MCB LOCATIONS @ BLDG

### ELECTRICAL FIXTURE SCHEDULE DESCRIPTION REMARKS MOUNTING EMERSON CF7050RB w/ LK 700RB LT KIT (3) I3W, MED BASE CFU HUGGER PROGRESS P5862-20 w/ TAIL (1) 60W A CLEAR (2) 60W AI9 CLEAR PROGRESS P5729-20 9.25" FLUSH @ CLG (2) 75W A PROGRESS P3015-30 6" I.C. RATED RECESSED CAN W/LENSE (1) 75W A RECESSED CLG WET LOC SURFACE MEADER BROTHERS IOTITIEB (3) 26W CFL CRESCENT NLT232BL2A (2) 32W T8 48"L SURFACE - WRAP BROAN 678 (1) 100M A 50 CFM RECESSED PROGRESS 5727-31 (1) 60W A SURFACE RED (2) DUAL-LITE LT U R W 3 -O w/ SRH SB 0620 LED, 120V, BAT B.J. BUILT IN LAMPHEADS REMOTE HEAD 20M HAL REMOTE HEAD REMOTE EXT HEAD PROVIDED BY CH&L (1), (3) VERIFY ROUTING AND LOCATION WITH CHEL HUBBELL MICOI50H358 (1) 75W MH CONC FTG (1), (3), (5)

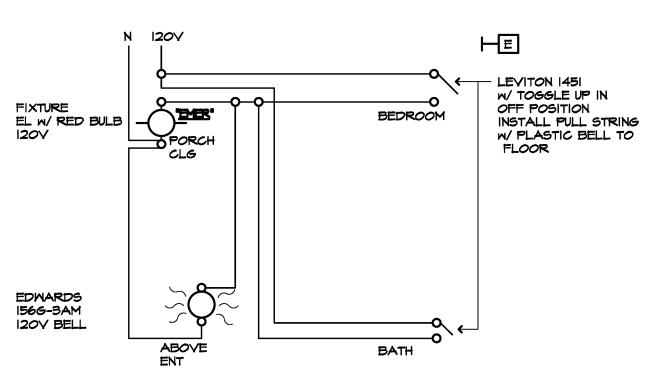
REMARKS ELECTRICAL FIXTURE SCHEDULE

(I) REFER TO SITE PLAN ARCHITECTURAL

ELECTRICAL SYMBOL LEGEND


- (2) ALL FIXTURES TO BE OIL RUBBED BRONZE FINISH (3) MOUNT TO CONC FOOTING PER REQ.
- (4) CENTER VANITY LIGHT ON CENTER OF VANITY COORDINATE W/ FRAMING. DO NOT INSTALL OFF CENTER

(5) FIXTURE LOCATED @ PROJECT SIGN - CIRCUIT TO COMMUNITY BLDG




SCHEMATIC OF EMERGENCY CALL

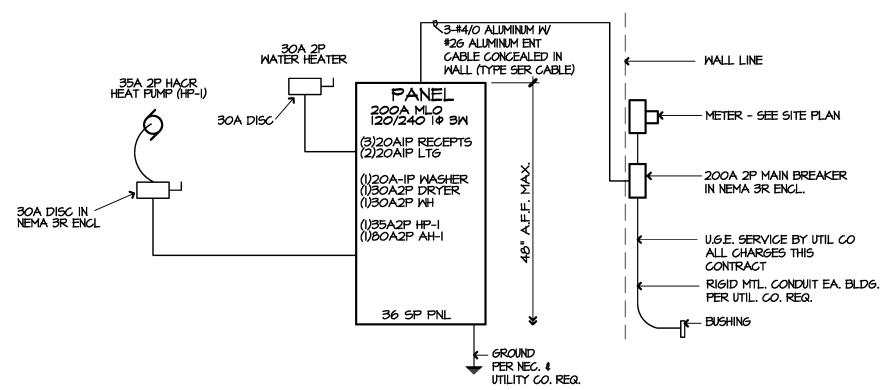HDCP & H&SI UNITS



POWER RISER DIAGRAM - COMMUNITY BLDG

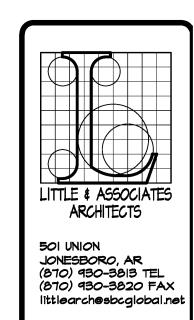
NTS





DATE : 6/20/16 FILE:

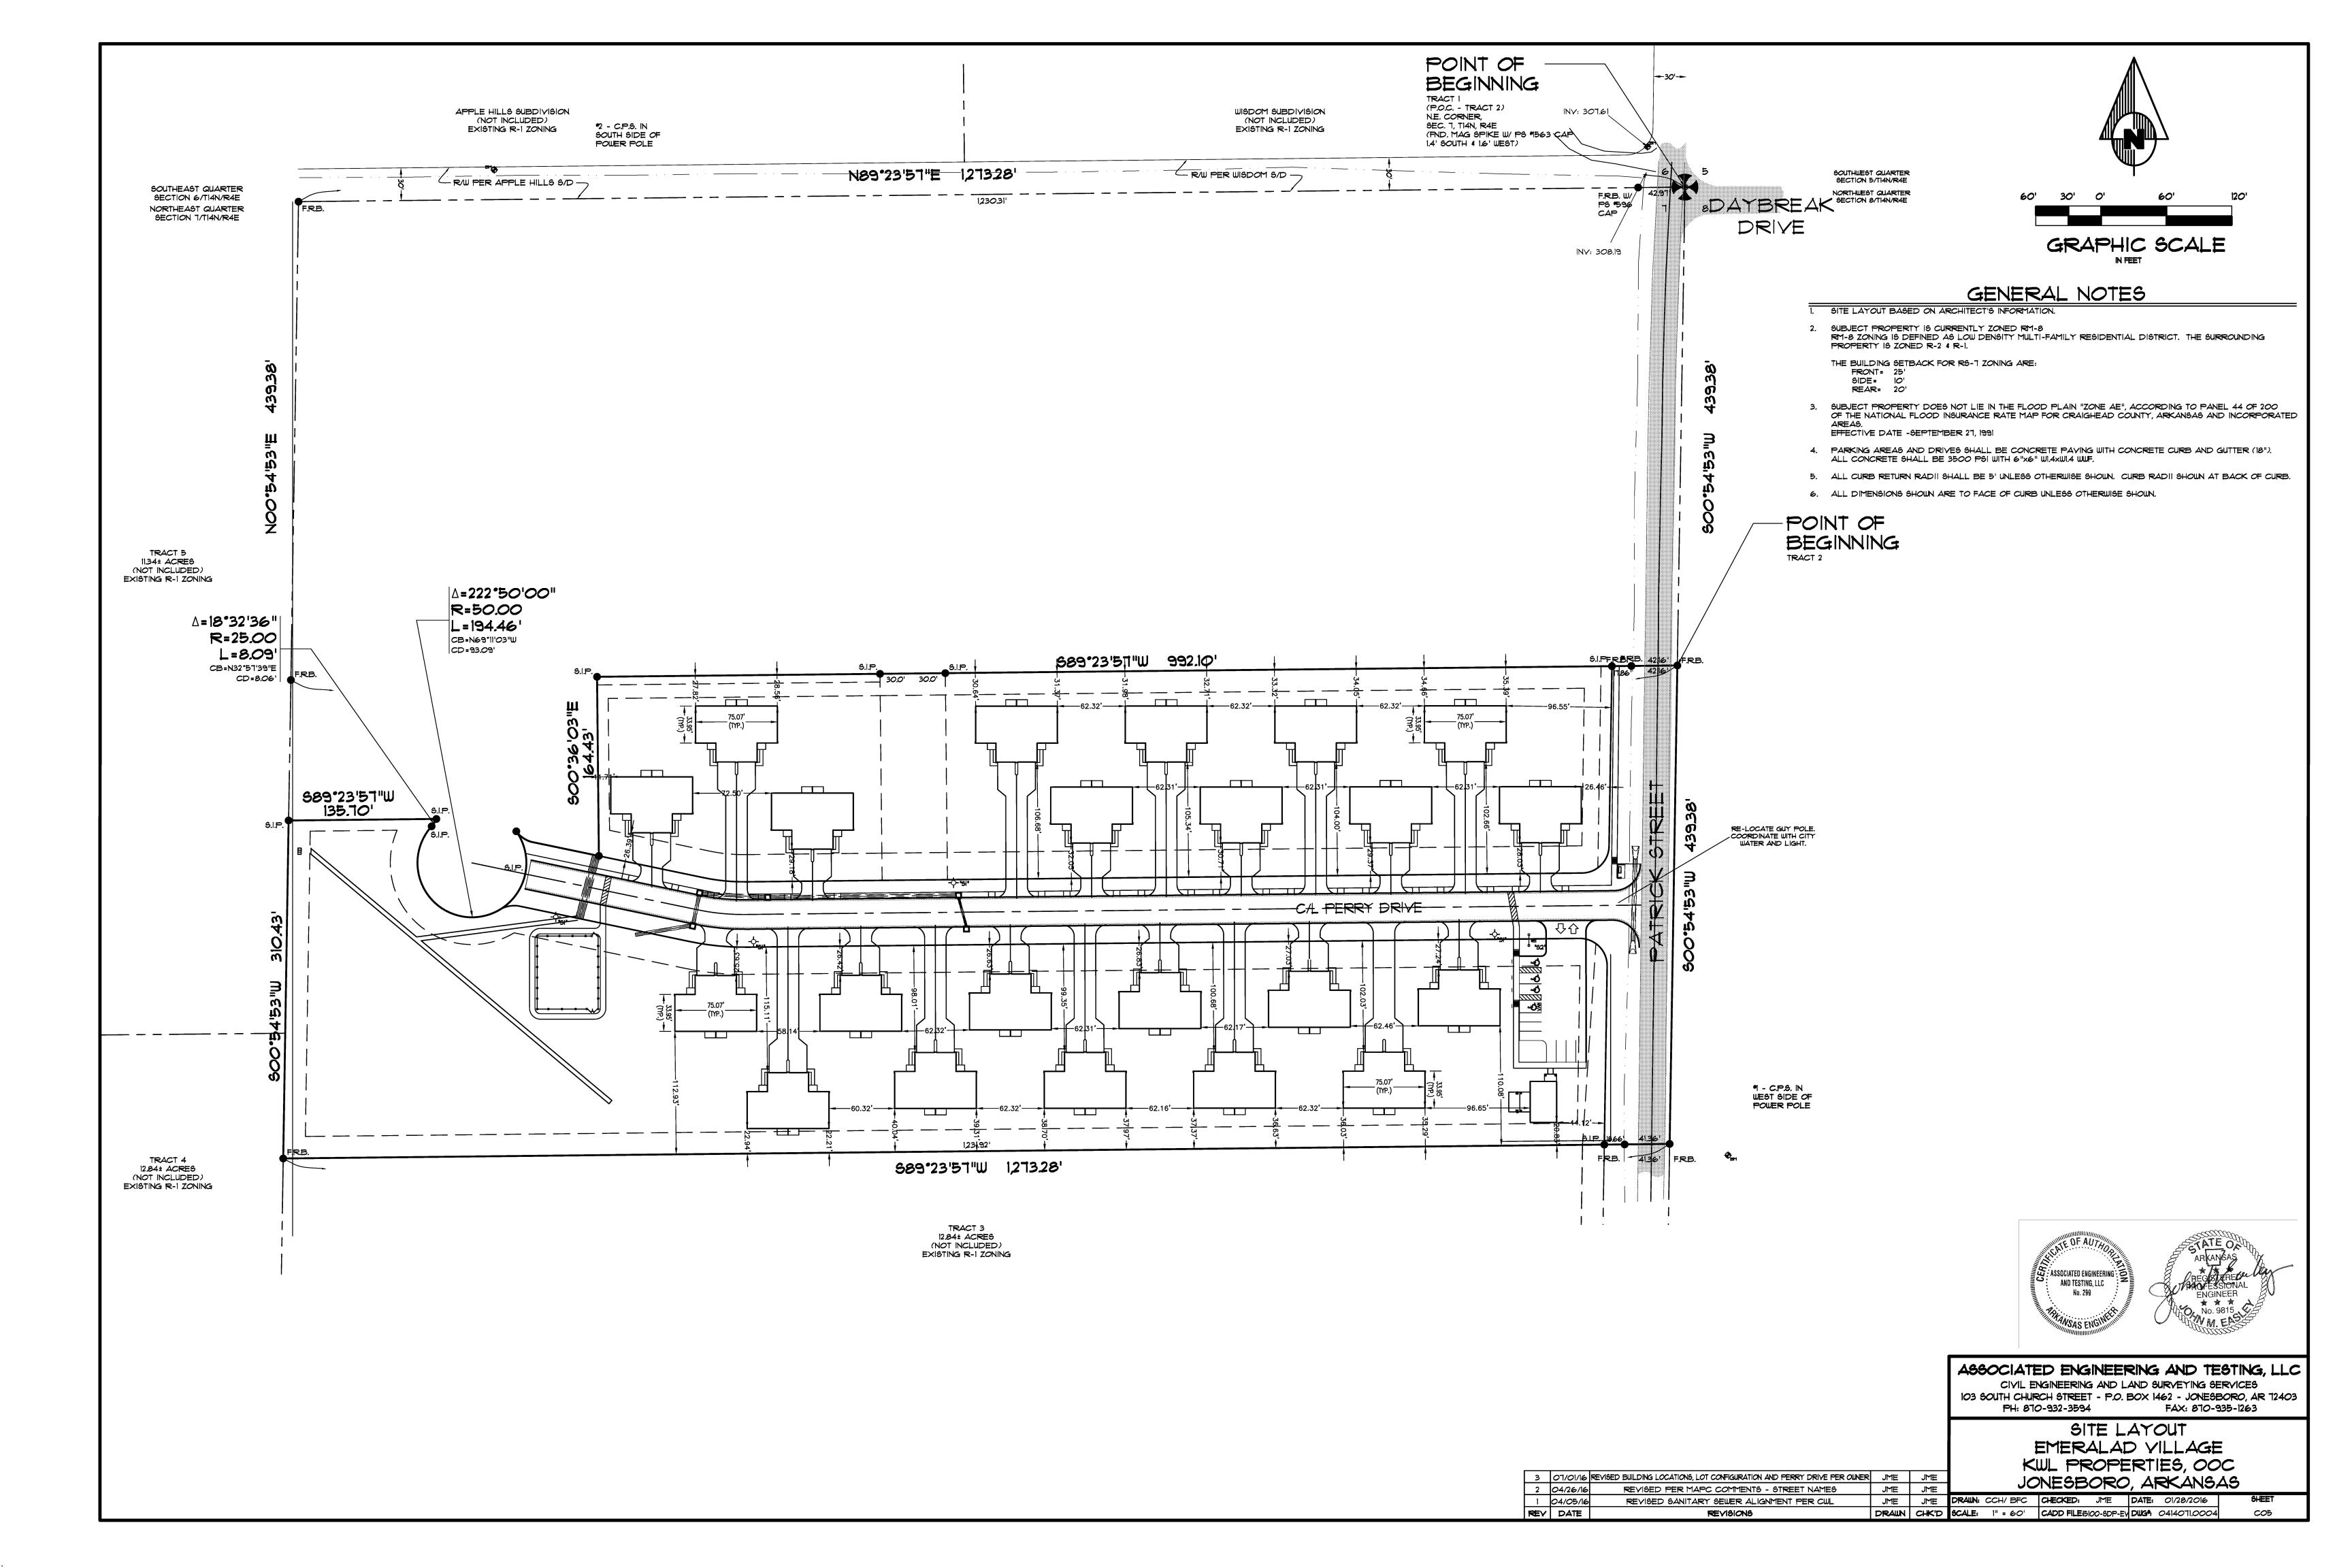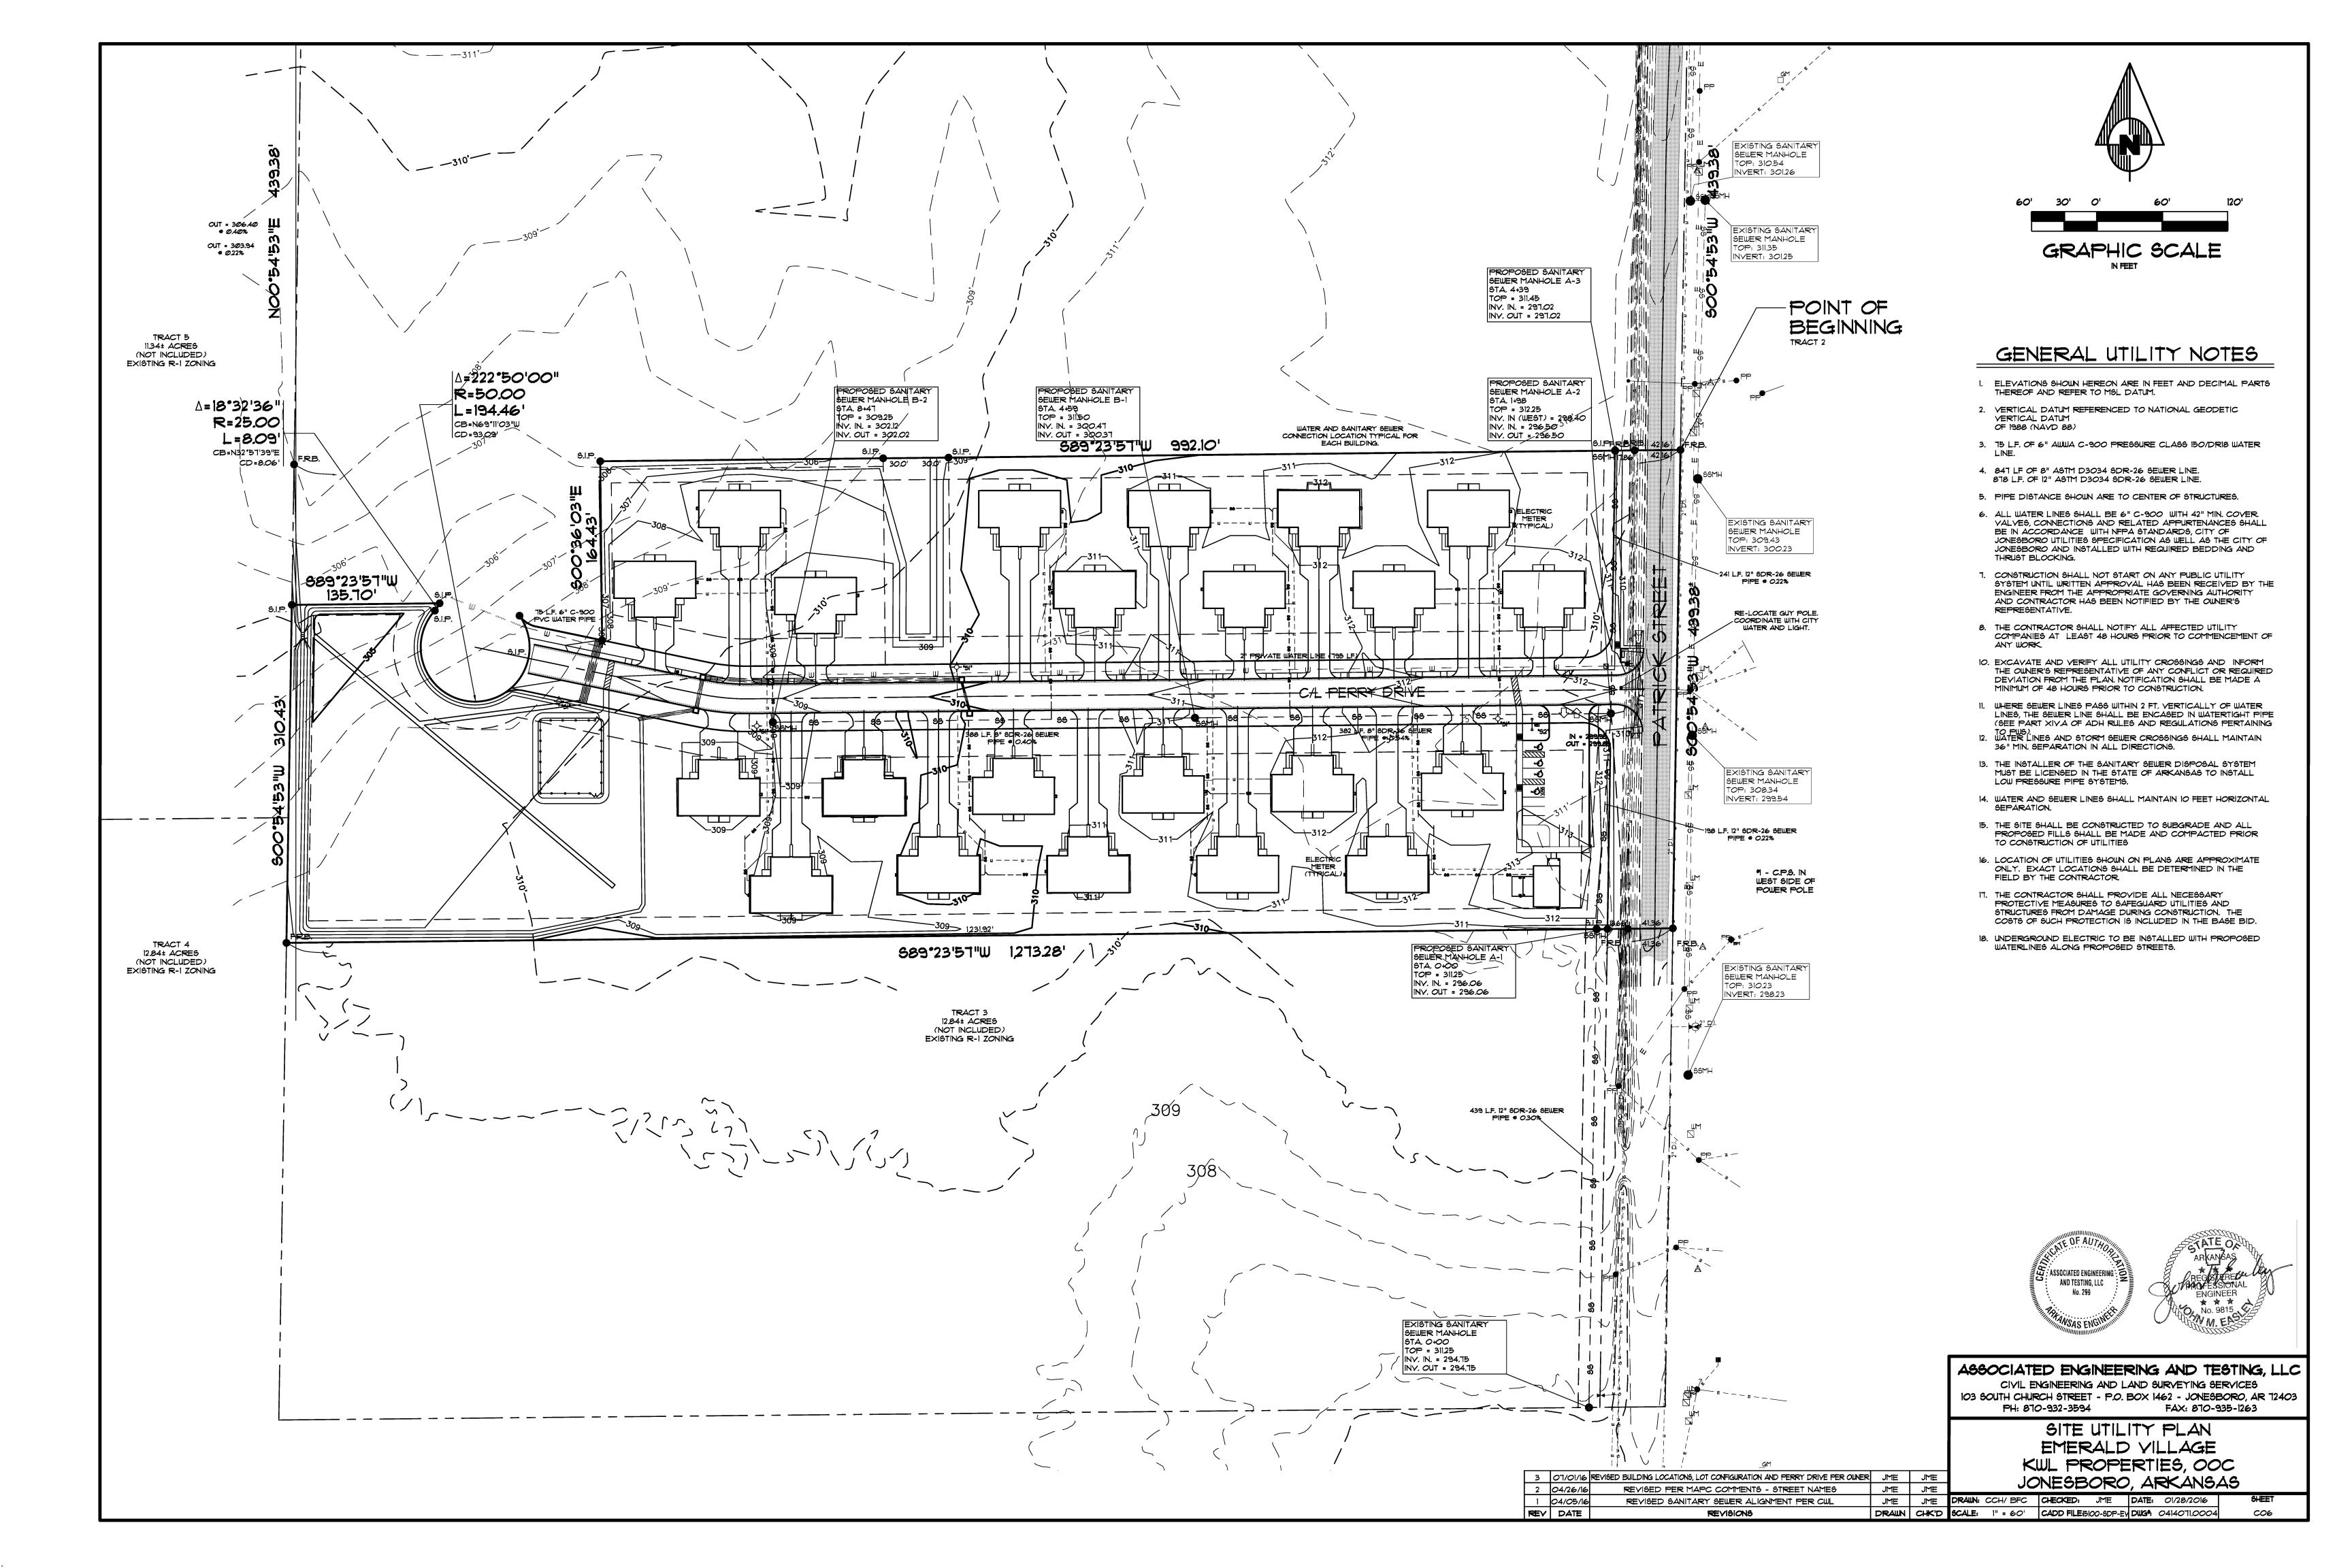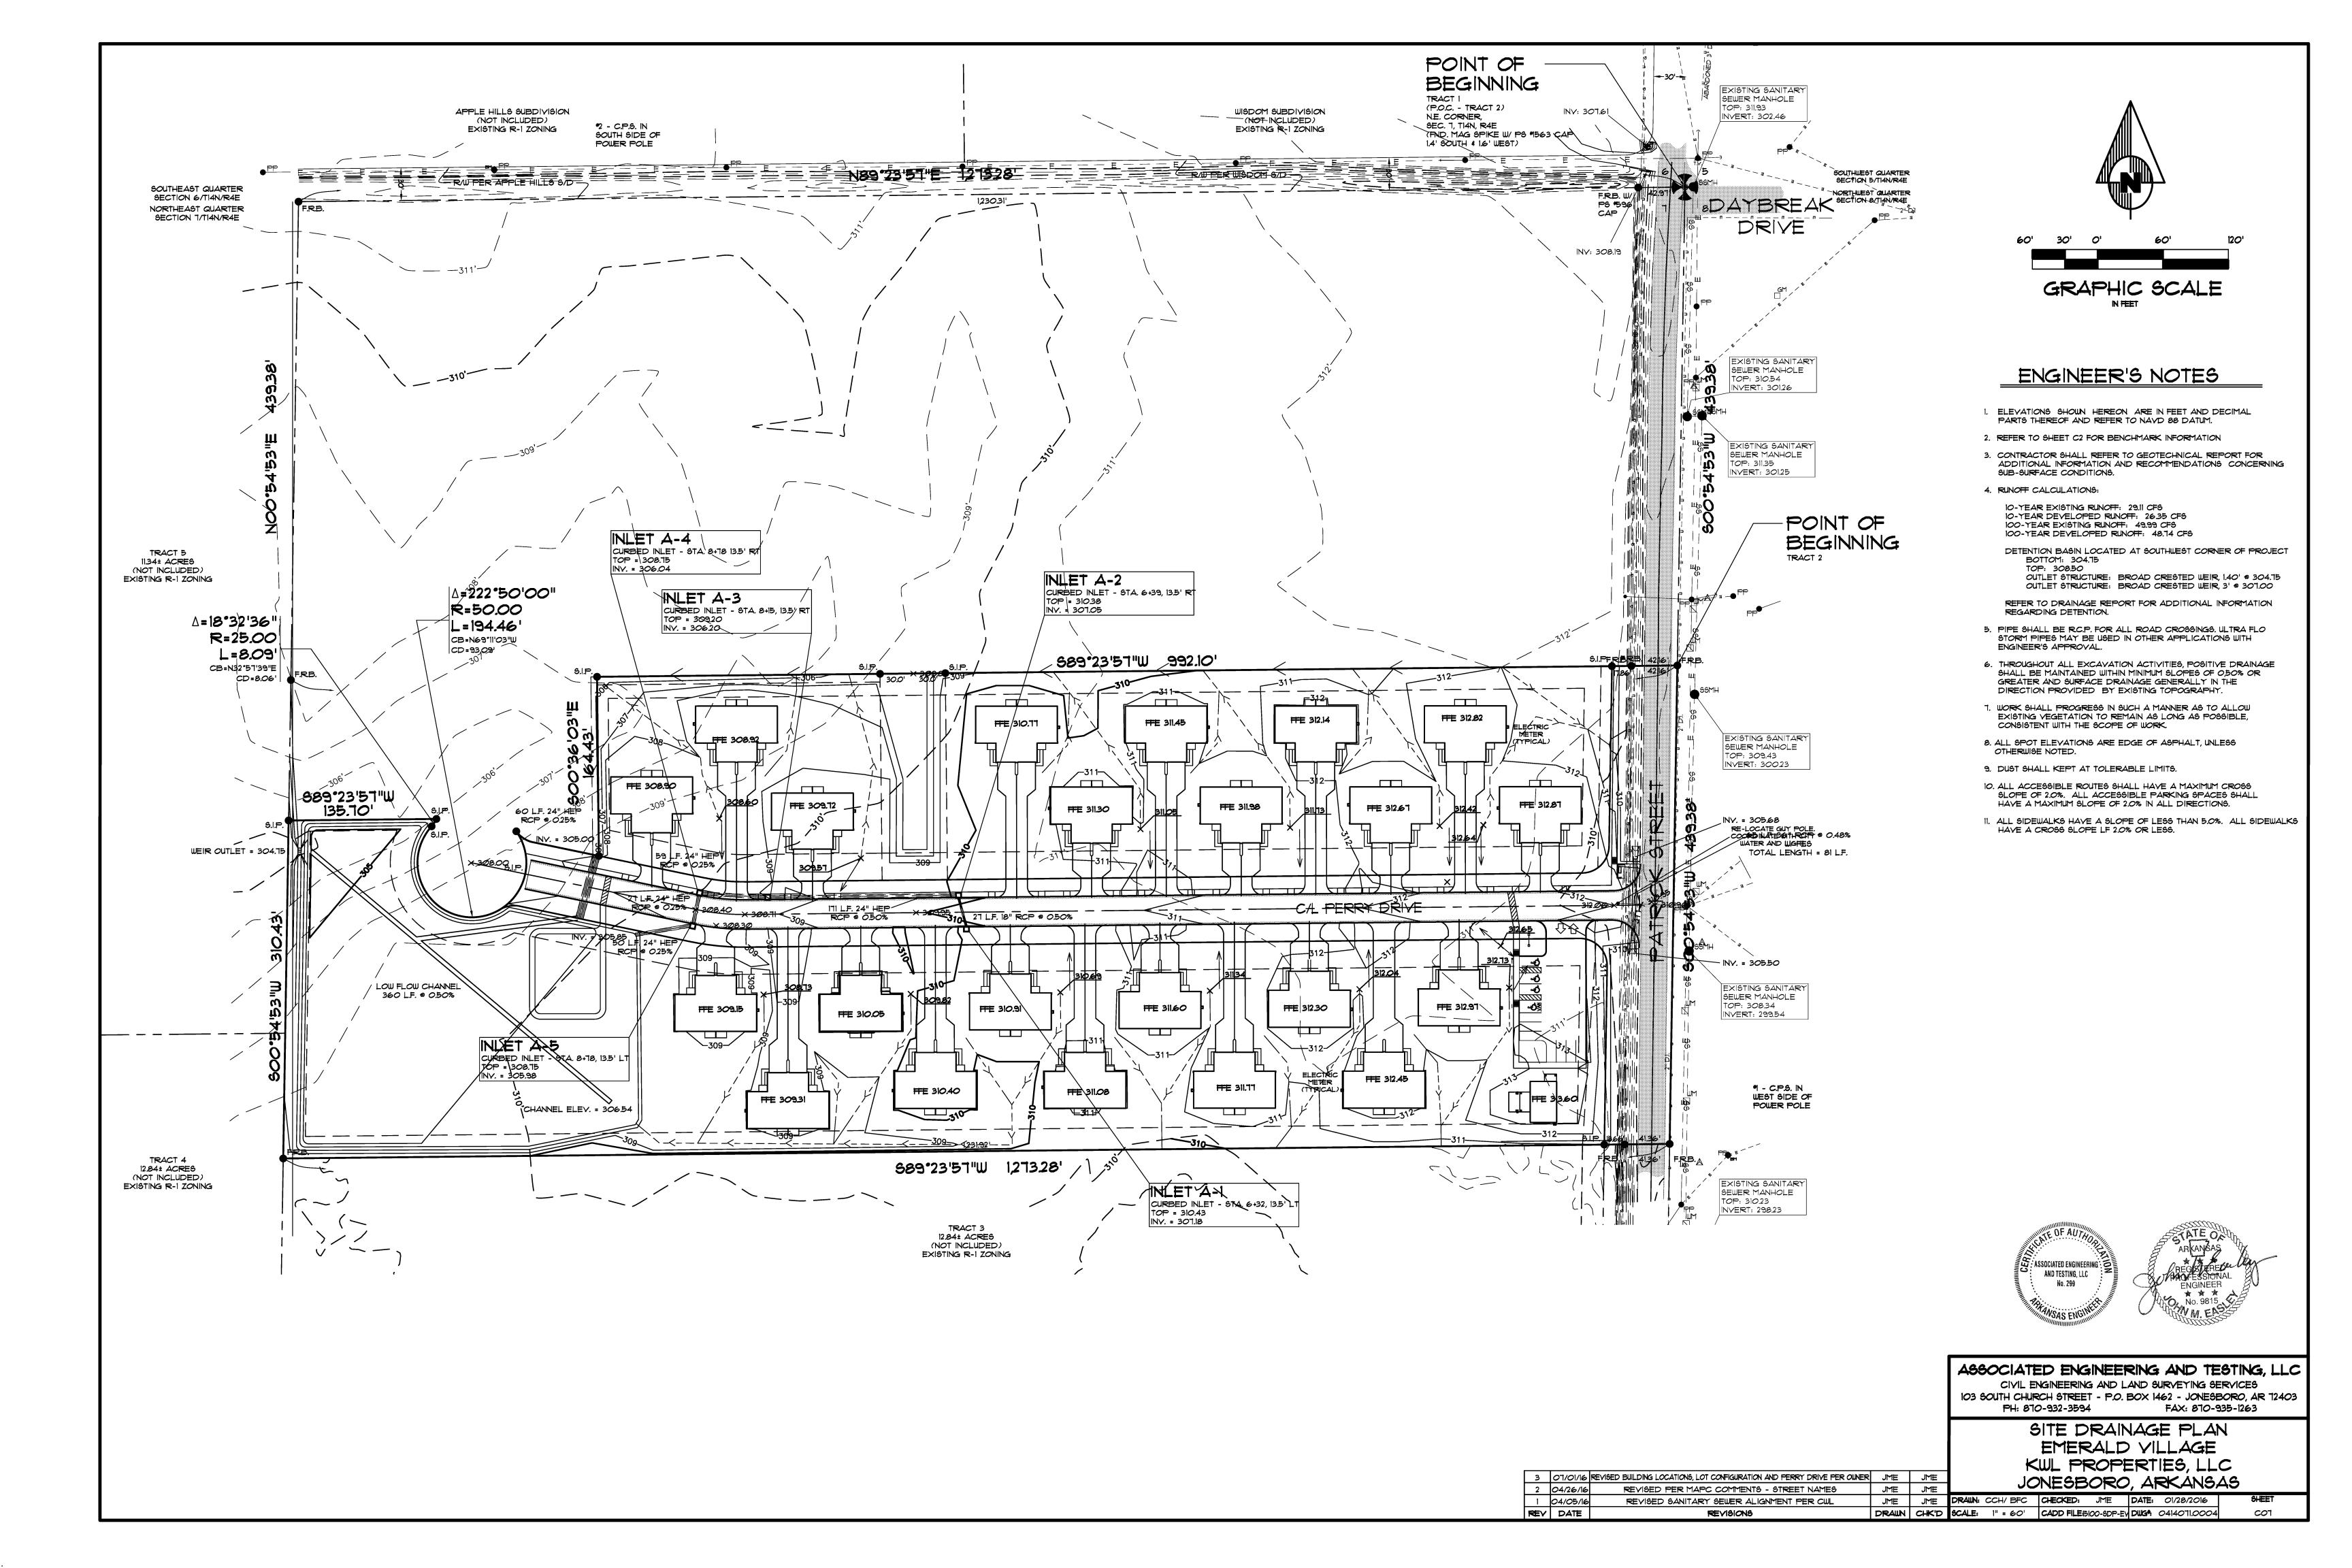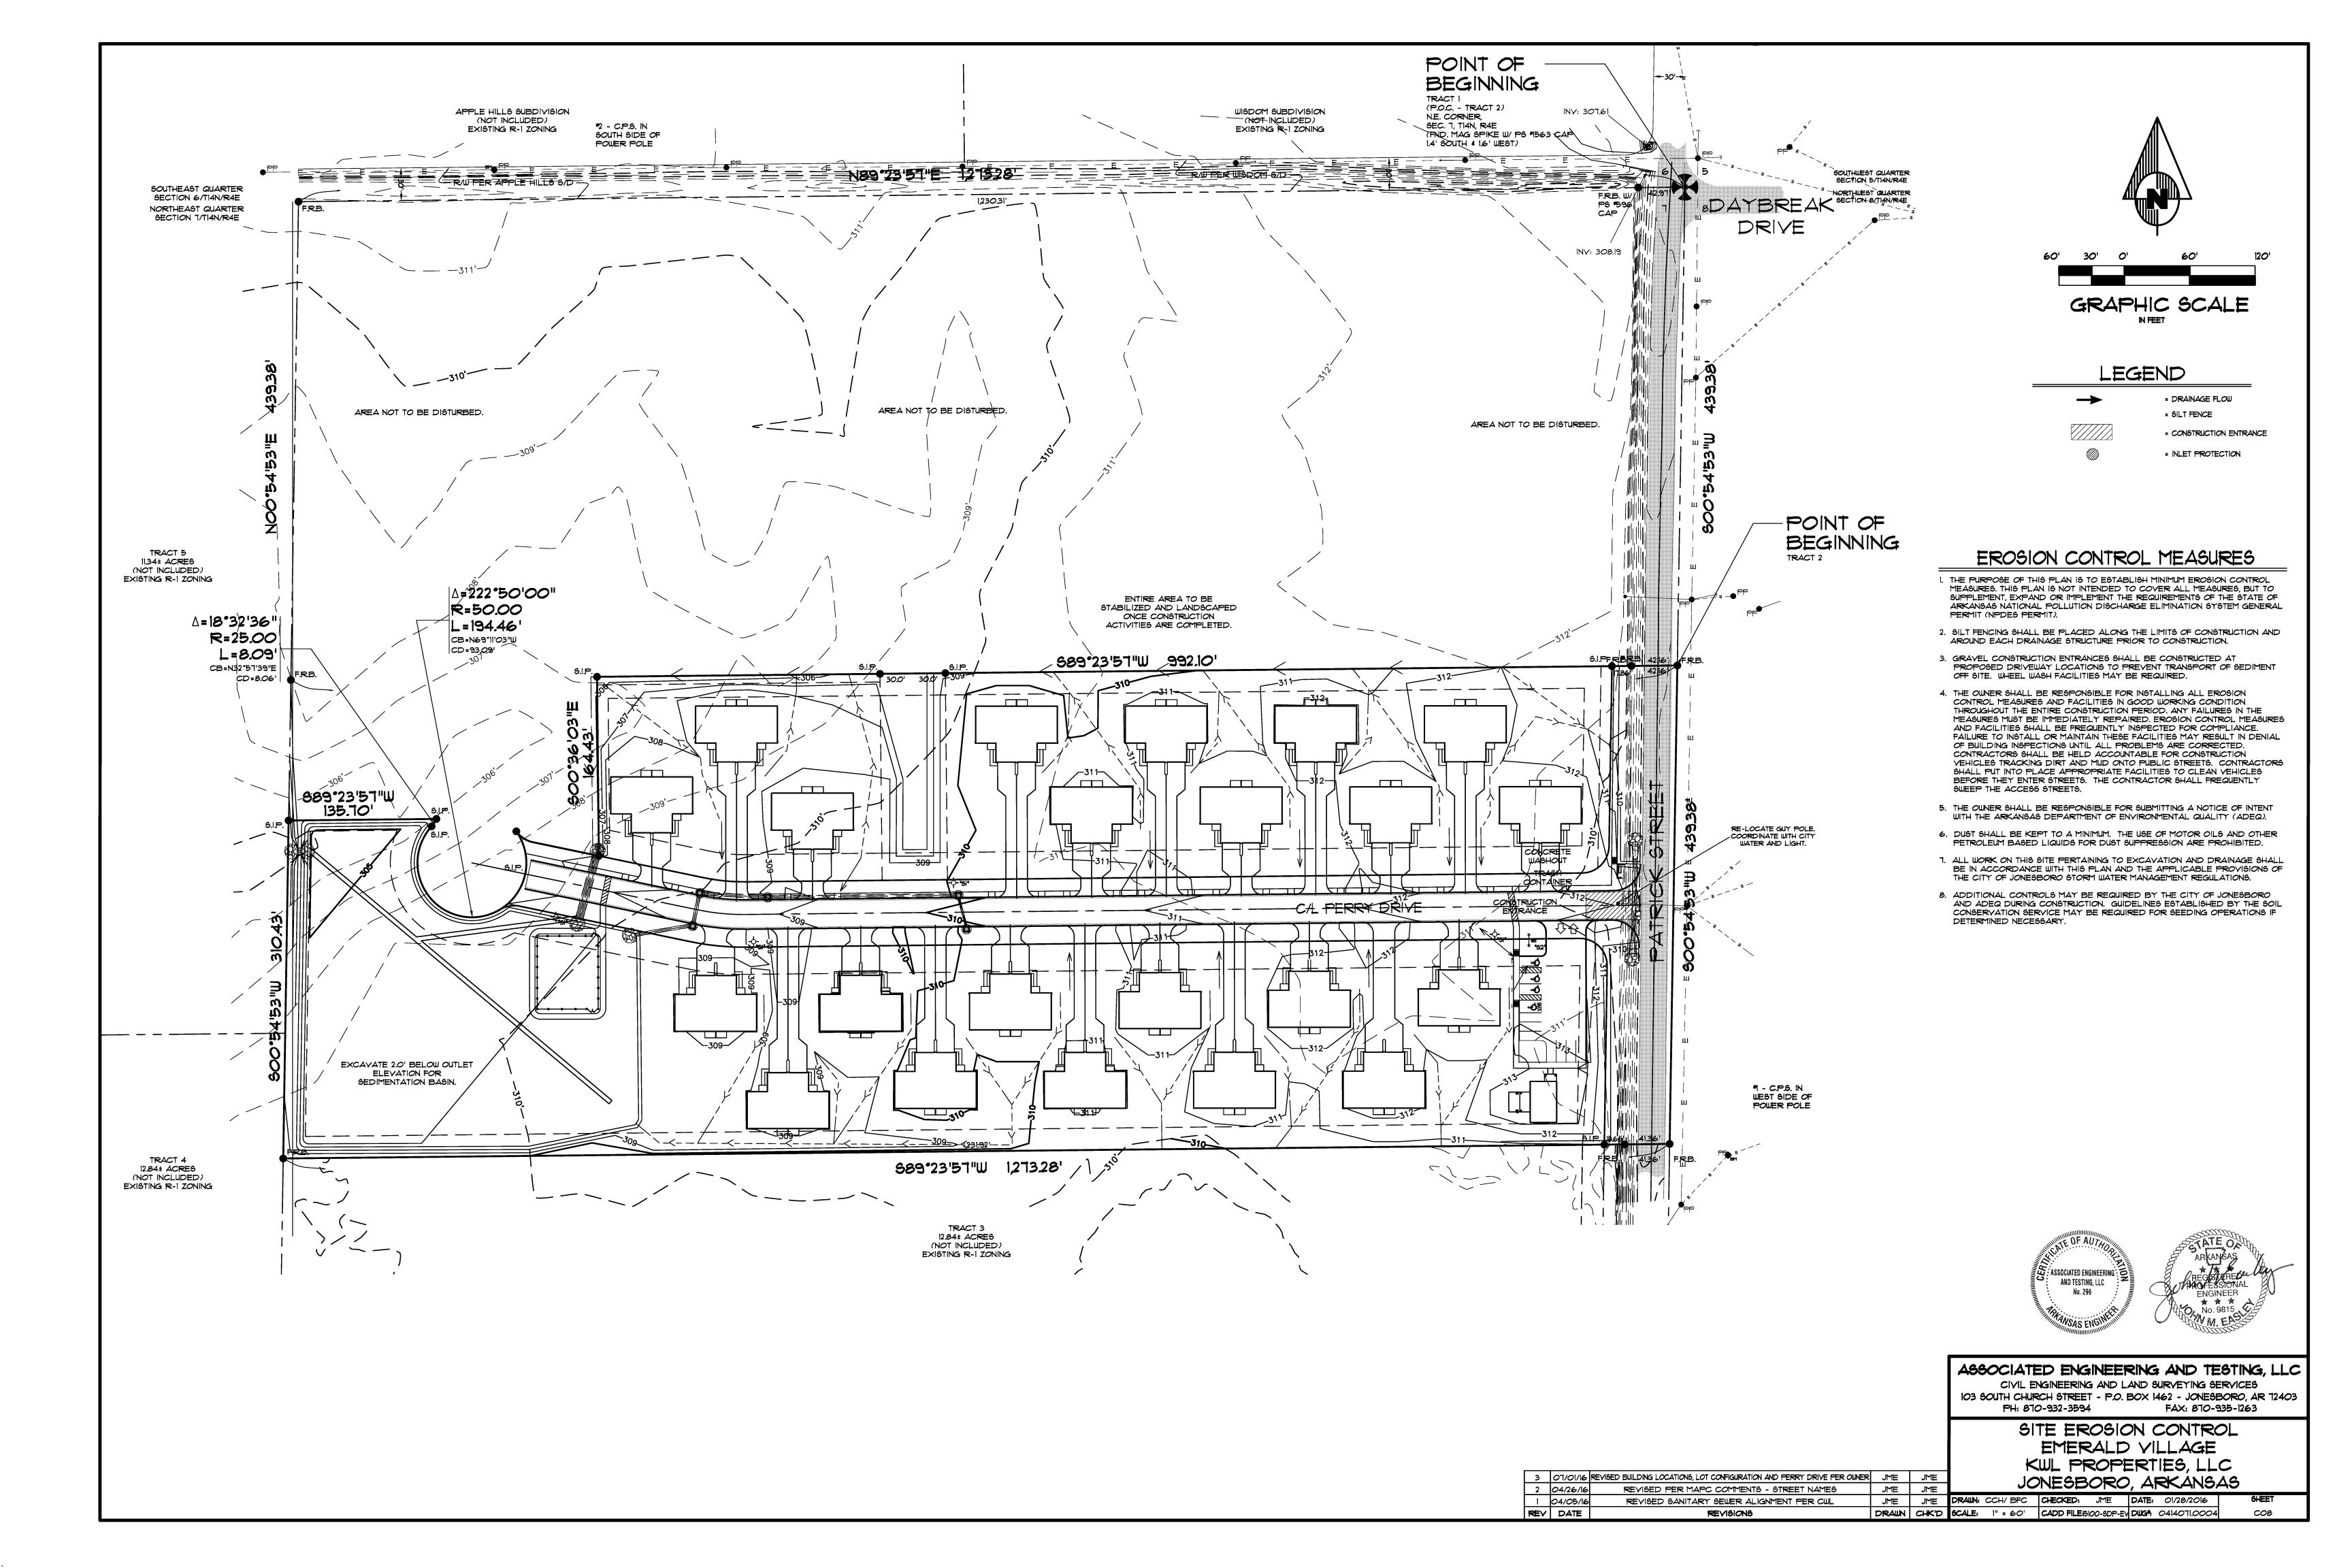
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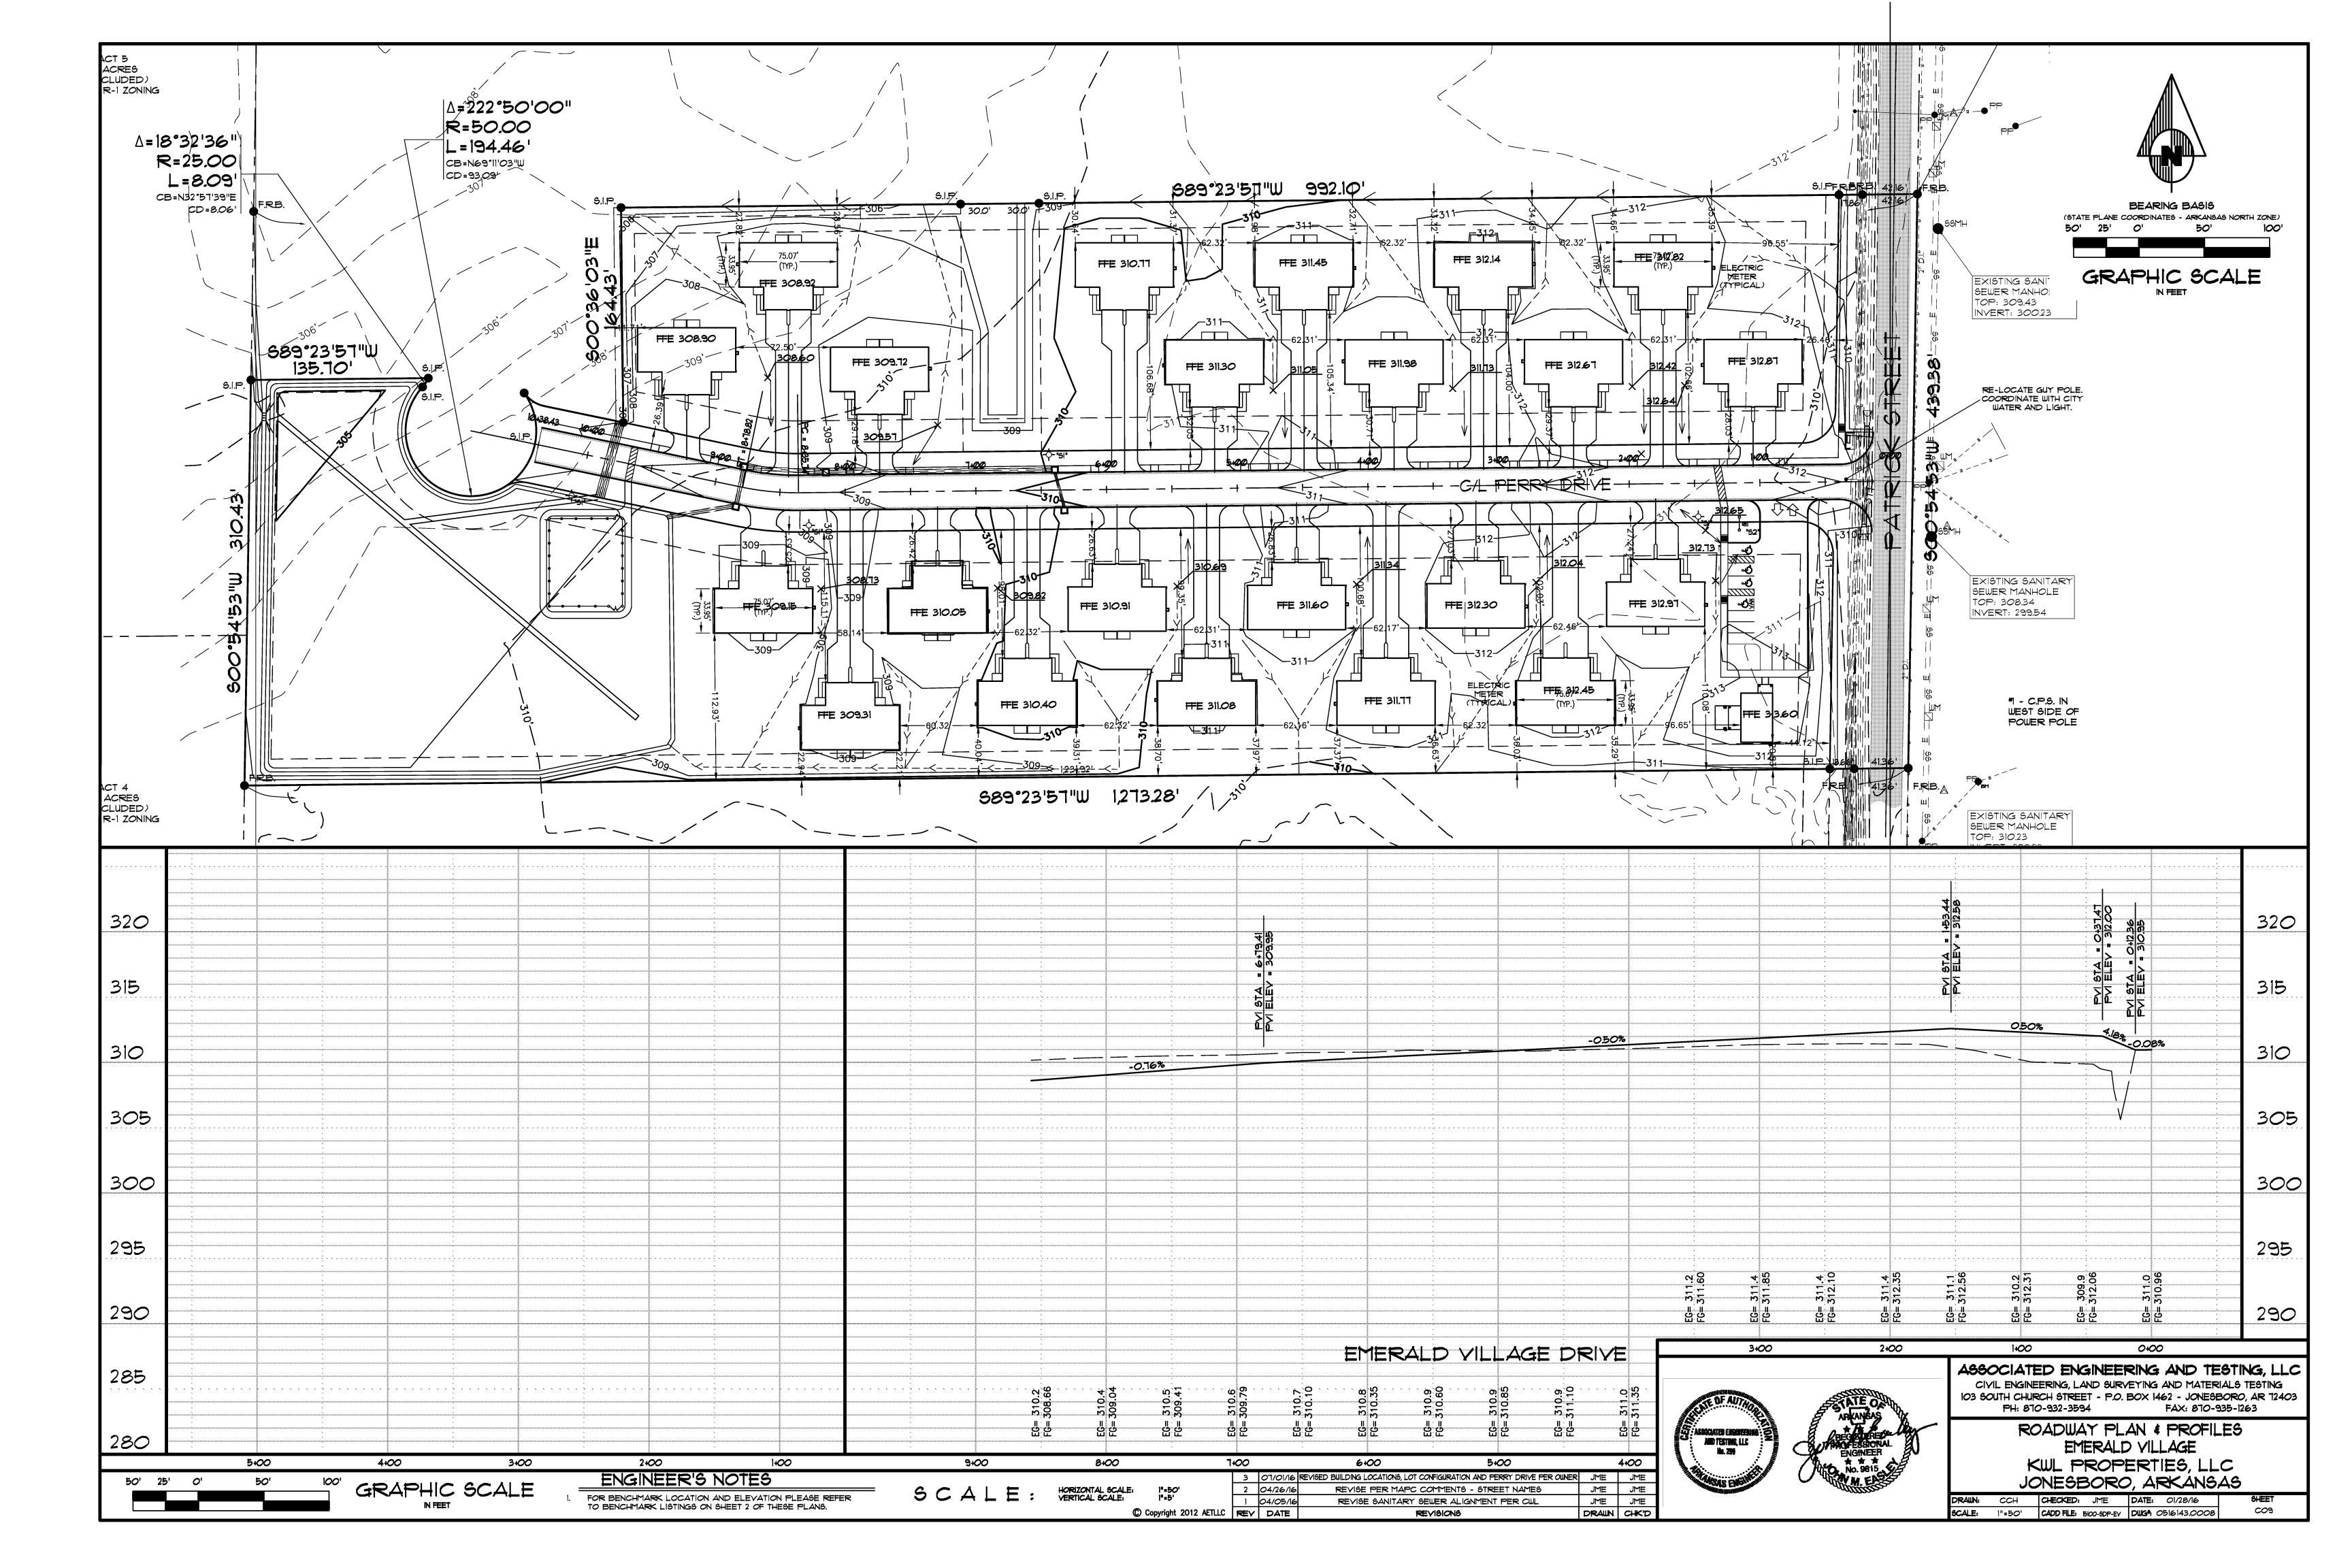


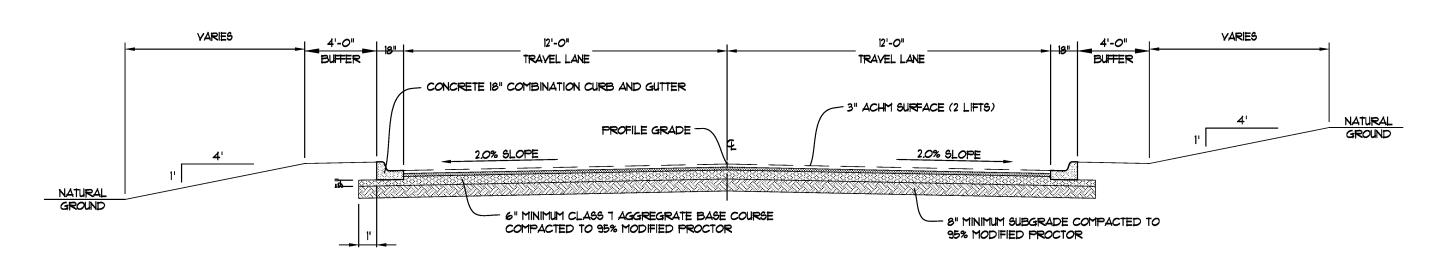













# LOCAL STREET SECTION

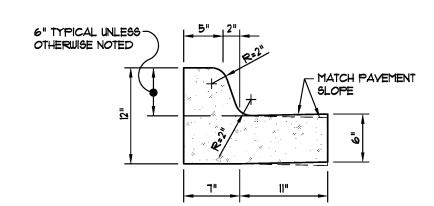SCALE: NONE



NOTE: CONTRACTION AND EXPANSION JOINTS SHALL BE CONSTRUCTED IN ACCORDANCE WITH THE PLANS AND SPECIFICATIONS.

PLAN VIEW

SECTION "X-X"

CURB CHANNEL (NOT TO SCALE)

#5 BARS

DIAGONAL

O.C. EA.

2-16 CONT.

SLOPE FLOOR

DISCHARGE

TO POINT OF -

LARGEST PIPE WALL

THICKNESS + 6"

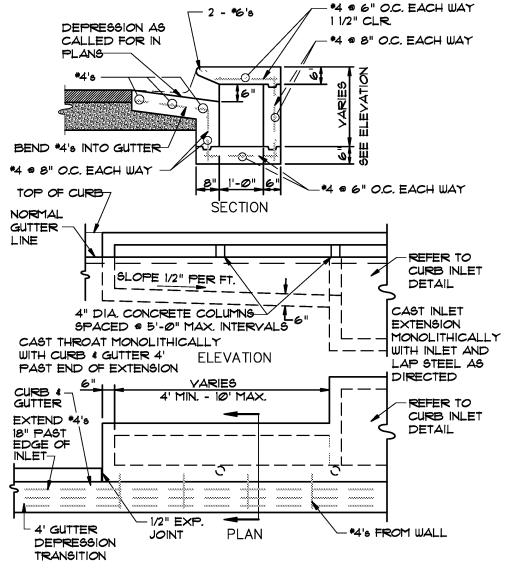
#5's FROM WALL ----

— 1/2" EXPANSION JOINT →

4'-0" MIN.

FRONT ELEVATION

WAY -



CURB INLET EXTENSION

← 4" DIA. NOSING

NORMAL GUTTER

SHAPE -

BEND #5's

FROM WALL

INTO GUTTER -

# 4's

EXTEND BASE

SUBGRADE -

OUTLET PIPE -

SEE PLANS

COURSE UNDER

RING & COVER

CAST THROAT

W/ CURB AND

SIDE OF INLET

EXTEND #4's 18" PAST

EDGE OF INLET-BOTH SIDES

TRANSITION GUTTER

PLACE 1/2" EXP. JT. BETWEEN INLETS AND CURB AND SIDEWALK

CURB INLET - TYPE "A"

INLET IN 4 FEET.
TYP. BOTH SIDES

NOTE:

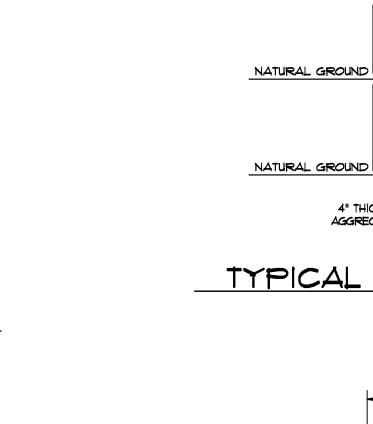
SLABS

TO 4" DEPRESSION AT

MONOLITHICALLY

GUTTER 4' EACH

- CURB & GUTTER



TYPICAL SECTION - SIDEWALK AT CURB

4" THICK CRUSHED LIMESTONE OR -

AGGREGATE BASE COURSE CLASS 8

1' 5'-O" (UNLESS NOTED

OTHERWISE

ON PLANS)

2" CLEARANCE

2.0% SLOPE

(MAX.)

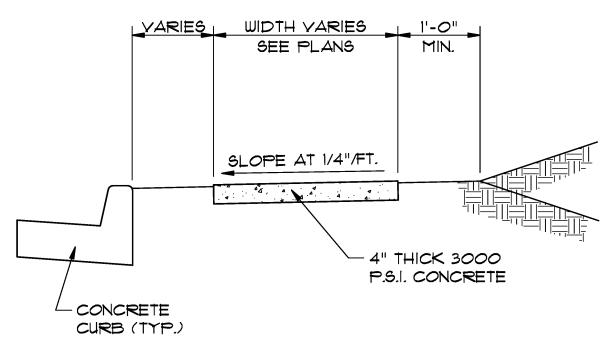
5" THICK CONCRETE SIDEWALK

(3000 PSI CONCRETE @ 28 DAYS)

CURB AND GUTTER


- CONCRETE COMBINATION

-R=3/8" (TYP.)




TYPICAL SECTION - SIDEWALK

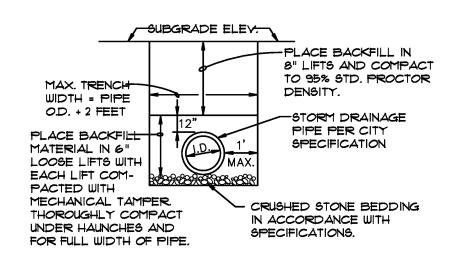\* MINIMUM WIDTH FOR SIDEWALK ADJACENT TO CURB IS 5' FOR CITY STREETS AND 6' FOR STATE OR U.S. HIGHWAYS.





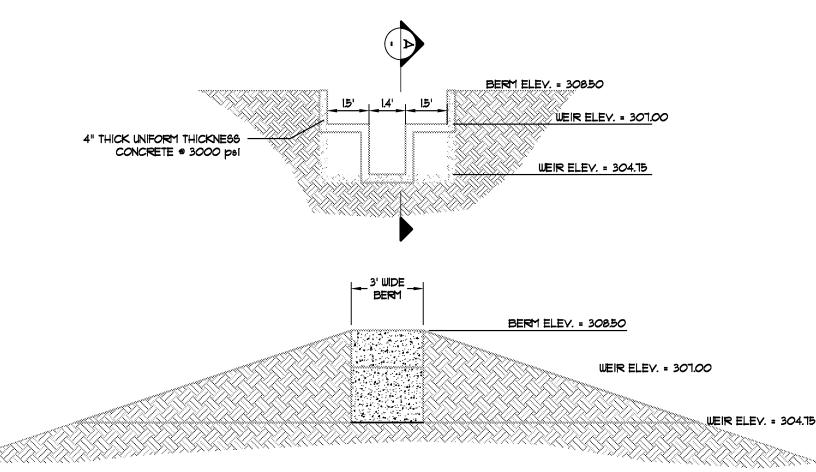NOTE: TO BE USED WITH NEW STREET CONSTRUCTION. SEE DRAWING NO. PT-1 FOR EXISTING STREET CUTS.



BROAD CRESTED WEIR DETAIL

SECTION "A-A"




ASSOCIATED ENGINEERING AND TESTING, LLC CIVIL ENGINEERING AND LAND SURVEYING SERVICES 103 SOUTH CHURCH STREET - P.O. BOX 1462 - JONESBORO, AR 12403 FAX: 870-935-1263 PH: 870-932-3594

> STANDARD DETAILS EMERALD VILLAGE KWL PROPERTIES, LLC

JONESBORO, ARKANSAS JME JME JME JME DRAWN: CCH CHECKED: JME DATE: 01/28/16 REVISED SANITARY SEWER ALIGNMENT PER CWL DRAWN CHK'D SCALE: AS SHOWN CADD FILESION-SDP-EY DUGA: 0414144.0015 REVISIONS

# TYPICAL CURB & GUTTER TYPE "A-18" (NOT TO SCALE)

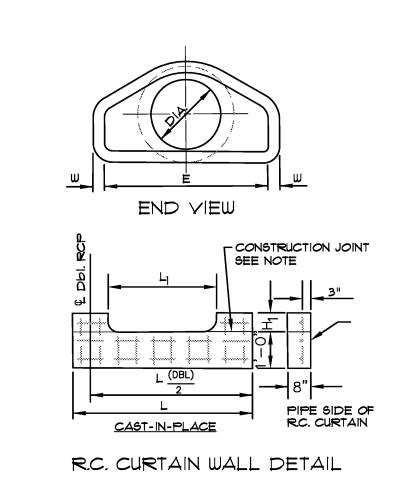5 = 510pe




919	E PA	Y LENG	T₩												
TABLE OF DIMENSIONS															
	DIA.	WALL	Α	В	С	D	E	S	DIA.+1"	Р	R-1	R-2	G-T	WT	h
	18"	2 1/2"	9"	2'-3"	3'-10"	6'-1"	3'-0"	3:1	19"	29"	15 1/2"	12"	2"	1000	1'-0 1/2'
	24"	3"	9 1/2"	3'-7 1/2"	2'-6"	6'-1 1/2"	4'-0"	3:1	25"	33 3/16"	16 13/16"	14"	2 1/2"	1600	1'-1 1/2'
	30"	3 1/2"	1'-0"	4'-6"	1'-7 3/4"	6'-1 3/4"	5'-0"	3:1	31"	37"	18 1/2"	15"	3 1/4"	1940	1'-4 5/8'
	36"	4"	1'-3"	5'-3"	2'-10 3/4"	8'-1 3/4"	6'-0"	3:1	37"	47 13/16"	24 5/16"	20"	3 1/2"	4100	1'-8"
	42"	4 1/2"	1'-9"	5'-3"	2'-11"	8'-2"	6'-6"	3:1	43"	53 7/8"	27 1/2"	22"	3 1/2"	5380	2'-2 1/2'
	48"	5"	2'-0"	6'-0"	2'-2"	8'-2"	7'-0"	3:1	49"	56 1/2"	28 1/2"	22"	3 1/2"	6550	2'-6"
	54"	5 1/2"	2'-4"	6'-6"	1'-10"	8'-4"	7'-6"	3:1	55"	65 1/2"	33 1/8"	24"	4"	8750	2'-10 1/2
	60"	6"	2'-10"	6'-6"	1'-10"	8'-4"	8'-0"	3:1	61"	72 1/2"	36 11/16 <b>"</b>	24"	4"	9270	3'-5"
	72"	7"	3'-10"	6'-6"	1'-10"	8'-4"	9'-0"	3:1	73"	77 13/16"	38 15/16"	24"	5"	13250	4'-6"


# NOTES

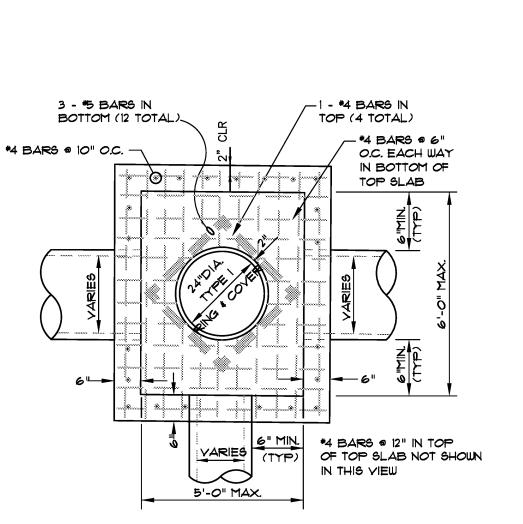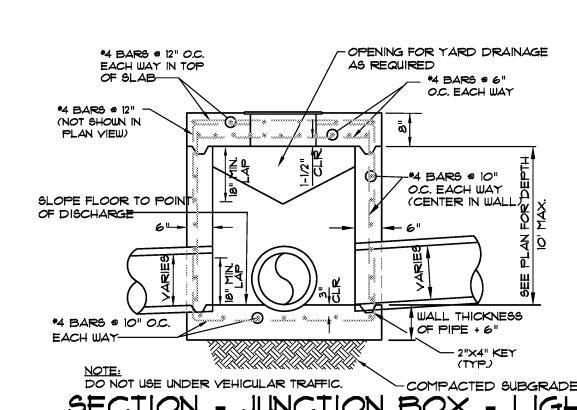- 1. THE PORTION OF THE R.C. CURTAIN WALL BENEATH THE FLARED END SECTION (LOWER 1'-O") SHALL BE PLACED MONOLITHICALLY. THE FLARED END SECTION SHALL THEN BE SET IN PLACE AND THE REMAINING PORTIONS OF THE R.C. CURTAIN WALL PLACED.
- 2. ALL REINFORCING STEEL ARE #4 BARS AT 6" O.C.
- 3. NO SEPARATE PAYMENT WILL BE MADE FOR THE CURTAIN WALLS. THEY SHALL BE CONSIDERED SUBSIDIARY TO THE FLARED END SECTIONS.
- 4. TONGUE END ON UPSTREAM SECTION. GROOVE END ON DOWNSTREAM SECTION.

# FLARED END SECTION DETAILS FOR REINFORCED CONCRETE PIPE CULVERT







-COMPACTED SUBGRADE SECTION - JUNCTION BOX - LIGHT

- TOP TO CONFORM

TO TOP OF CURB

AND COVER

j∕-PROVIDE OPENING

\_ \_ EXTENSION

**SECTION** 

∠SLOPE FLOOR

INLETS MORE THAN 3'-O" DEEP SHALL HAVE STANDARD MANHOLE STEPS PLACED AT 15" O.C. — MANHOLE FRAME AND COVER SHALL BE PLACED ADJACENT TO THE WALL WITH THE STEPS.

2.0% TO OUTLET

REQUIRED

/ WHEN

**--**#5 **©** 6" O.C. E.W. CENTER

IN TOP SLAB

FROM WALL

INTO TOP

SLAB

**}**-#5 @ 10" O.C.

FROM FLOOR

**%**SLAB INTO

COMPACTED COMPACTED

LARGEST PIPE WALL

└-#5 @ 10" O.C. E.W.

CENTER IN SLAB

THICKNESS +6"

SUBGRADE

Ë.W. CENTER

IN WALL

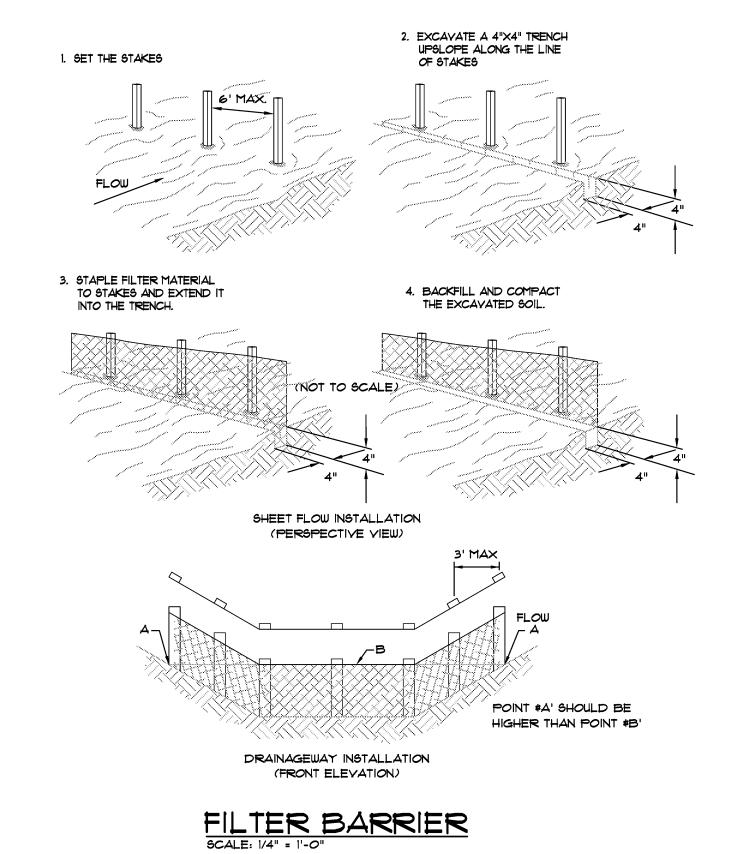
1. JUNCTION BOXES MORE THAN 3 FEET DEEP SHALL HAVE STANDARD MANHOLE STEPS PLACED @ 15" O.C.

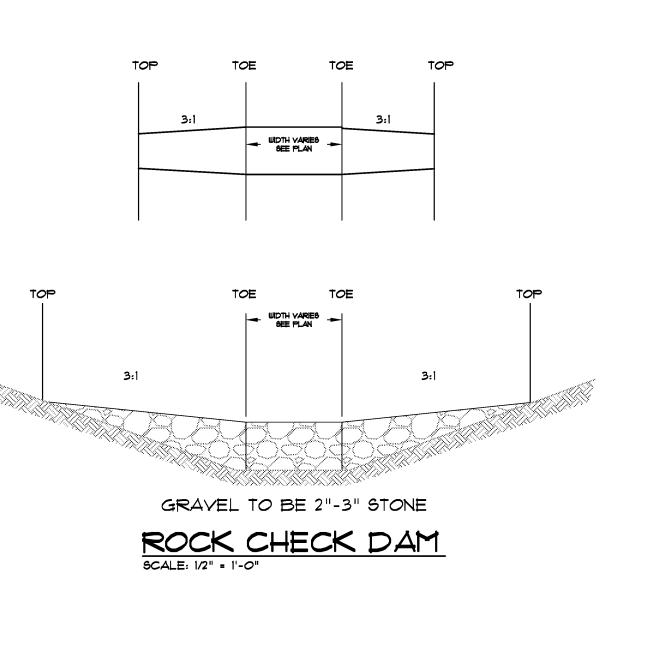
2. SEE REINFORCING DETAIL FOR OPENING IN WALL OR SLAB.

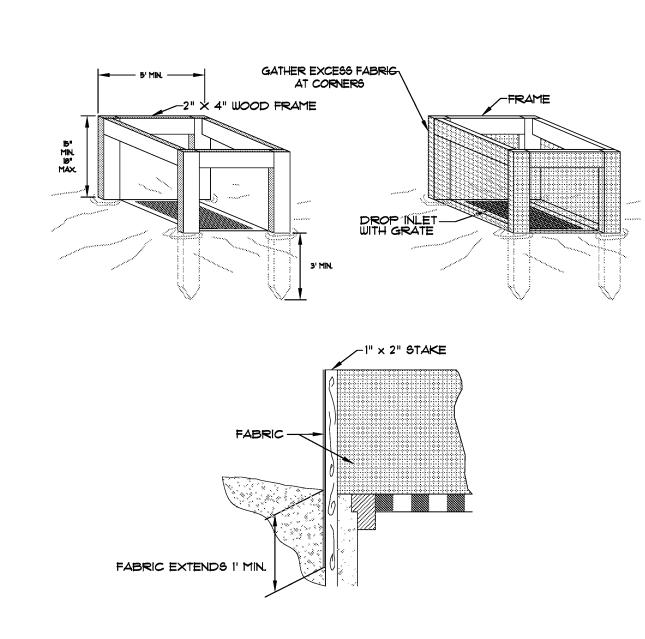


REY DATE

AND TESTURA, LLC No. 200








SILT FENCE INLET PROTECTION

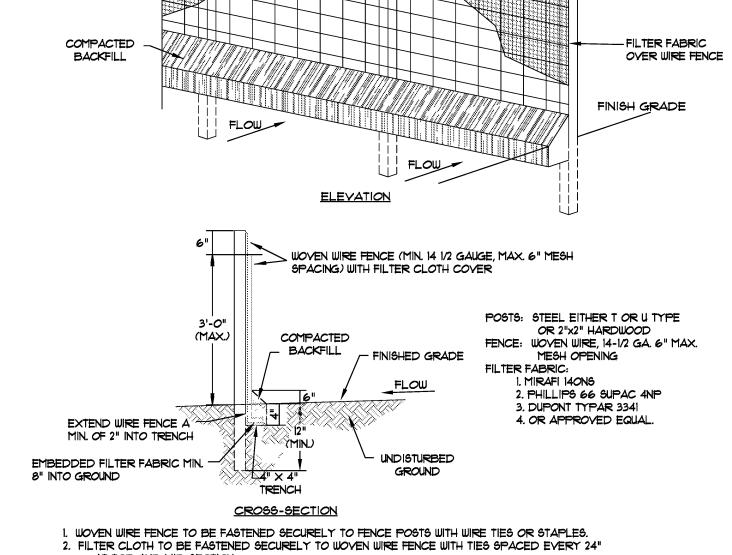SCALE: 1/2" = 1'-0"




\_ WOVEN WIRE FENCE (MIN. 14-1/2 GAUGE, MAX. 6" MESH SPACING)

- 54" MIN. FENCE POSTS, MIN. 18" INTO GROUND.

AT TOP AND MID SECTION.

- 3. WHEN TWO SECTIONS OF FILTER CLOTH ADJOIN EACH OTHER THEY SHALL BE OVERLAPPED BY SIX INCHES AND FOLDED.
- 4. MAINTENANCE SHALL BE PERFORMED AS NOTED IN THE EROSION CONTROL PLAN. COLLECTED MATERIAL SHALL BE REMOVED WHEN "BULGES" DEVELOP IN THE SILT FENCE.

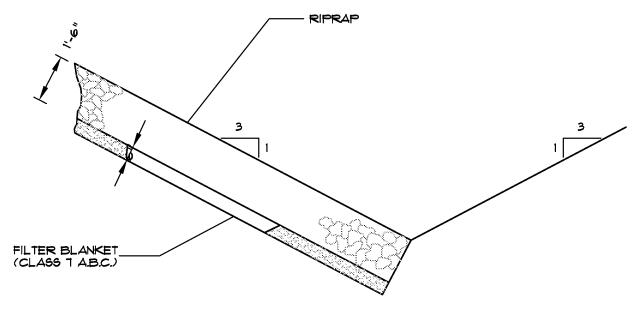
SILT FENCE NOT TO SCALE



NOTE: IN LIEU OF AN AGGREGATE FILTER BLANKET, A SYNTHETIC FIBER GEOTEXTILE FABRIC MEETING THE REQUIREMENTS OF AASHTO M288 MAY BE USED. IN LIEU OF RIPRAP, AN EROSION CONTROL MAT MAY

SECTION - DUMPED RIPRAP

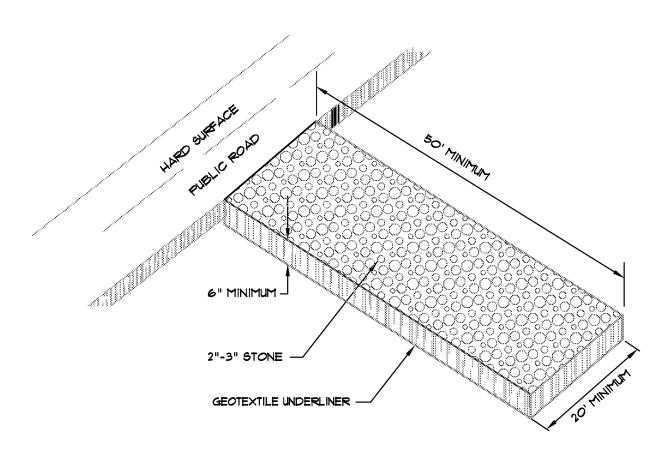TOE EXCAVATION IN SOIL



CONSTRUCTION ENTRANCE NOT TO SCALE





ASSOCIATED ENGINEERING AND TESTING, LLC CIVIL ENGINEERING AND LAND SURVEYING SERVICES 103 SOUTH CHURCH STREET - P.O. BOX 1462 - JONESBORO, AR 72403 PH: 870-932-3594 FAX: 870-935-1263

EROSION CONTROL DETAILS EMERALD YILLAGE KWL PROPERTIES, LLC


3 07/01/16 REVISED BUILDING LOCATIONS, LOT CONFIGURATION AND PERRY DRIVE PER OWNER JME JME JONESBORO, ARKANSAS REVISED PER MAPC COMMENTS - STREET NAMES JME JME 1 04/05/16
REY DATE JME JME DRAWN: JME CHECKED: JME DATE: 01/28/16

DRAWN CHK'D SCALE: AS SHOWN CADD FILESIOO-SDP-EV DWG. REVISED SANITARY SEWER ALIGNMENT PER CWL REVISIONS

# SANITARY SEWER AND WATER DISTRIBUTION PLANS
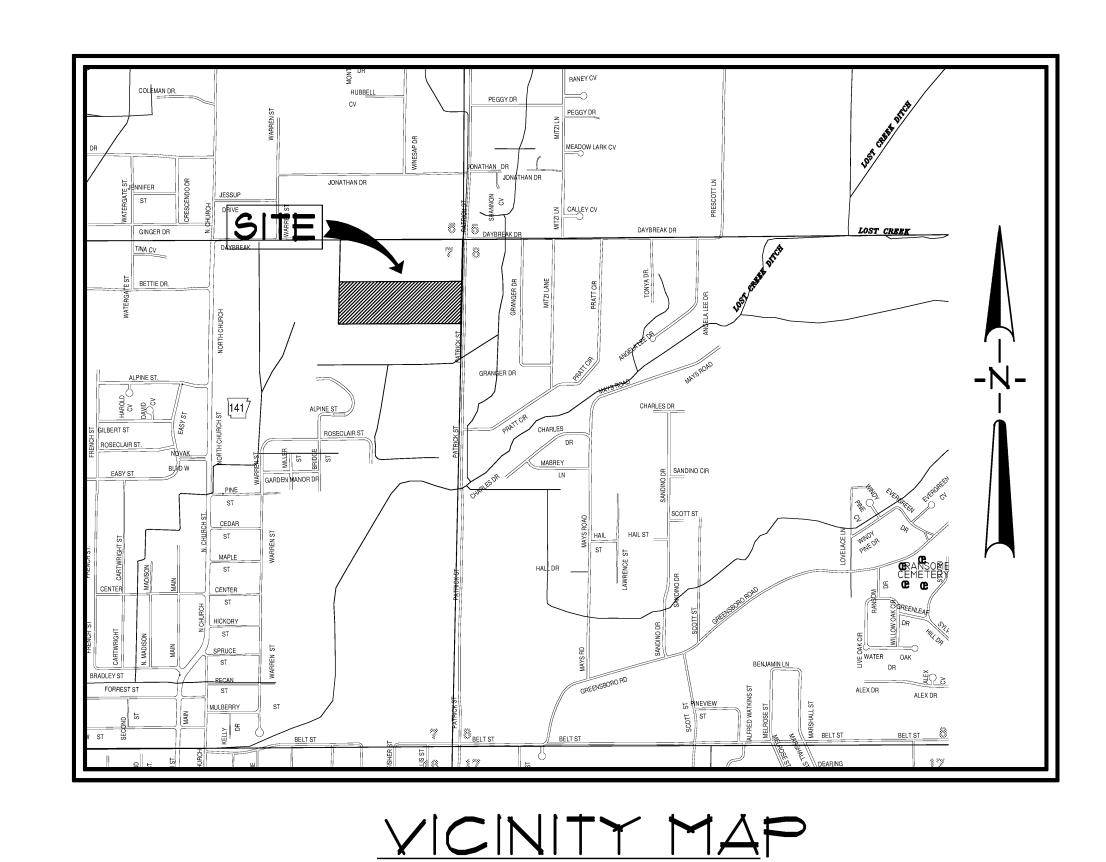
# EMERALD VILLAGE

LYING IN SECTION T, TOWNSHIP 14 NORTH,
RANGE 4 EAST, CRAIGHEAD COUNTY,
JONESBORO, ARKANSAS
MAY 2016



SCALE: 1" = 1000'

# INDEX TO SHEETS

COI INDEX SHEET

CO2 SANITARY SEWER AND WATER DISTRIBUTION PLAN

SANITARY SEWER PLAN & PROFILE
SANITARY SEWER PLAN & PROFILE

COS WATER DISTRIBUTION DETAILS
COG SANITARY SEWER DETAILS



ASSOCIATED ENGINEERING AND TESTING, LLC

CIVIL ENGINEERING AND LAND SURVEYING SERVICES

103 SOUTH CHURCH STREET - P.O. BOX 1462 - JONESBORO, AR 12403

PH: 810-932-3594 FAX: 810-935-1263

INDEX SHEET SANITARY SEWER AND WATER PLANS EMERALD VILLAGE

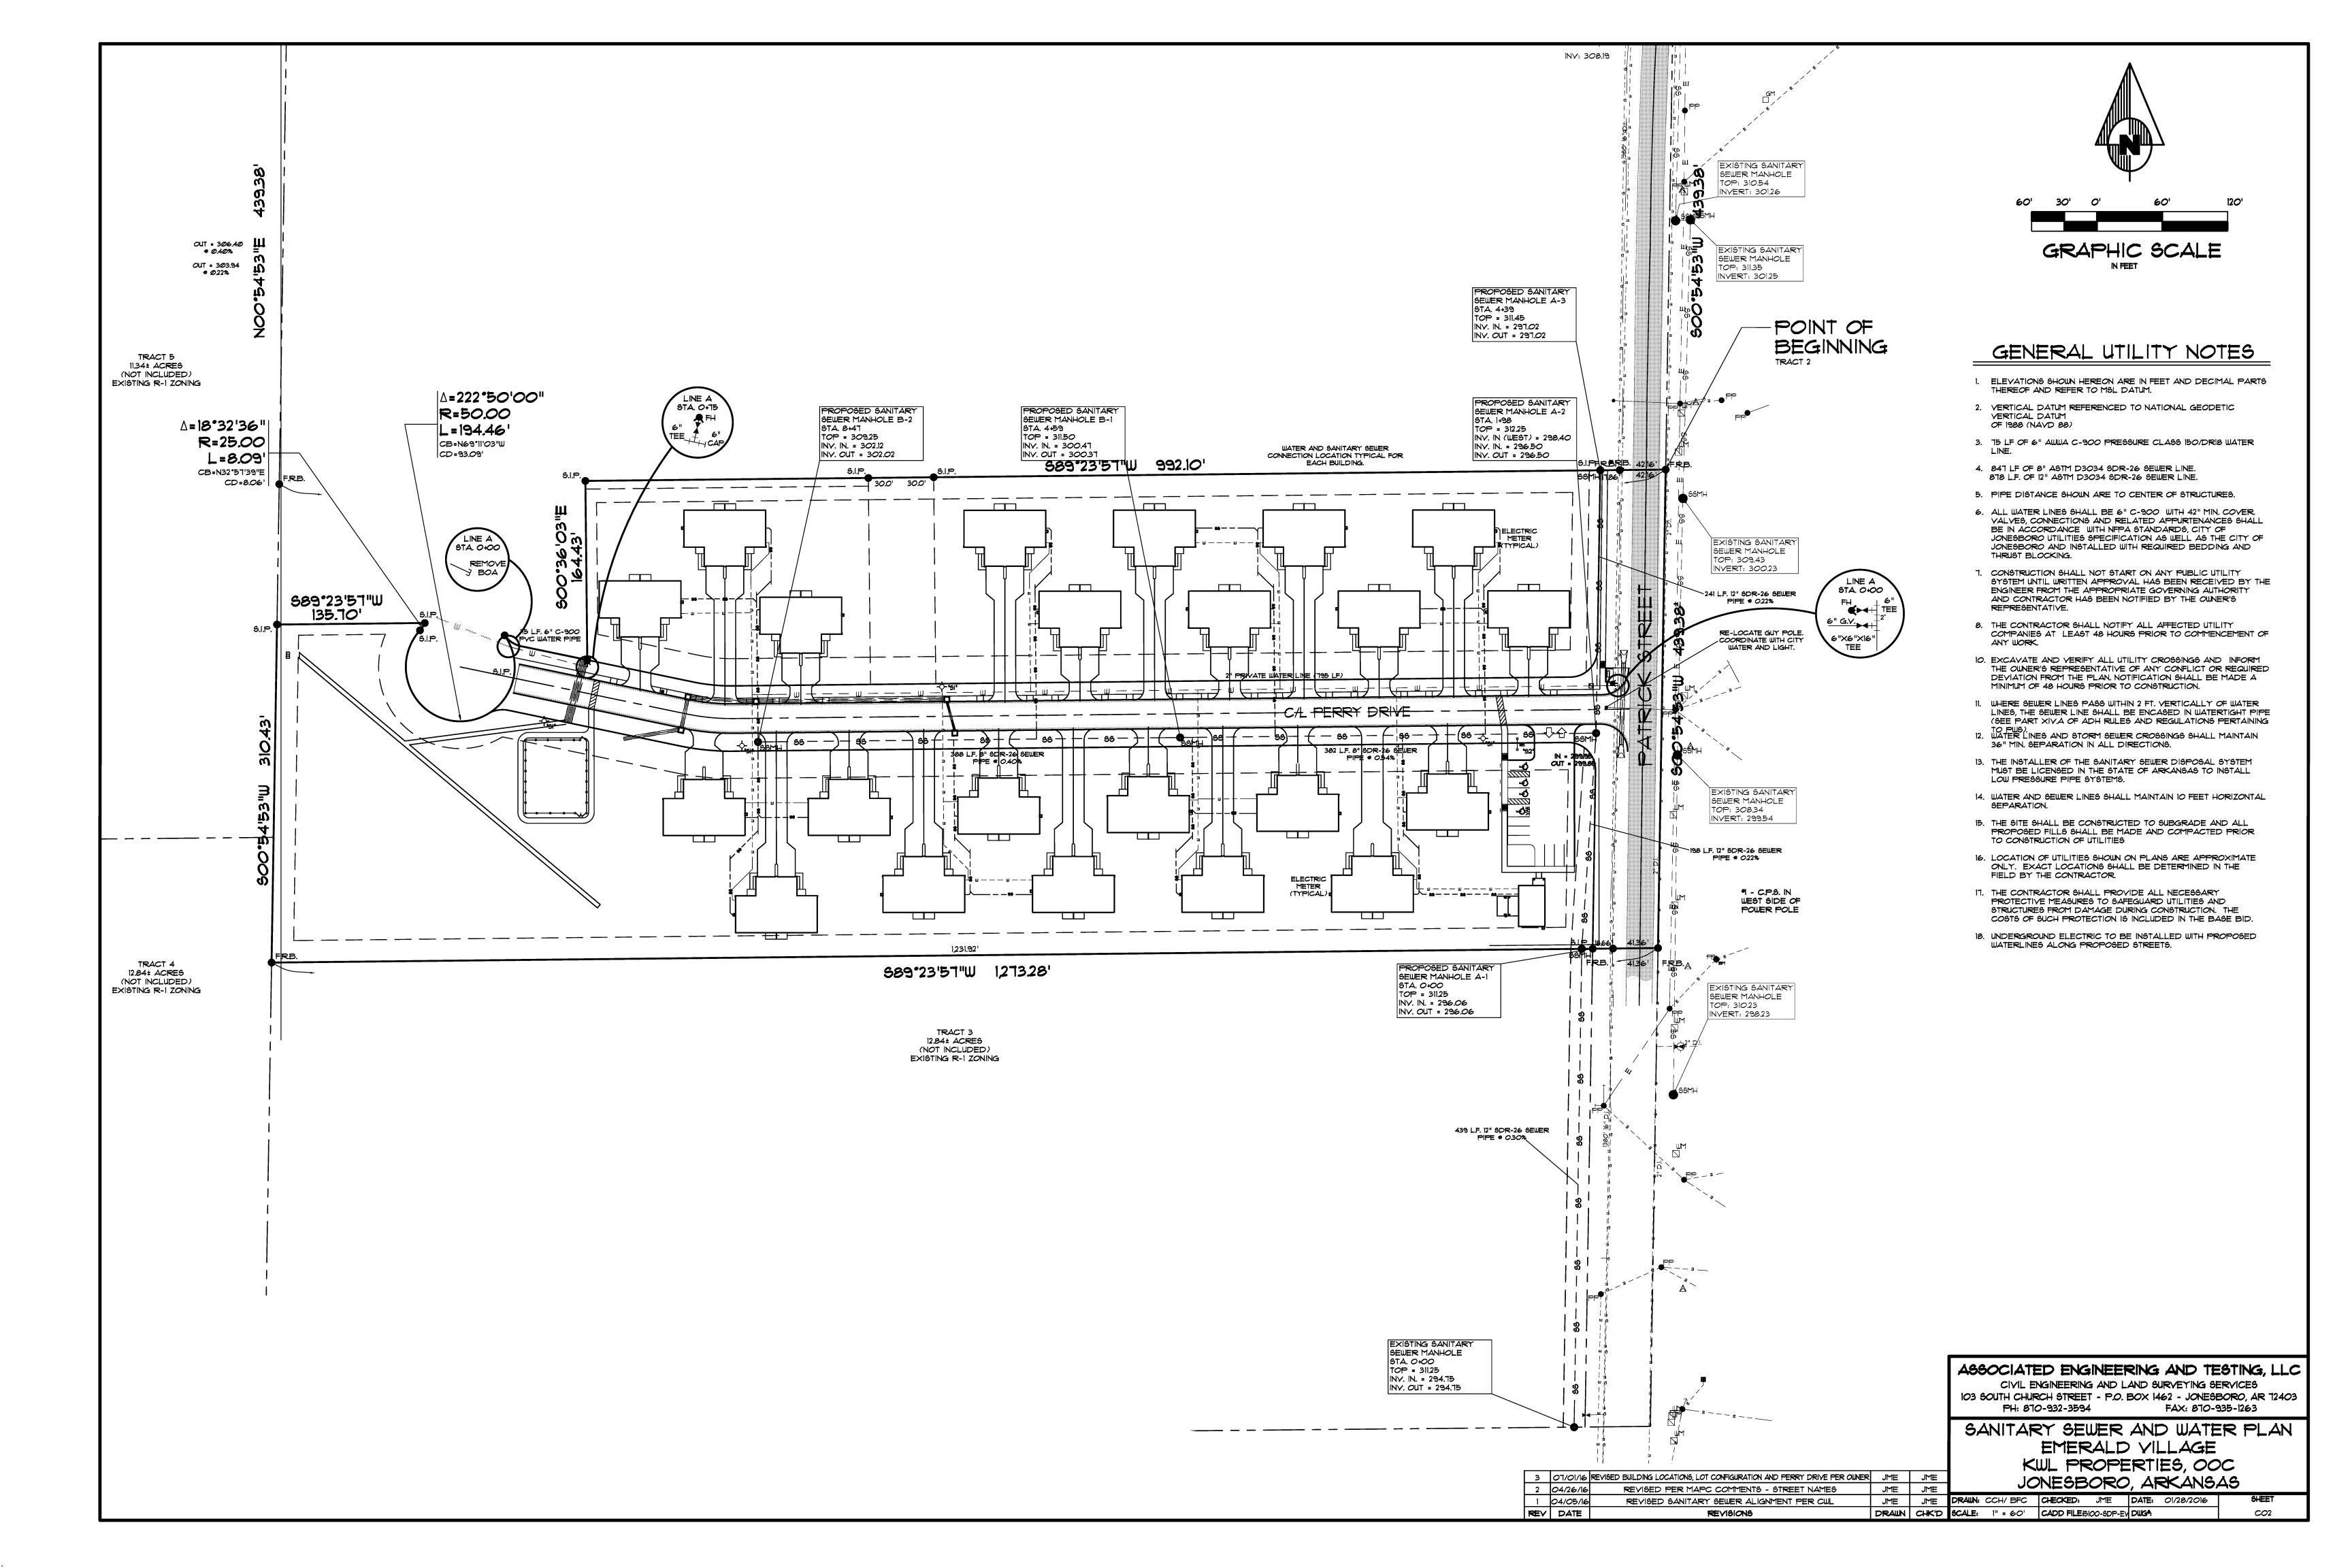
3 07/01/16 REVISED BUILDING LOCATIONS, LOT CONFIGURATION AND PERRY DRIVE PER OWNER JME JME
2 04/26/16 REVISED PER MAPC COMMENTS - STREET NAMES JME JME
1 04/05/16 REVISED SANITARY SEWER ALIGNMENT PER CWL JME JME
REV DATE REVISIONS DRAWN CHK'D

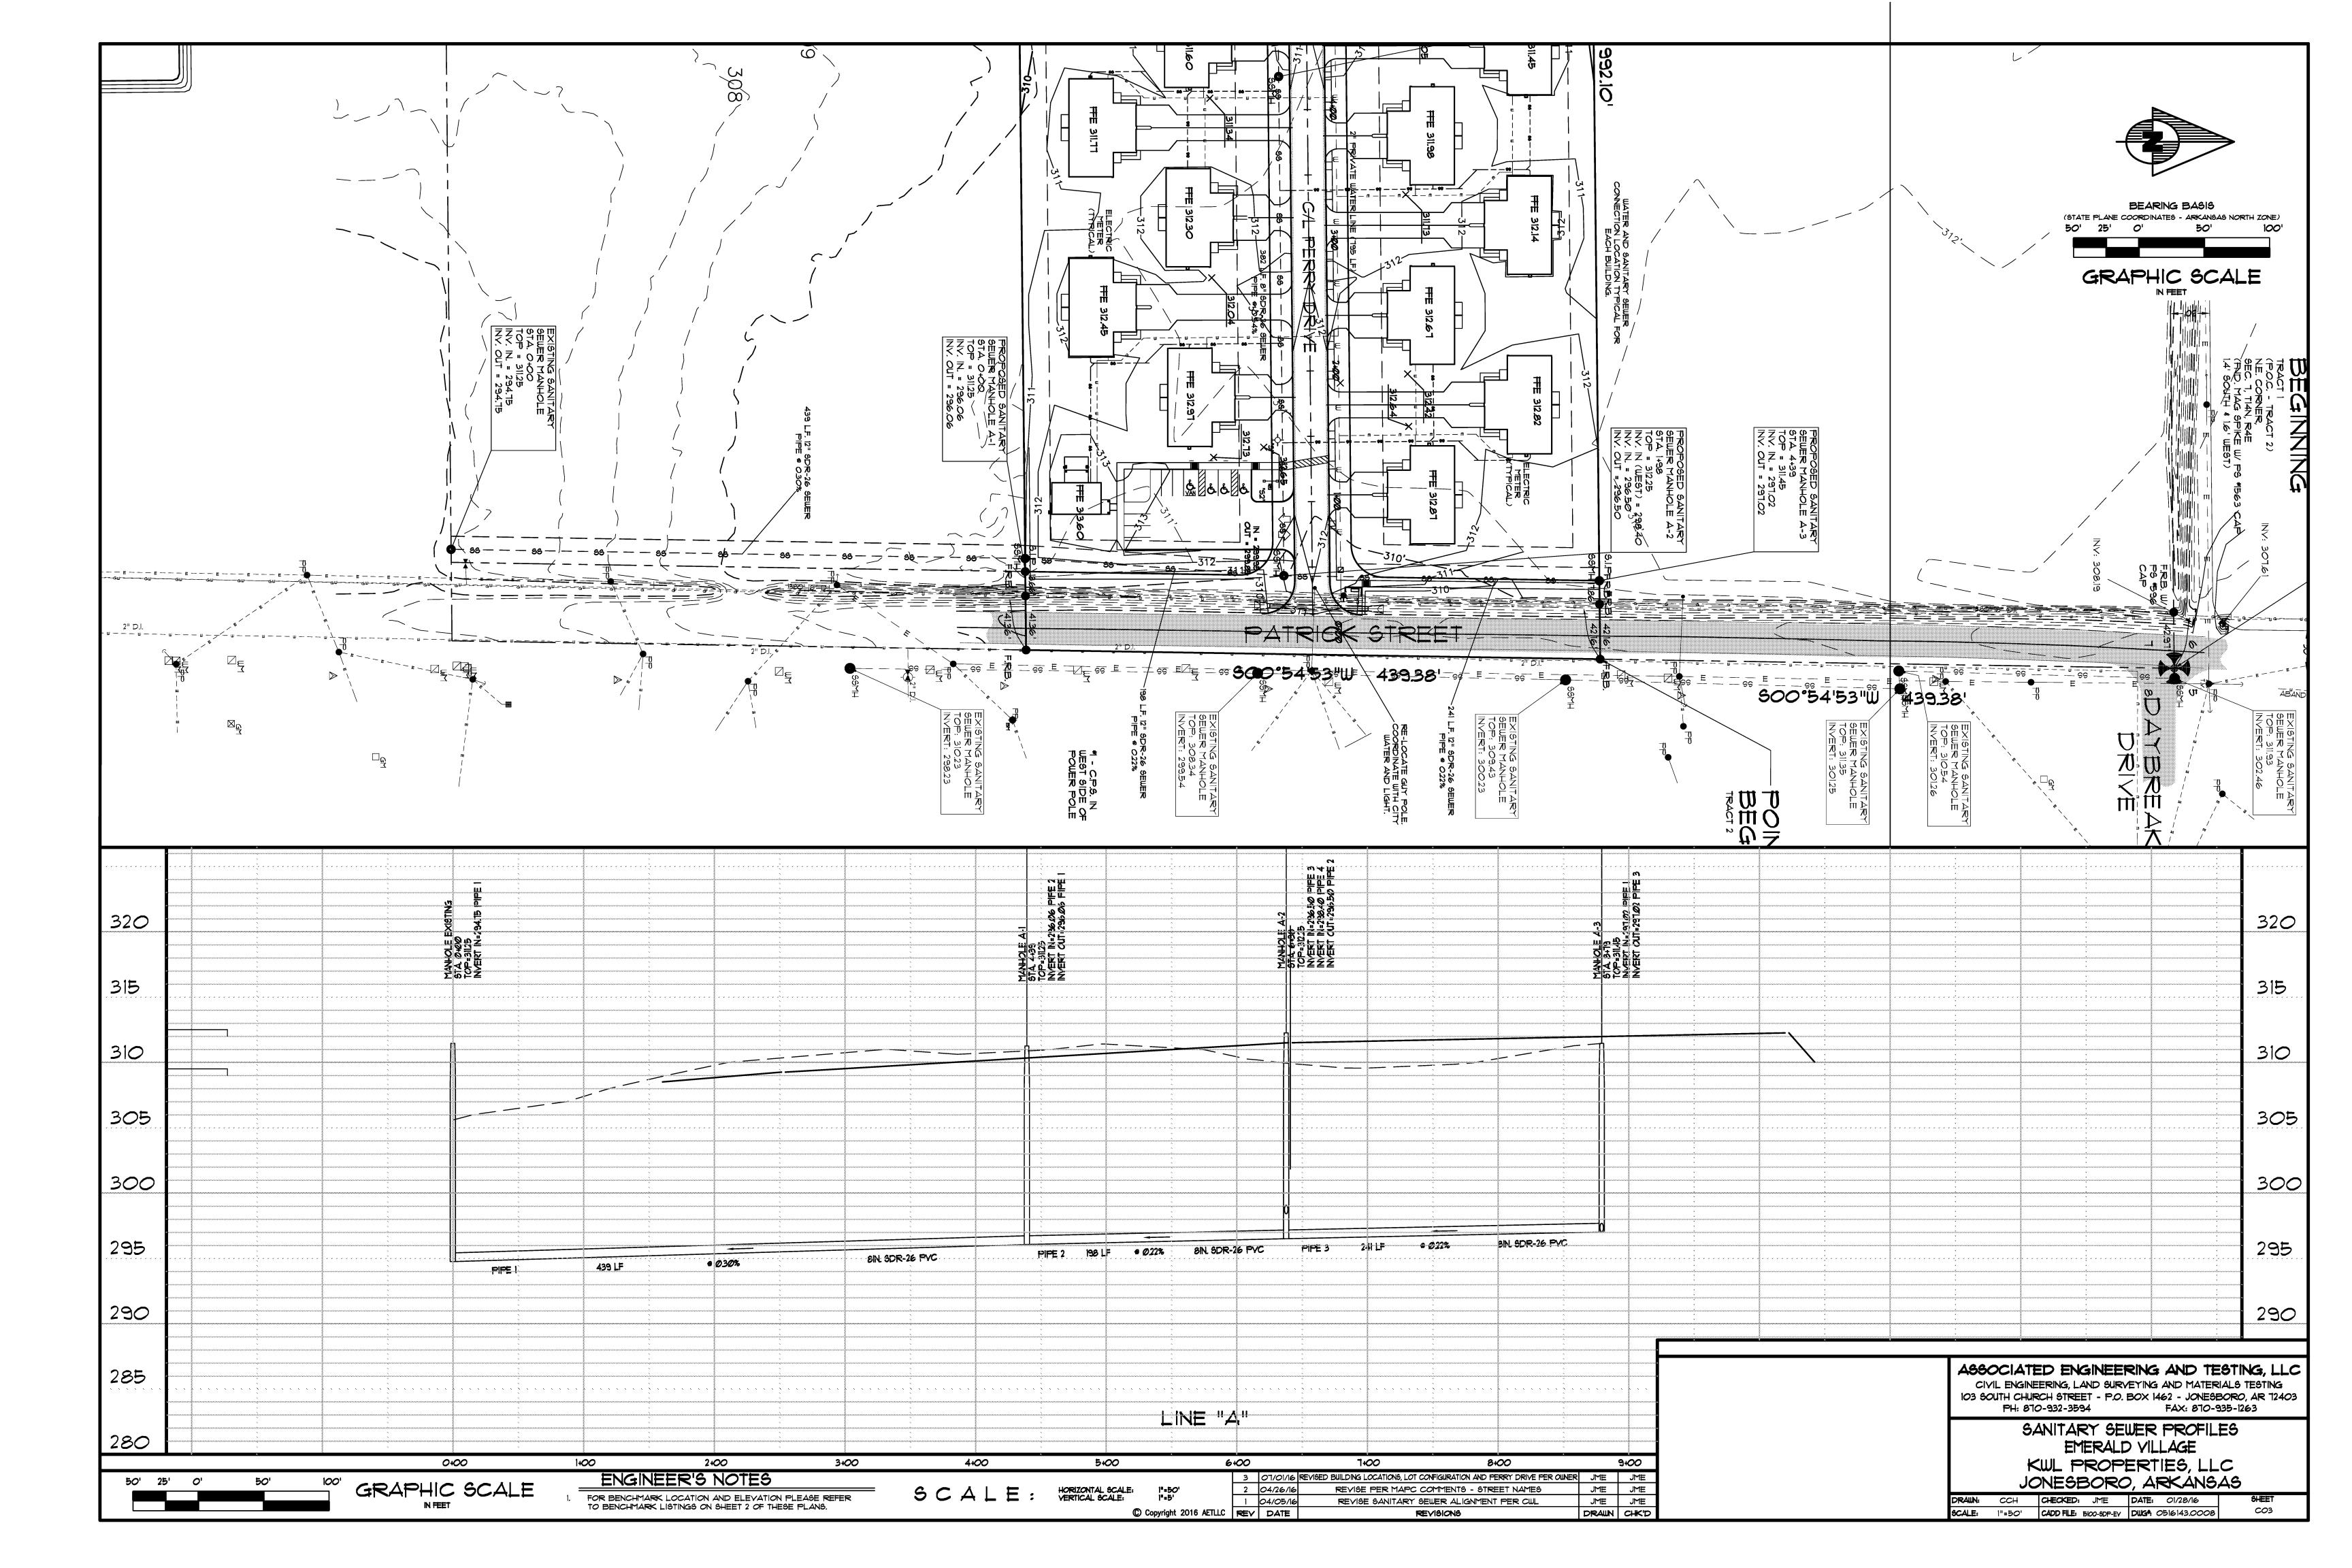
JONESBORO, ARKANSAS

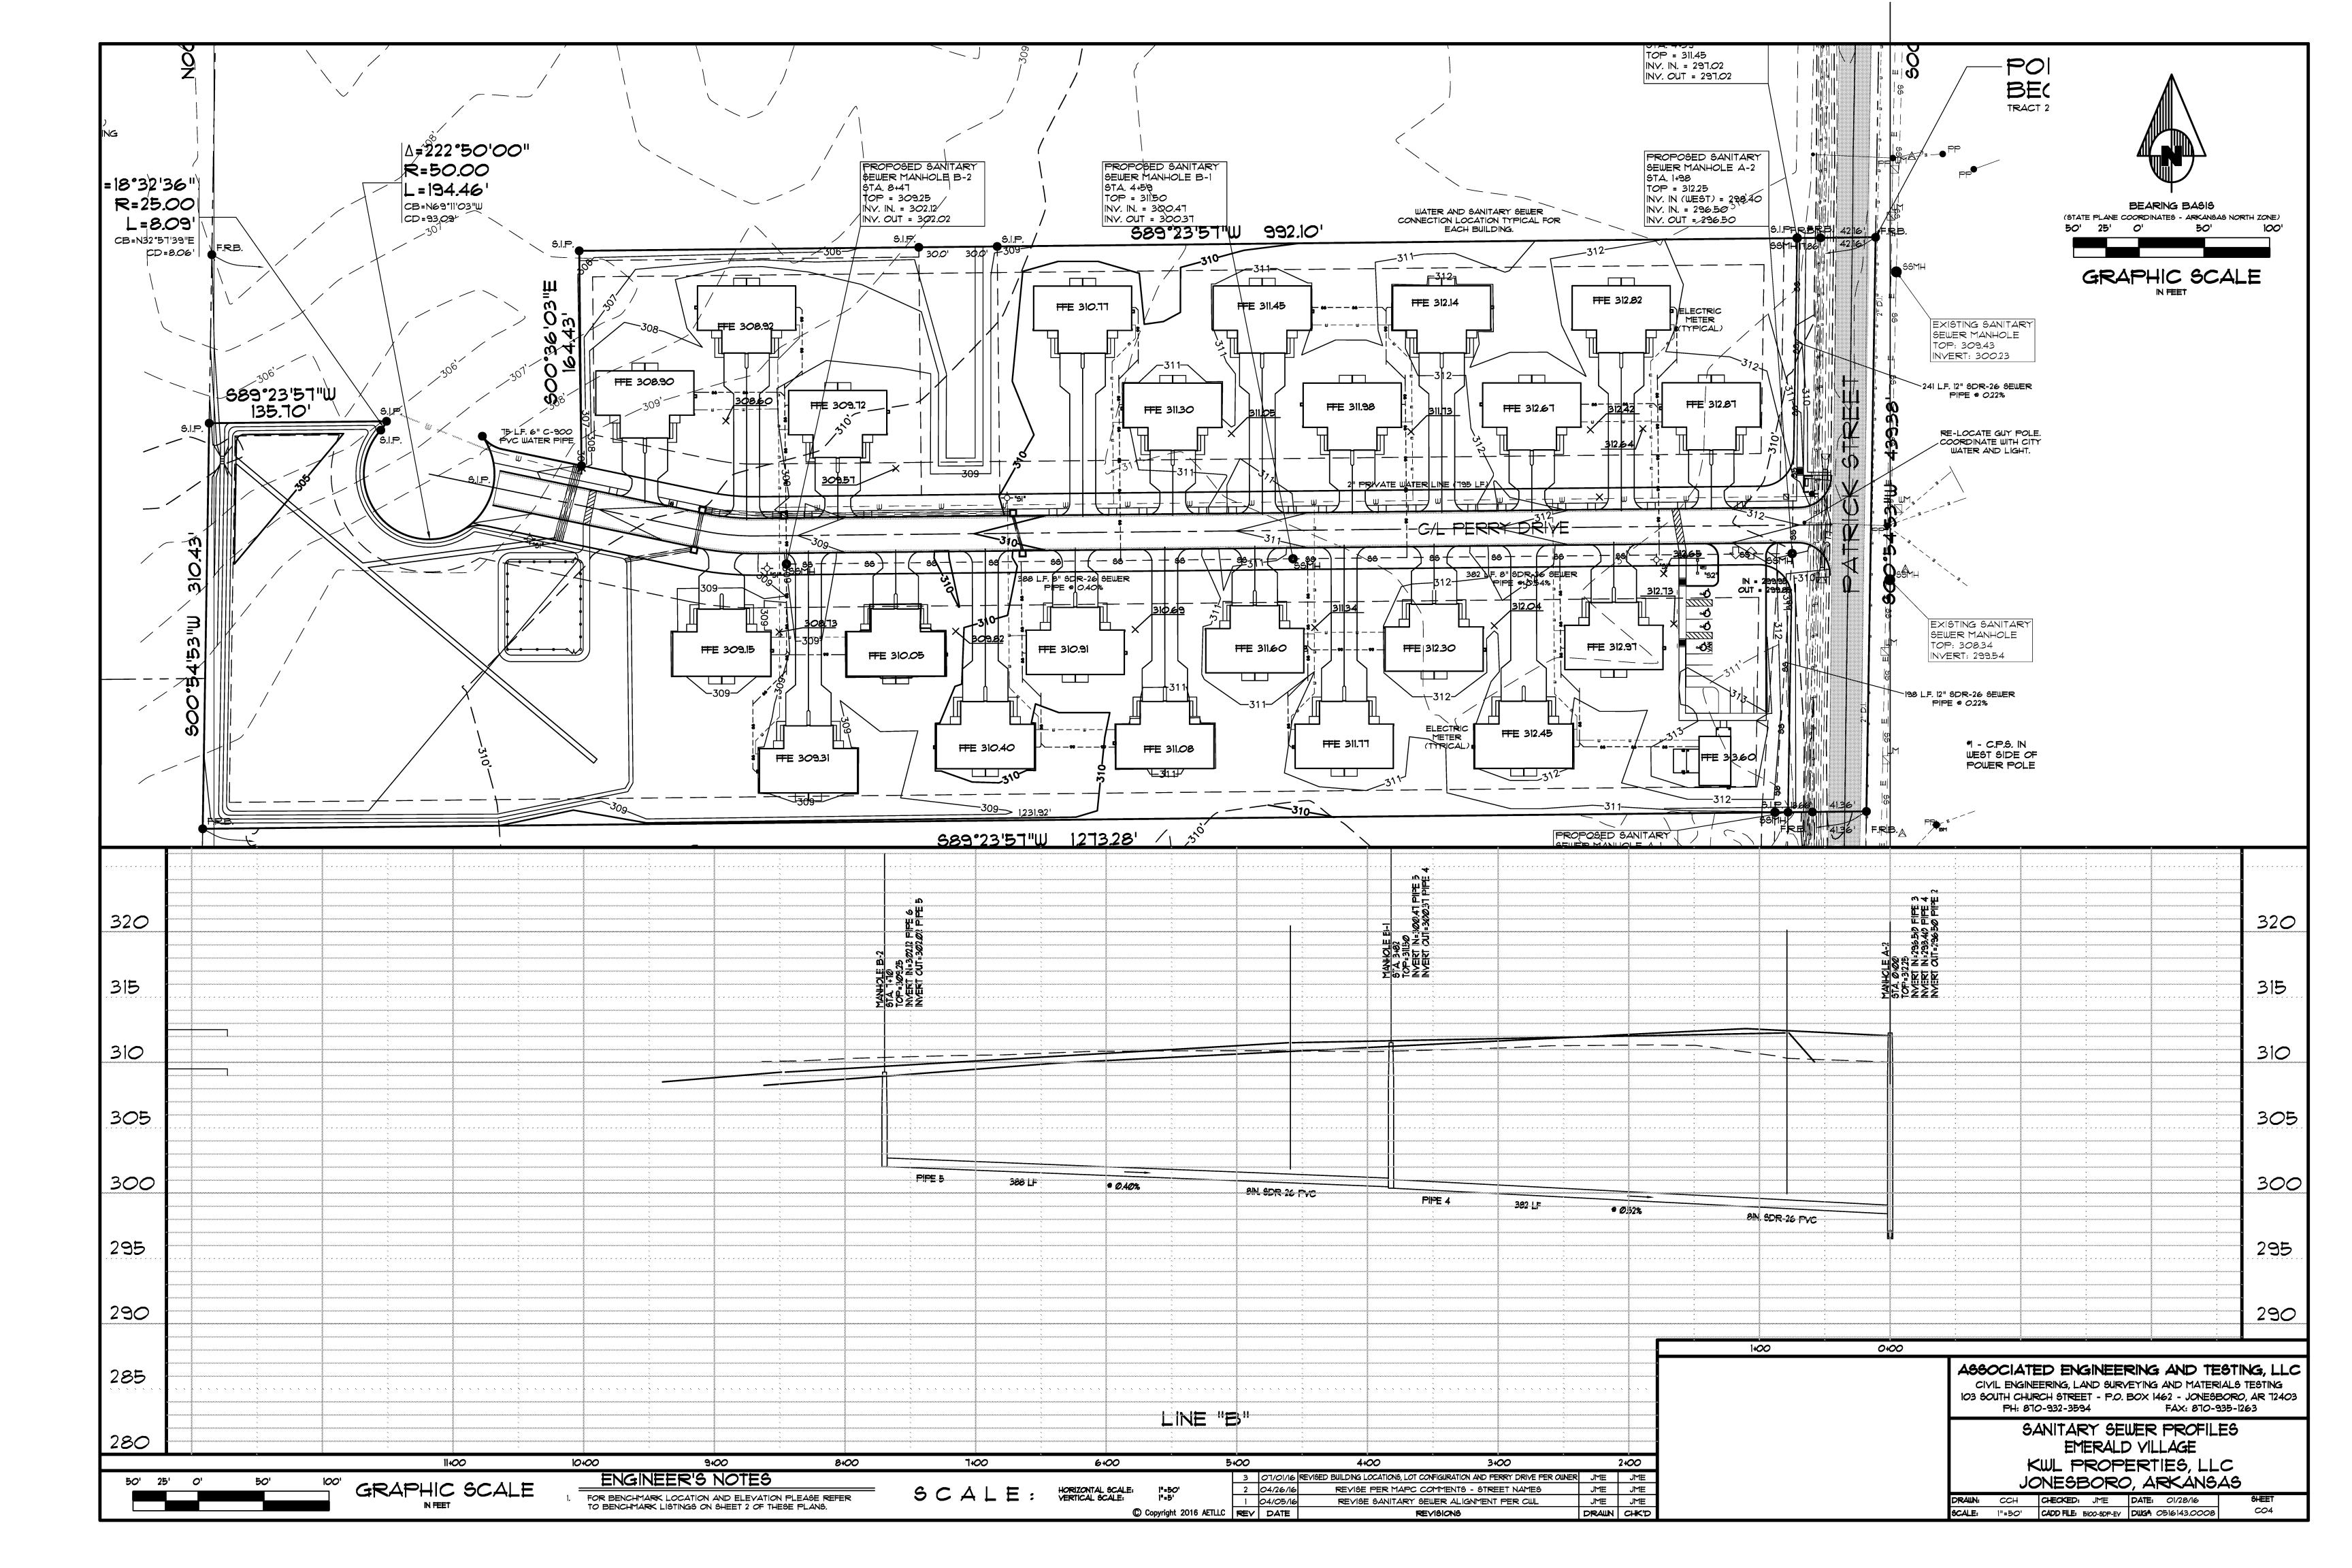
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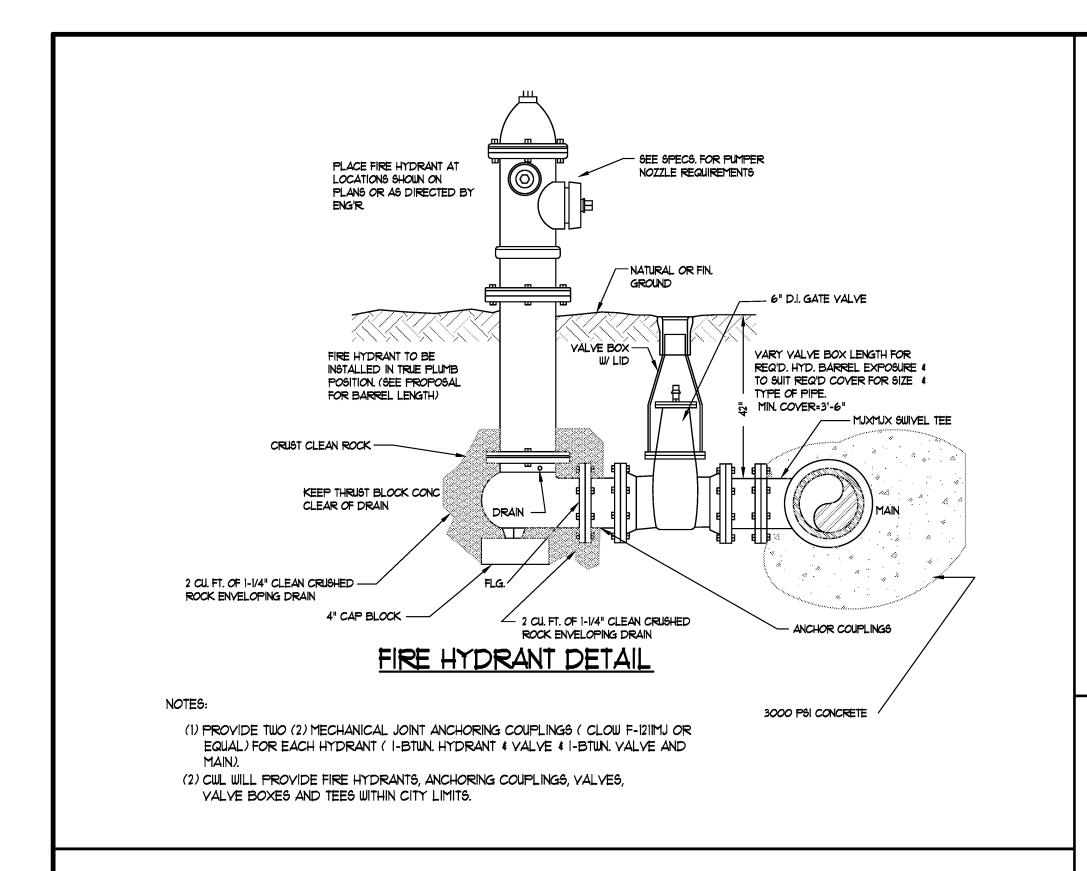
DRAWN CHK'D SCALE: 1" = 1000' CADD FILE:5100-5DP-EV DWG.


COI












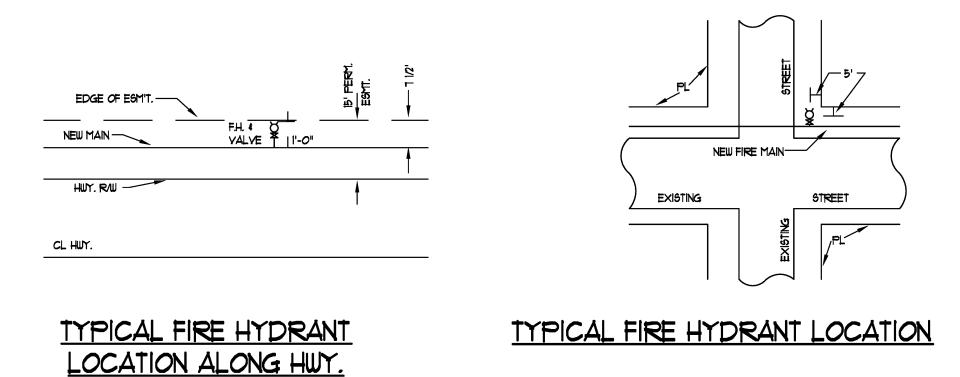


<u>RIGHT-OF-WAY</u>

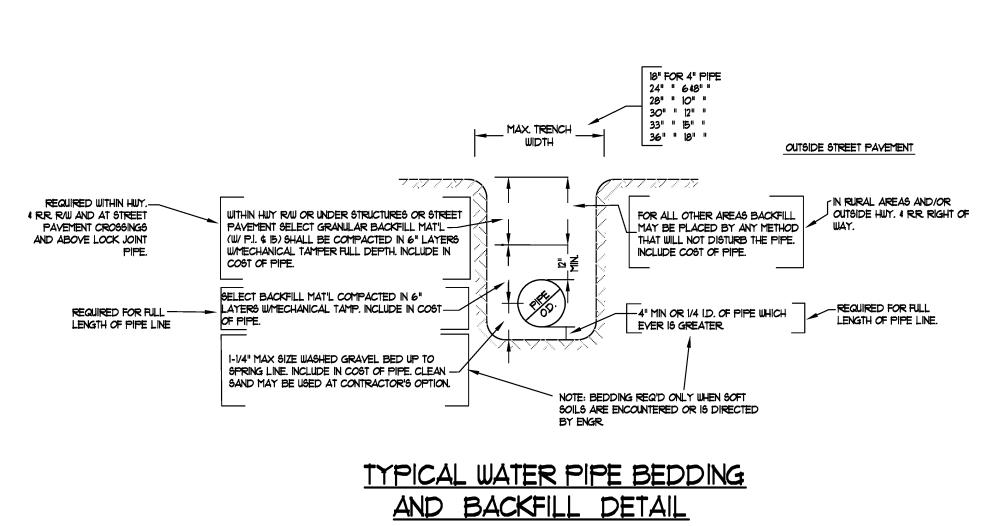


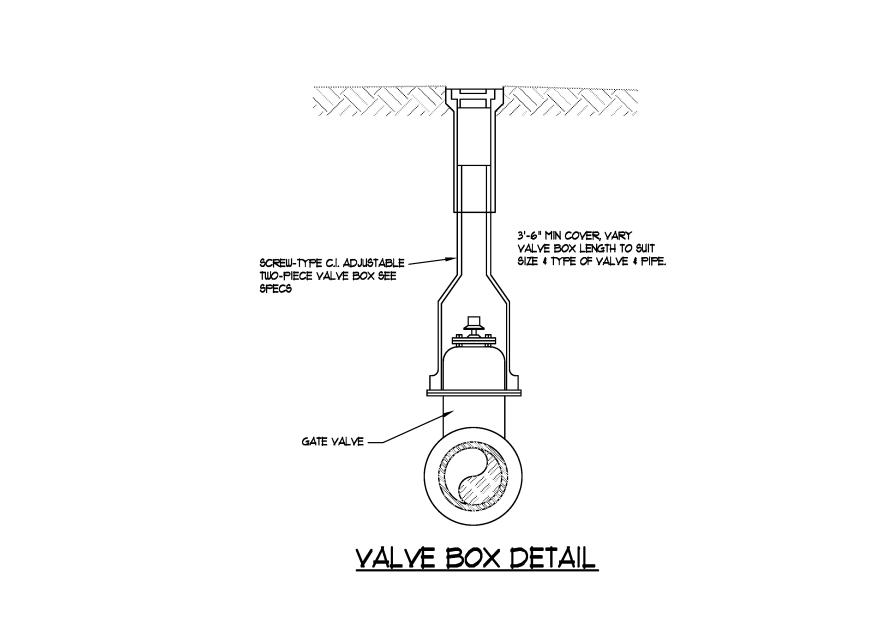


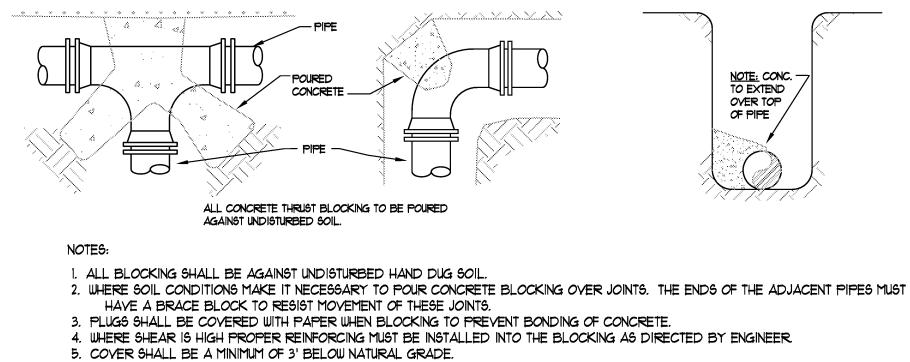

# 6. CLEARANCE FROM OIL & GAS COMPANIES LINES SHALL BE A MINIMUM OF 18". 1. THRUST BLOCKING DIMENSIONS SHALL BE 150 % OF THE THRUST CALCULATED FROM THE FORMULA (THRUST=2 AP SIN : WHERE A=PIPE END AREA. P-PRESSURE PRODUCED BY PUMPING LIQUID. & ANGLE OF BEND TO BE BLOCKED) AND SOIL BEARING CAPACITY OF 8. ALL CONCRETE SHALL BE 3000 PSI AT 28 DAY STRENGTH. THRUST BLOCK DETAILS

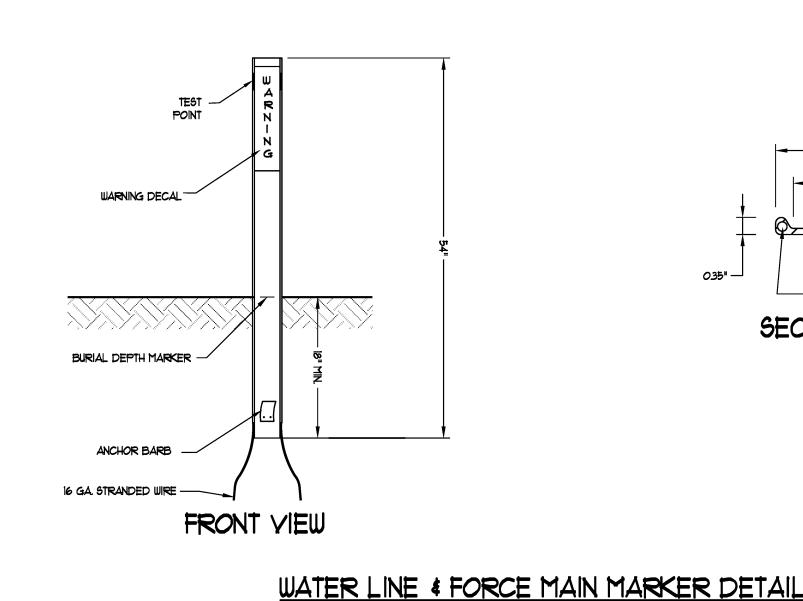

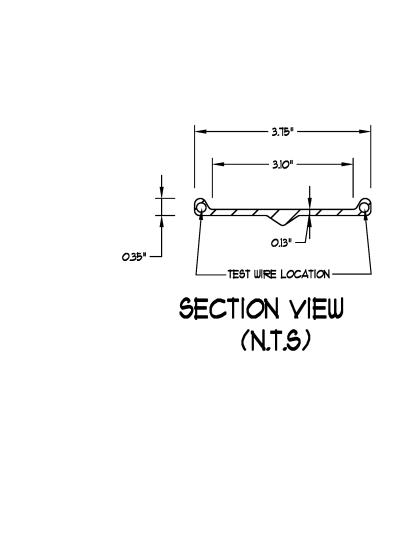


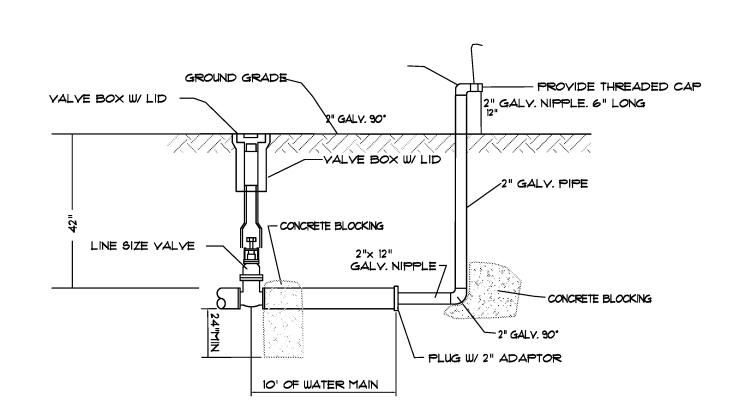

2" B.O. ASSEMBLY OTHER BLOW-OFF ASSEMBLIES CAN FOR THRU 6" LINES BE USED AS APPROVED BY LOCAL UTILITY COMPANY. WITH FUTURE EXPANSION (NOT REQ'D IN COVES OR DEAD END LINES)

REY DATE

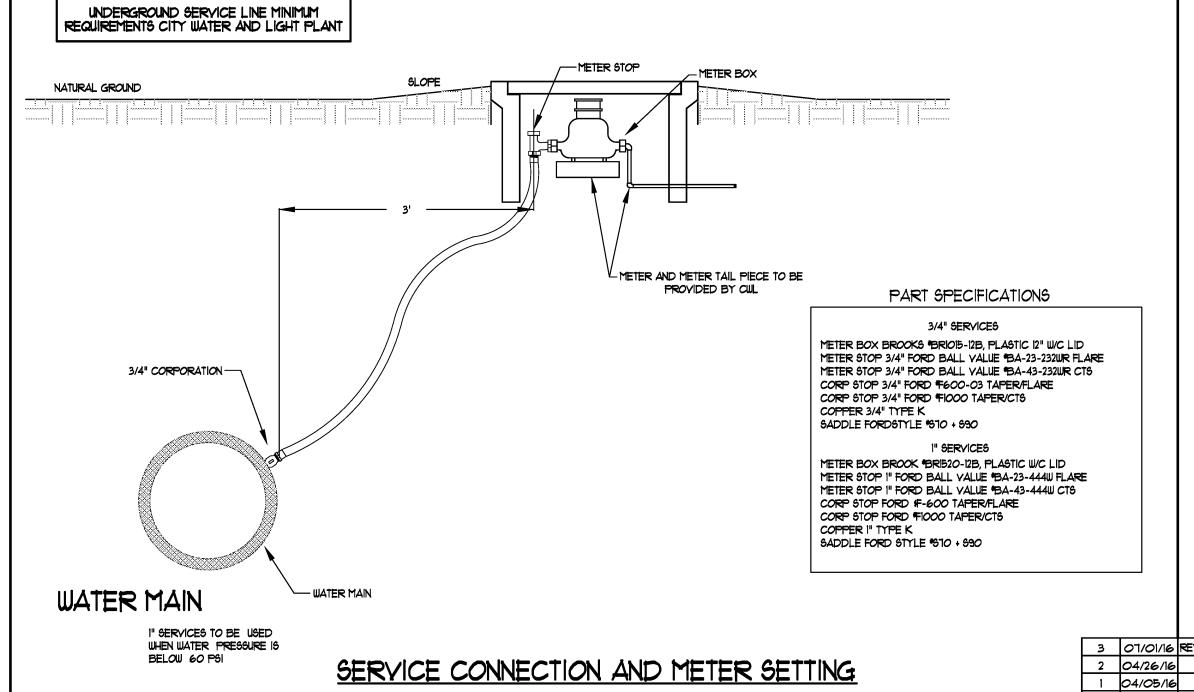
BLOW-OFF ASSEMBLY DETAILS





ASSOCIATED ENGINEERING AND TESTING, LLC CIVIL ENGINEERING AND LAND SURVEYING SERVICES 103 SOUTH CHURCH STREET - P.O. BOX 1462 - JONESBORO, AR 72403 PH: 870-932-3594 FAX: 870-935-1263

WATER DISTRIBUTION DETAILS EMERALD VILLAGE KWL PROPERTIES, LLC

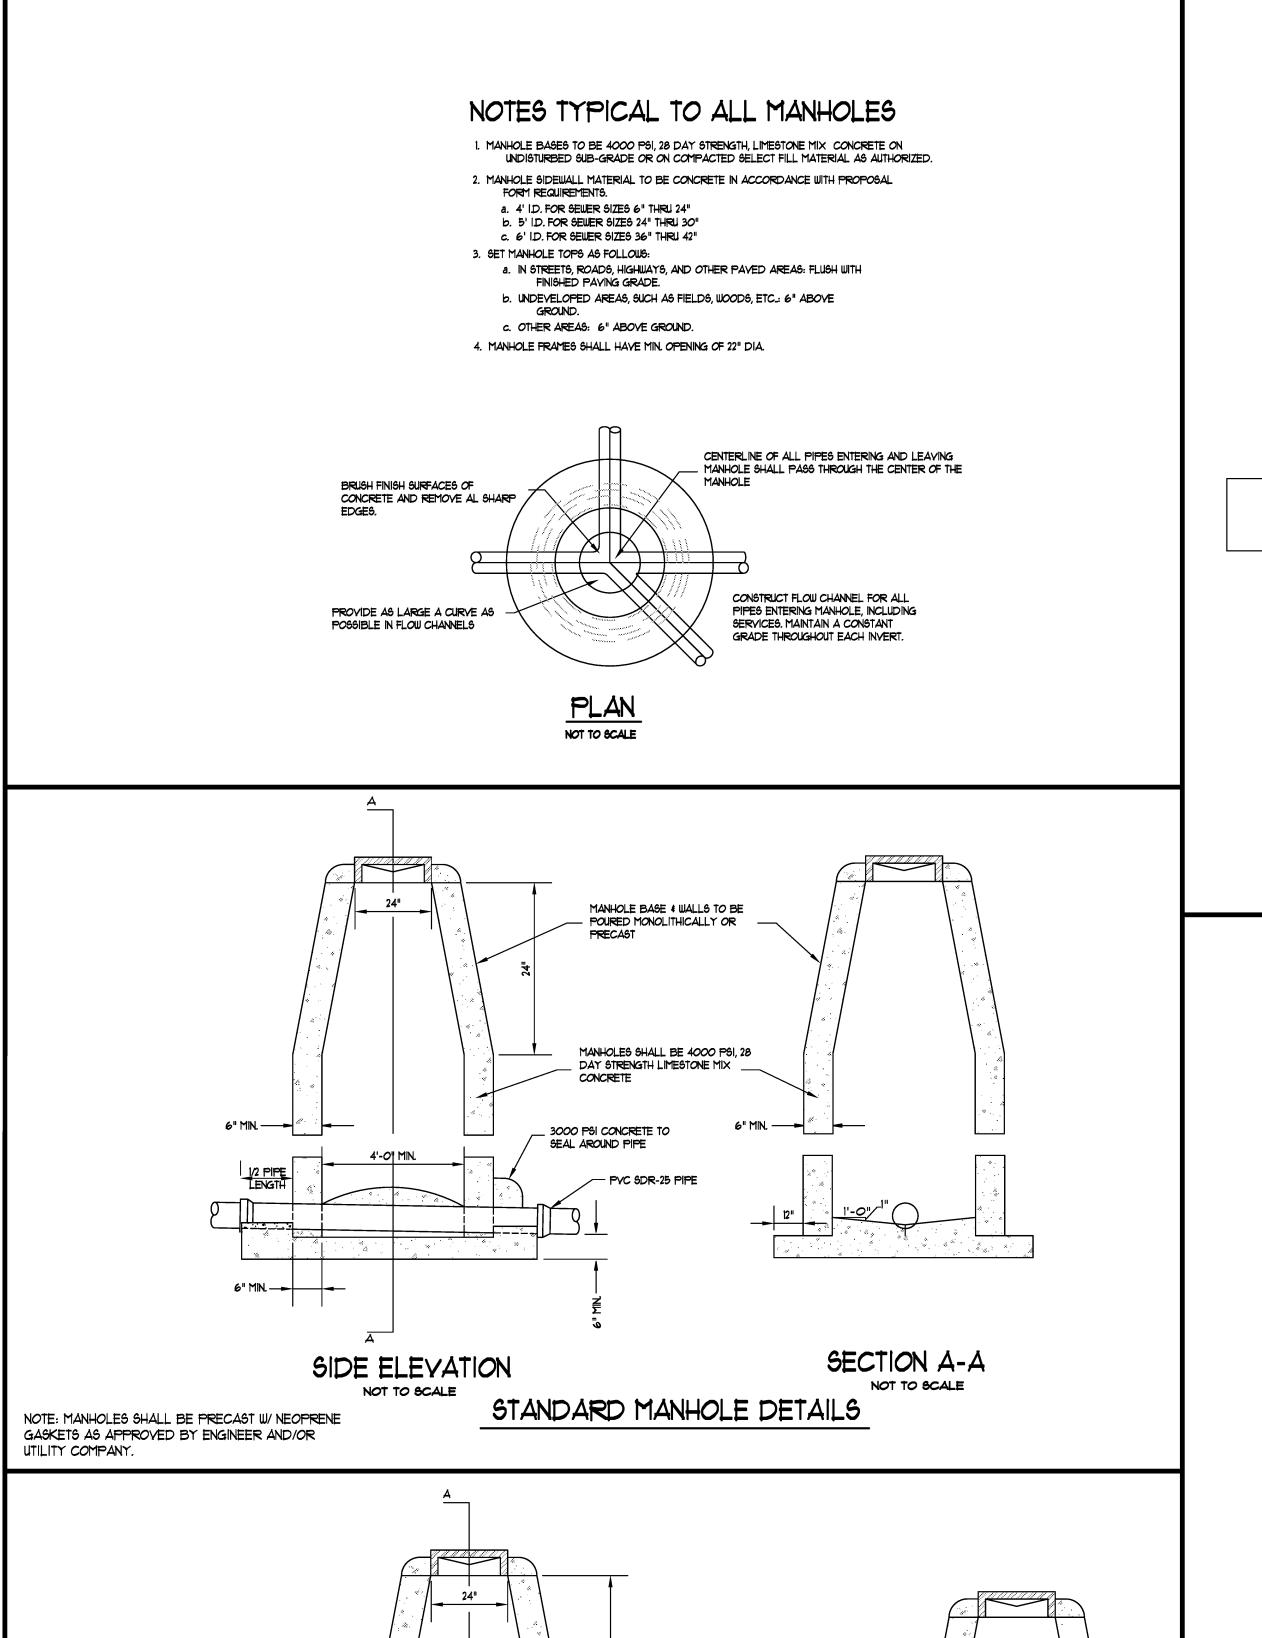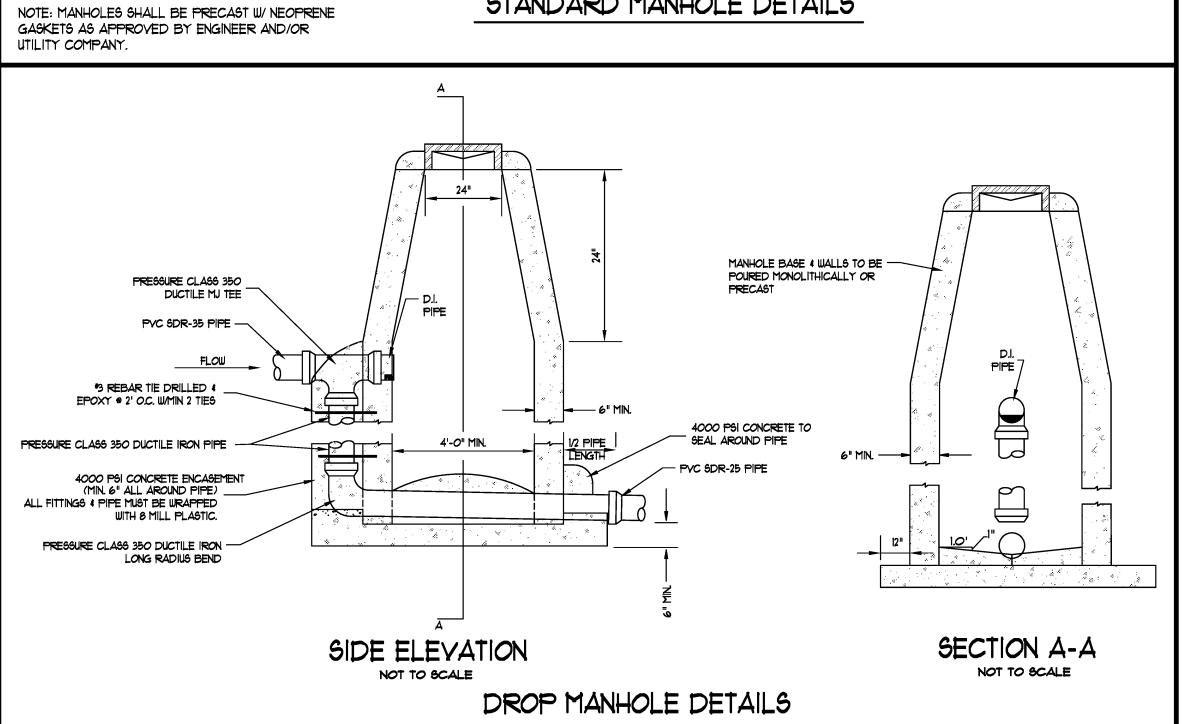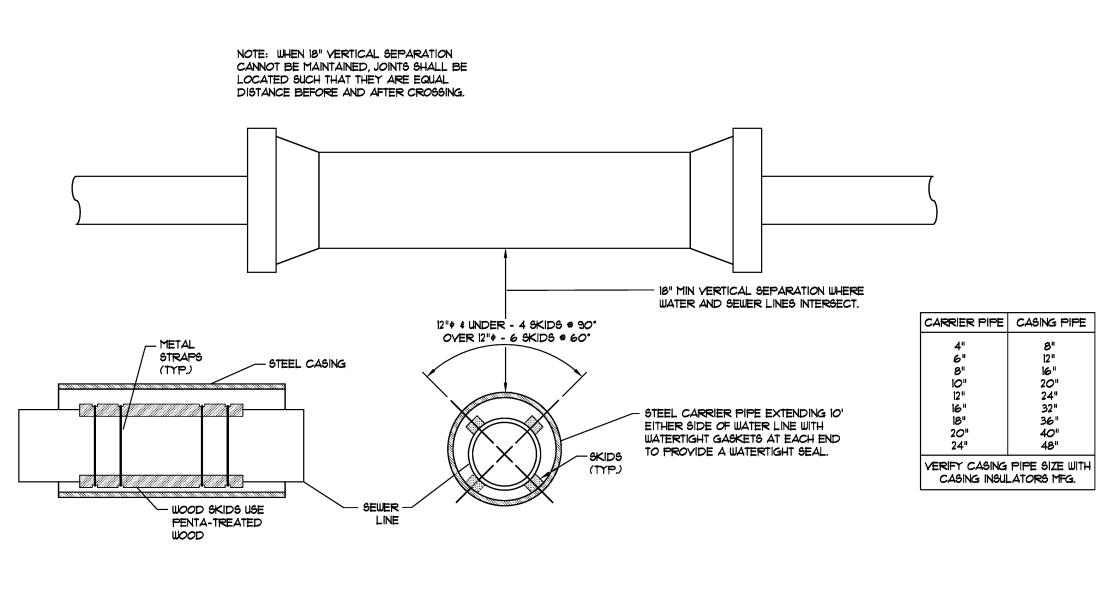3 07/01/16 REVISED BUILDING LOCATIONS, LOT CONFIGURATION AND PERRY DRIVE PER OWNER JME JME JONESBORO, ARKANSAS REVISED PER MAPC COMMENTS - STREET NAMES JME JME JME JME DRAWN: JME CHECKED: JME DATE: 01/28/16 REVISED SANITARY SEWER ALIGNMENT PER CWL DRAWN CHK'D SCALE: AS SHOWN CADD FILEBIOO-SDP-EY DWGA: REVISIONS









# WATER/SEWER CROSSING DETAIL WHERE ENCASEMENT REQUIRED NOT TO SCALE

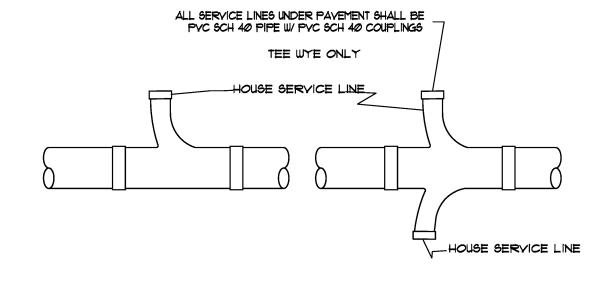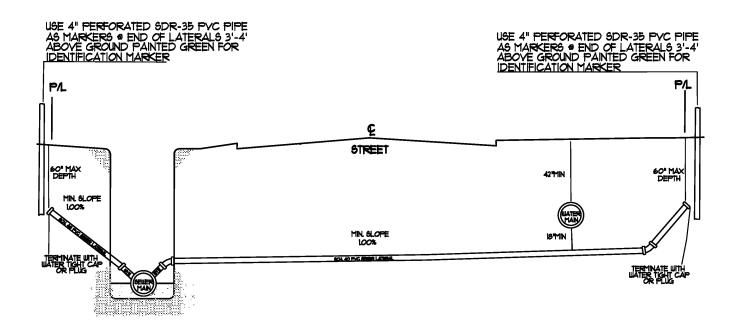SINGLE WYE DOUBLE WYE





SEWER LATERAL STUBOUT
PERMITS REQUIRED BEFORE INSTALLATION

NOTE: 1. COARSE AGGREGATE SHALL BE MECHANICALLY TAMPED WHEN USED. 2. PIPE IN TRENCH SHALL BE PLACED ON NO LESS THAN 4" OF 3/4" MINUS LIMESTONE. ALL OVER EXCAVATION SHALL BE COMPACTED BACK TO GRADE W/ BEDDING MATERIAL. 3. PVC PIPE SHALL BE SDR-25 AND INSTALLED IN ACCORDANCE WITH

UNI-BELL PYC PIPE ASSOCIATION'S RECOMMENDATIONS FOR CONSTRUCTION. ROUND FOR SETTLING

COMPACT 8"(MIN) 8B-2 IN PARKING AREAS, TO 98% MODIFIED PROCTOR -COARSE AGGREGATE BEDDING (3/4" MINUS LIMESTONE) TO SPRINGLINE OF COMPACT BACKFILL IN PARKING AREAS AND (PLACE BEDDING TO TOP OF PIPE PROPOSED STREET CROSSINGS TO 95% WHEN EXCAYATION IS ±14' DEEP MODIFIED PROCTOR W/ GRANULAR BASE FILL AND/OR IF LARGE ROCK IS IN (P.I. LESS THAN 15) OR SB-2 (USE NATIVE SOIL EXCAYATION) EXCAVATED IN AREAS NOT IN PROPOSED STREET, PARKING AREAS, AND EXISTING

> TRENCH DETAIL (NON-EXISTING STREET LOCATIONS)

EXISTING SURFACE MUST LEAVE FLOWABLE FILL: BE CUT WITH A 2" BELOW ASPHALT SURFACE SAW OR AIR CHISEL (EXCEPT GRAVEL STREET) 6" BELOW CONCRETE SURFACE 6" BELOW GRAVEL SURFACE AND REPLACED W/ SAME TYPE SURFACE EXISTING SURFACE -6x6/6-6 WWM (MIN.) IN CONCRETE ONLY FLOWABLE FILL SHALL HAVE MIN. 8" FLOW & 110°/CUFT & SHALL CONSIST OF 80-100° CEMENT 220-300 FLY ASH 65 GAL. OF WATER BALANCE VOLUME OF SAND TO MAKE I CUBIC YARD

# TRENCH DETAIL (EXISTING STREET LOCATIONS) NOT TO SCALE

NOTE: (1) CONTRACTOR SHALL OBTAIN A STREET CROSSING PERMIT FROM THE CITY OF

- JONESBORO PRIOR TO CUTTING STREET.
- (2) EXCAVATED MATERIAL SHALL BE REMOVED AND DISPOSED OF BY THE CONTRACTOR. (3) THIS REPAIR DETAIL IS REQUIRED FOR ALL EXCAVATION WITHIN 5' OF PAVED EDGE AND ALL TRANSVERSE EXCAVATIONS TO EXTEND 3' BEYOND PAYED EDGE.

ASSOCIATED ENGINEERING AND TESTING, LLC CIVIL ENGINEERING AND LAND SURVEYING SERVICES 103 SOUTH CHURCH STREET - P.O. BOX 1462 - JONESBORO, AR 12403 PH: 870-932-3594 FAX: 870-935-1263

SANITARY SEWER DISTRIBUTION DETAILS EMERALD VILLAGE

3 07/01/16 REVISED BUILDING LOCATIONS, LOT CONFIGURATION AND PERRY DRIVE PER QUINER JME JME REVISED PER MAPC COMMENTS - STREET NAMES JME JME 1 04/05/16 REVISED SANITARY SEWER ALIGNMENT PER CWL REY DATE REVISIONS

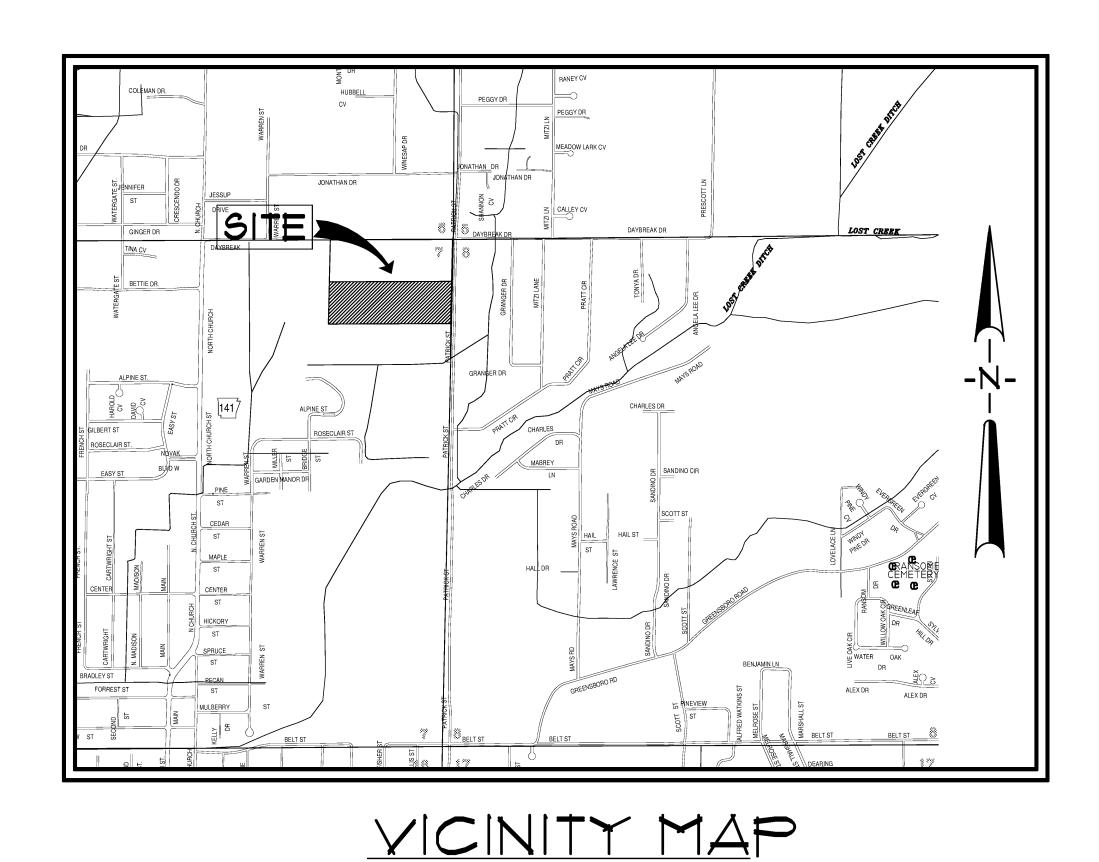
KWL PROPERTIES, LLC JONESBORO, ARKANSAS

JME JME DRAWN: JME CHECKED: JME DATE: 01/28/16 DRAWN CHK'D SCALE: AS SHOWN CADD FILEBIOO-SDP-EY DWGA:

# SITE DEVELOPMENT PLANS

# EMERALD VILLAGE

LYING IN SECTION 7, TOWNSHIP 14 NORTH, RANGE 4 EAST, CRAIGHEAD COUNTY, JONESBORO, ARKANSAS FEBRUARY, 2016




SCALE: 1" = 1000'

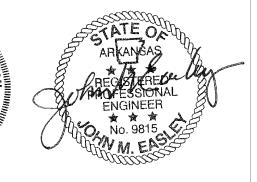INDEX SHEET AREA MAP TOPOGRAPHIC MAP RECORD PLAT SITE PLAN UTILITY PLAN DRAINAGE PLAN EROSION CONTROL PLAN STREET PROFILES STANDARD DETAILS EROSION CONTROL DETAILS








ASSOCIATED ENGINEERING AND TESTING, LLC CIVIL ENGINEERING AND LAND SURVEYING SERVICES 103 SOUTH CHURCH STREET - P.O. BOX 1462 - JONESBORO, AR 72403 PH: 870-932-3594 FAX: 870-935-1263


> INDEX SHEET EMERALD VILLAGE KWL PROPERTIES, LLC


3 OT/OI/16 REVISED BUILDING LOCATIONS, LOT CONFIGURATION AND PERRY DRIVE PER OWNER JME JME JME JME REVISED SANITARY SEWER ALIGNMENT PER CWL REY DATE

JONESBORO, ARKANSAS JME JME DRAWN: CCH CHECKED: JME DATE: 01/28/16

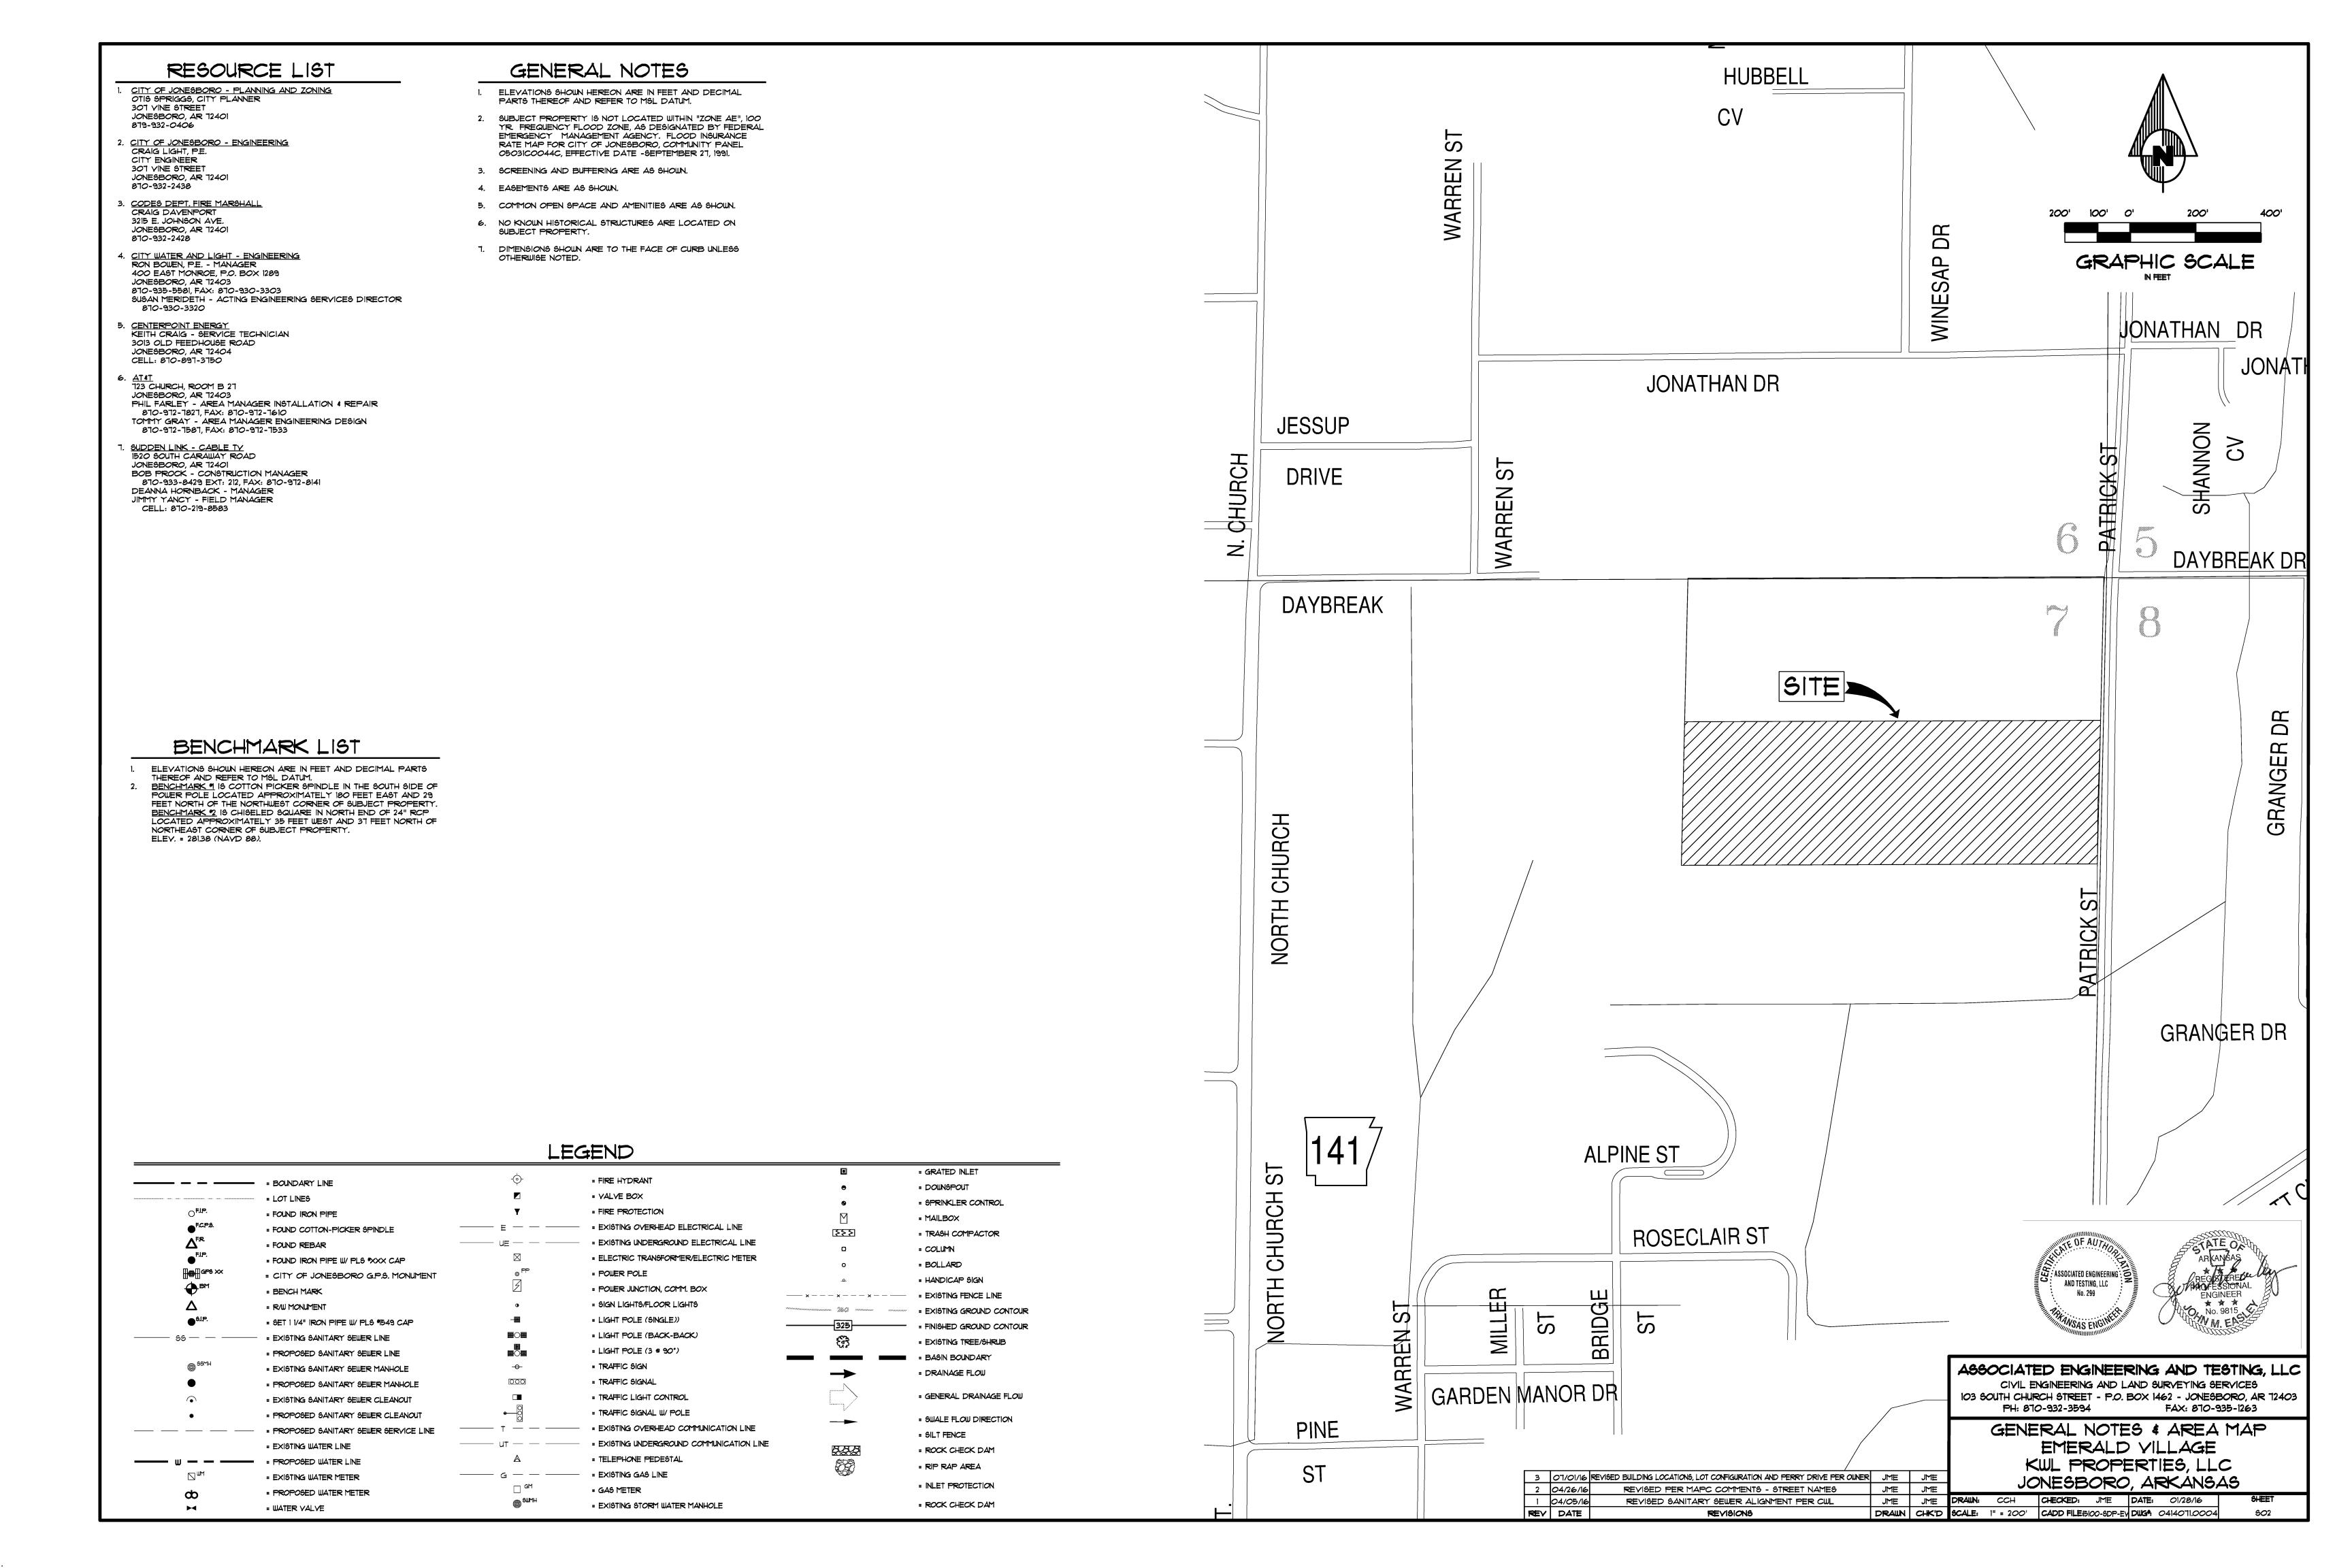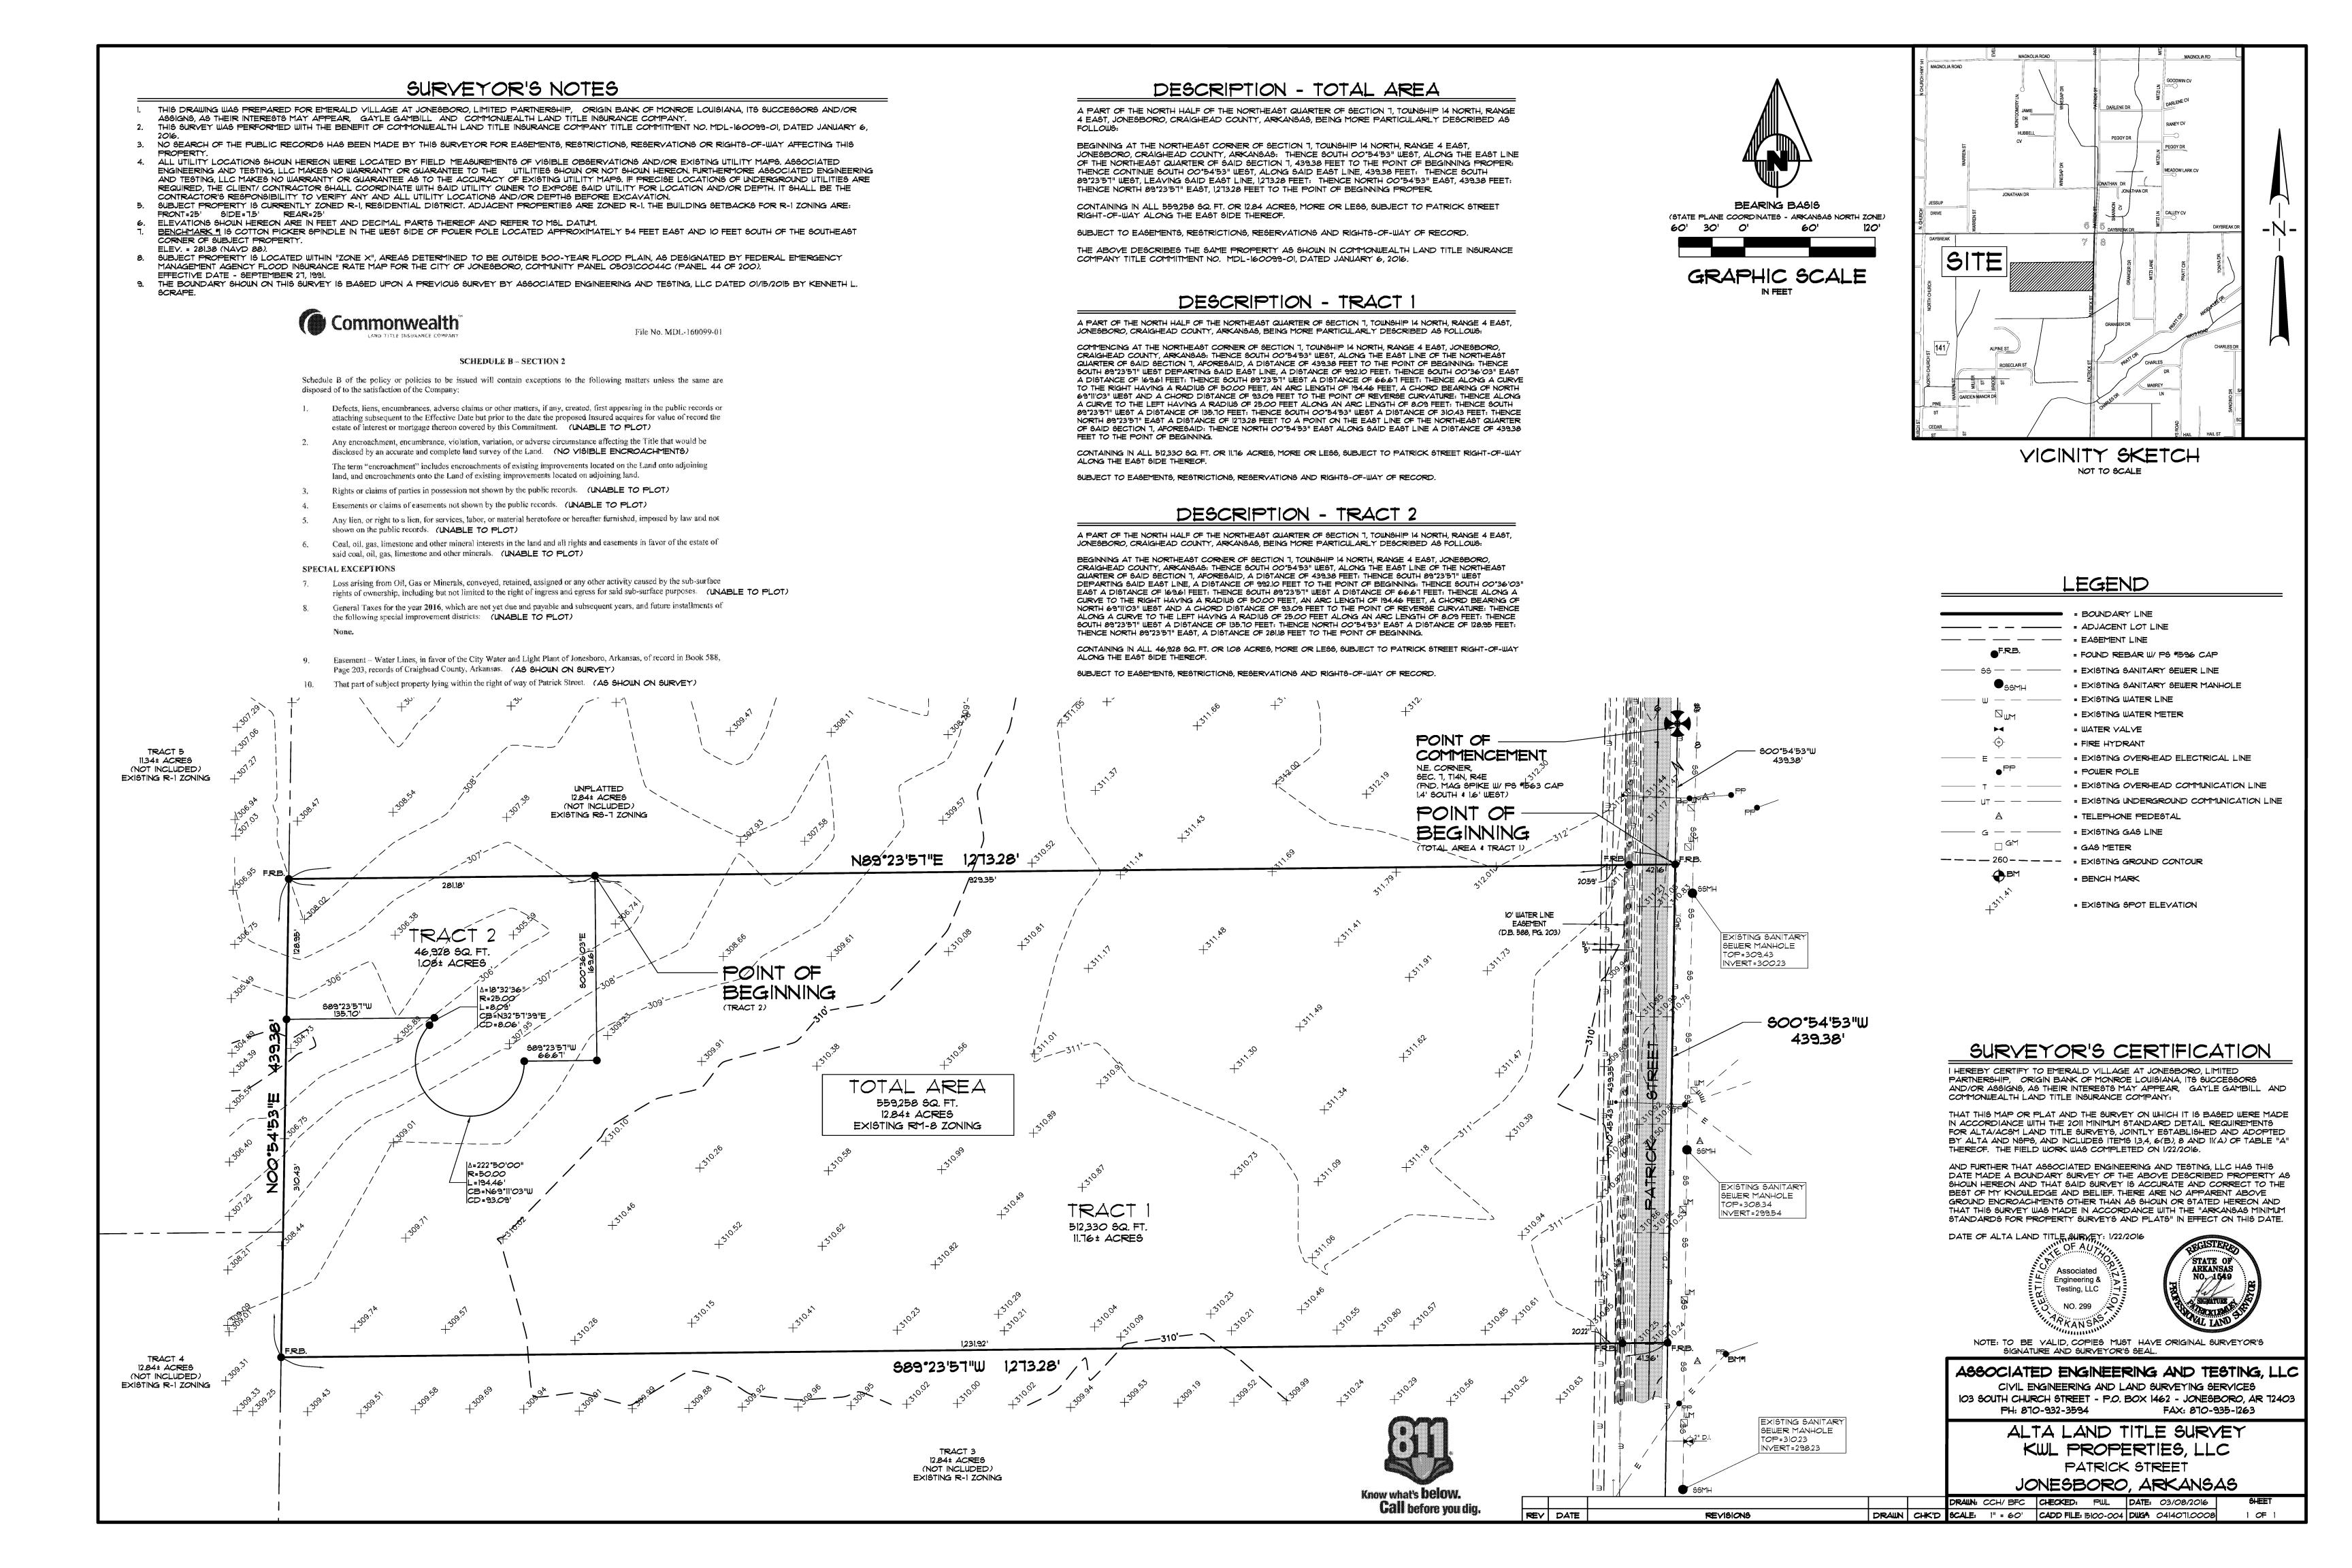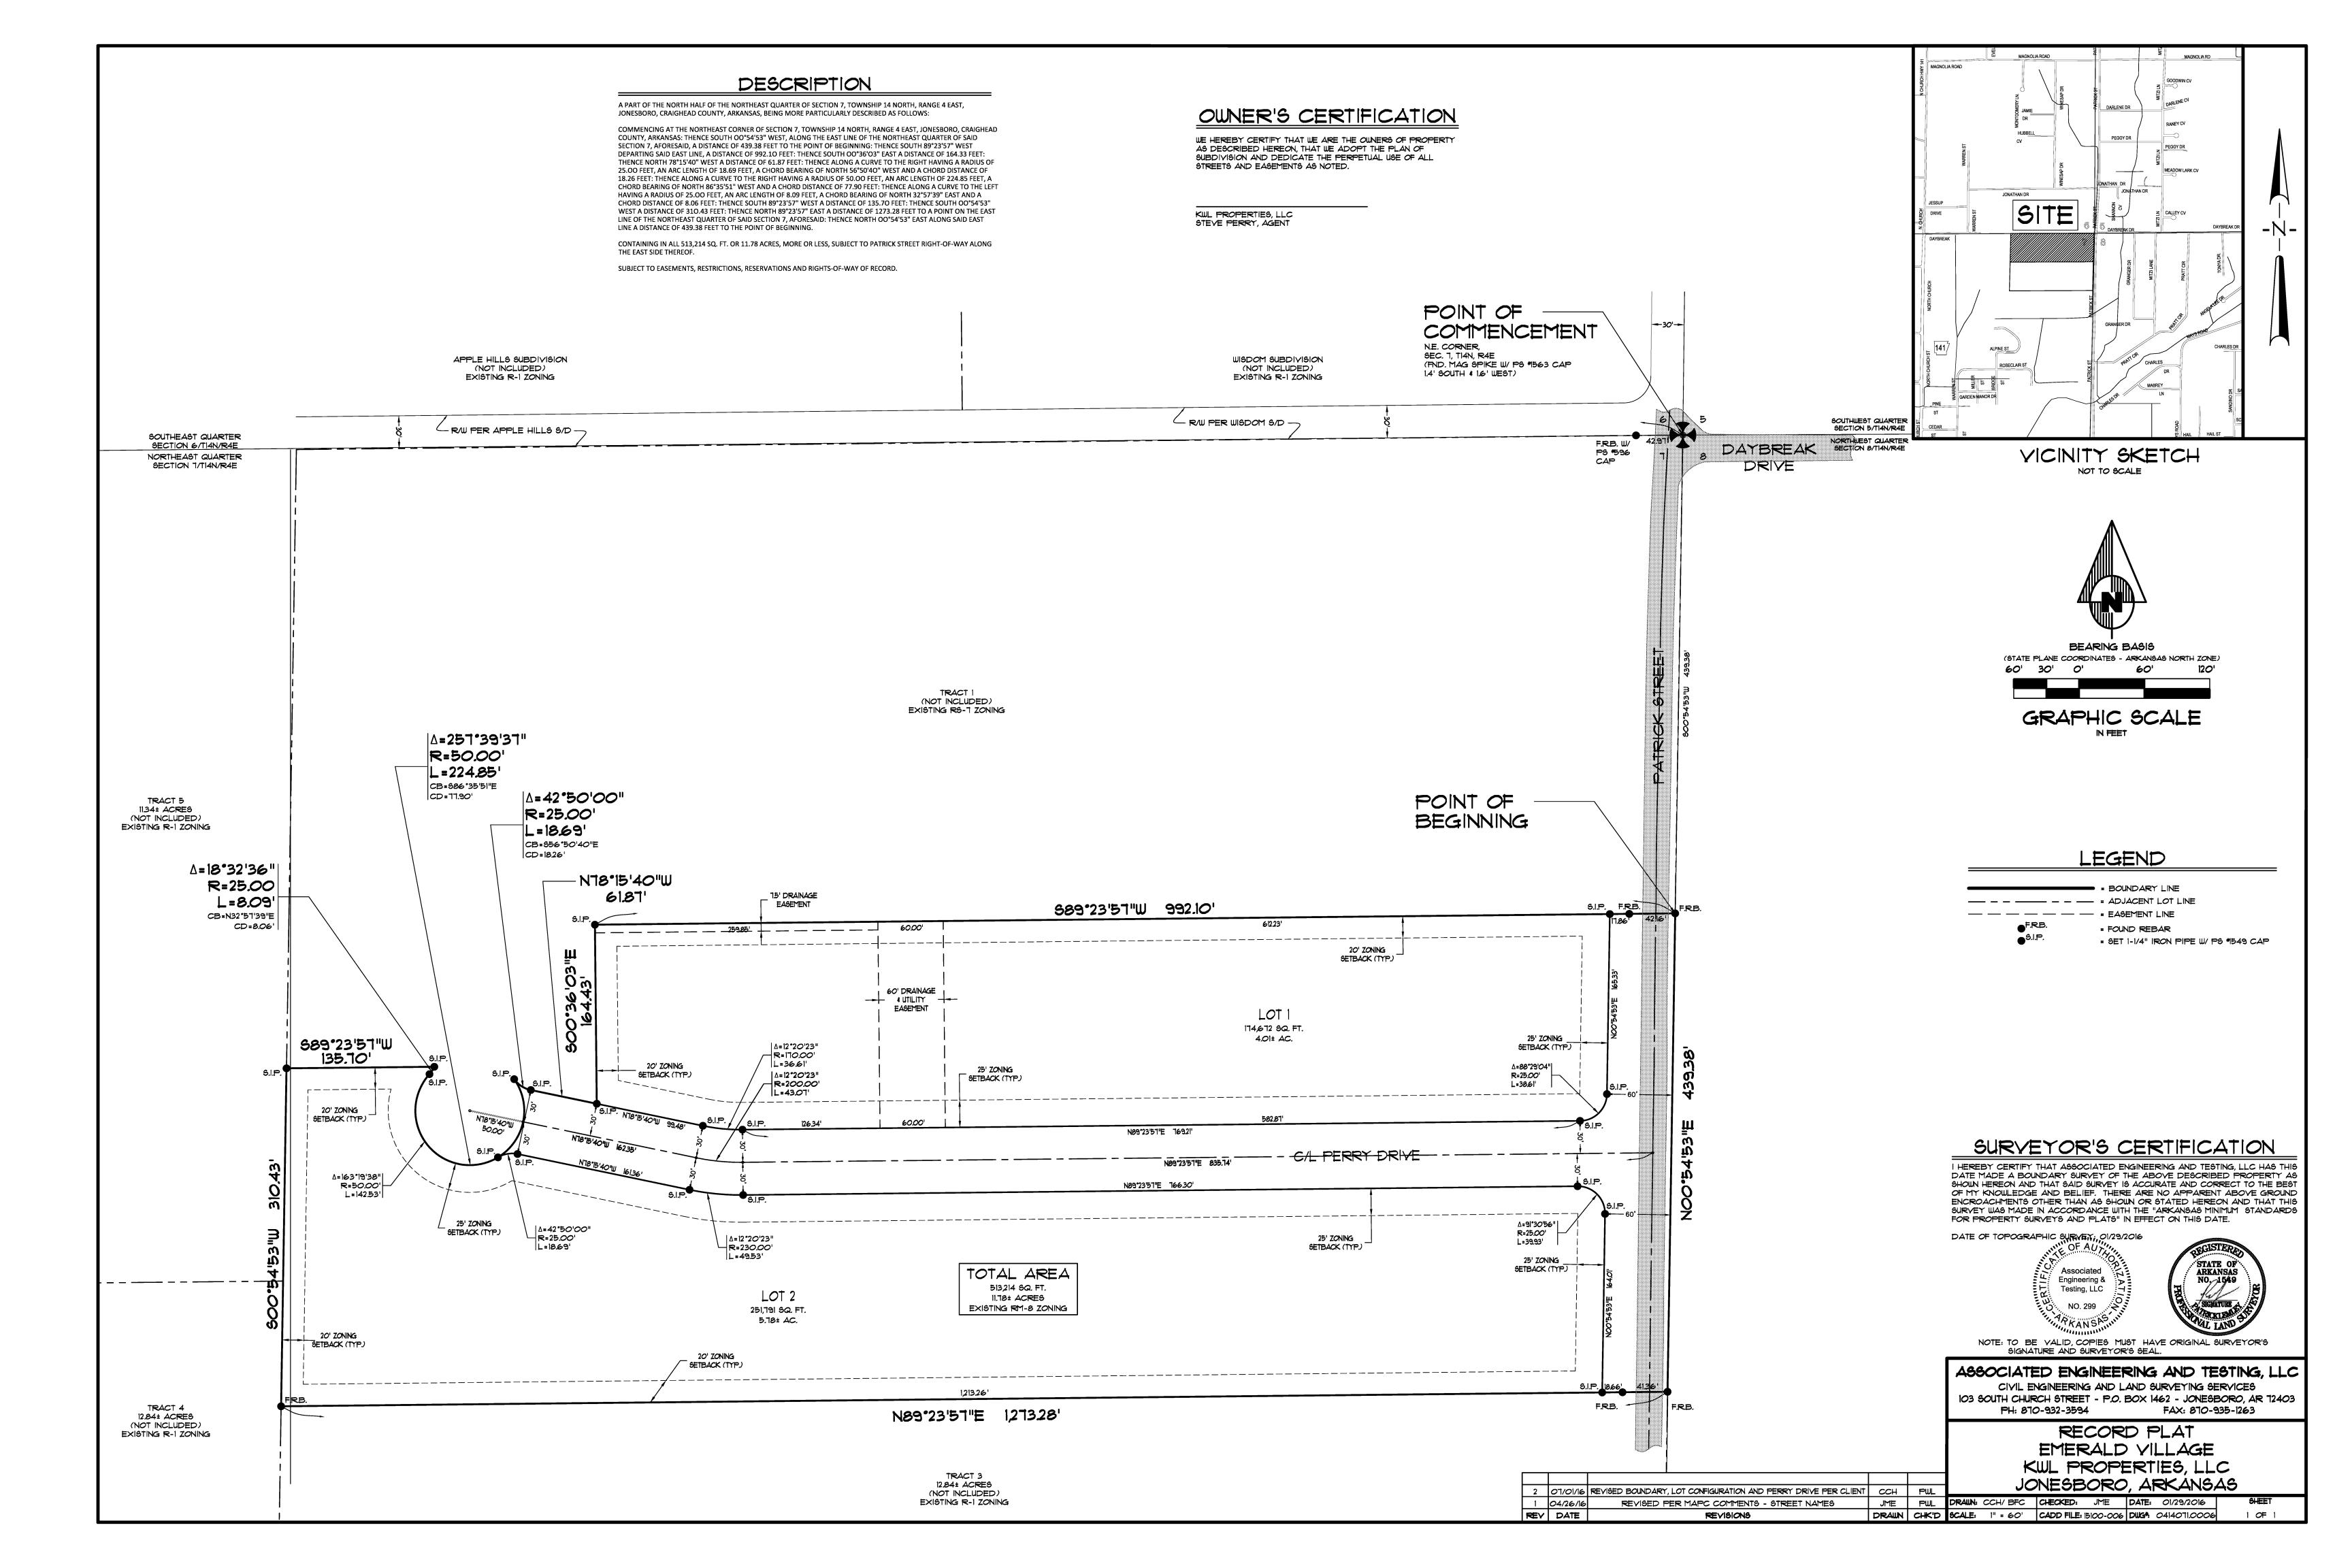DRAWN CHK'D SCALE: 1" = 1000' CADD FILEIBIOO-SDP-EV DUGA: 0414071.0004








site Plan - Landscaping Zone a

HE MULTI-FAMILY ELDERLY DEVELOPMENT FOR:


"HE MERCHALD VILLAGE

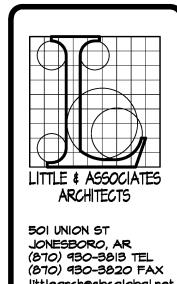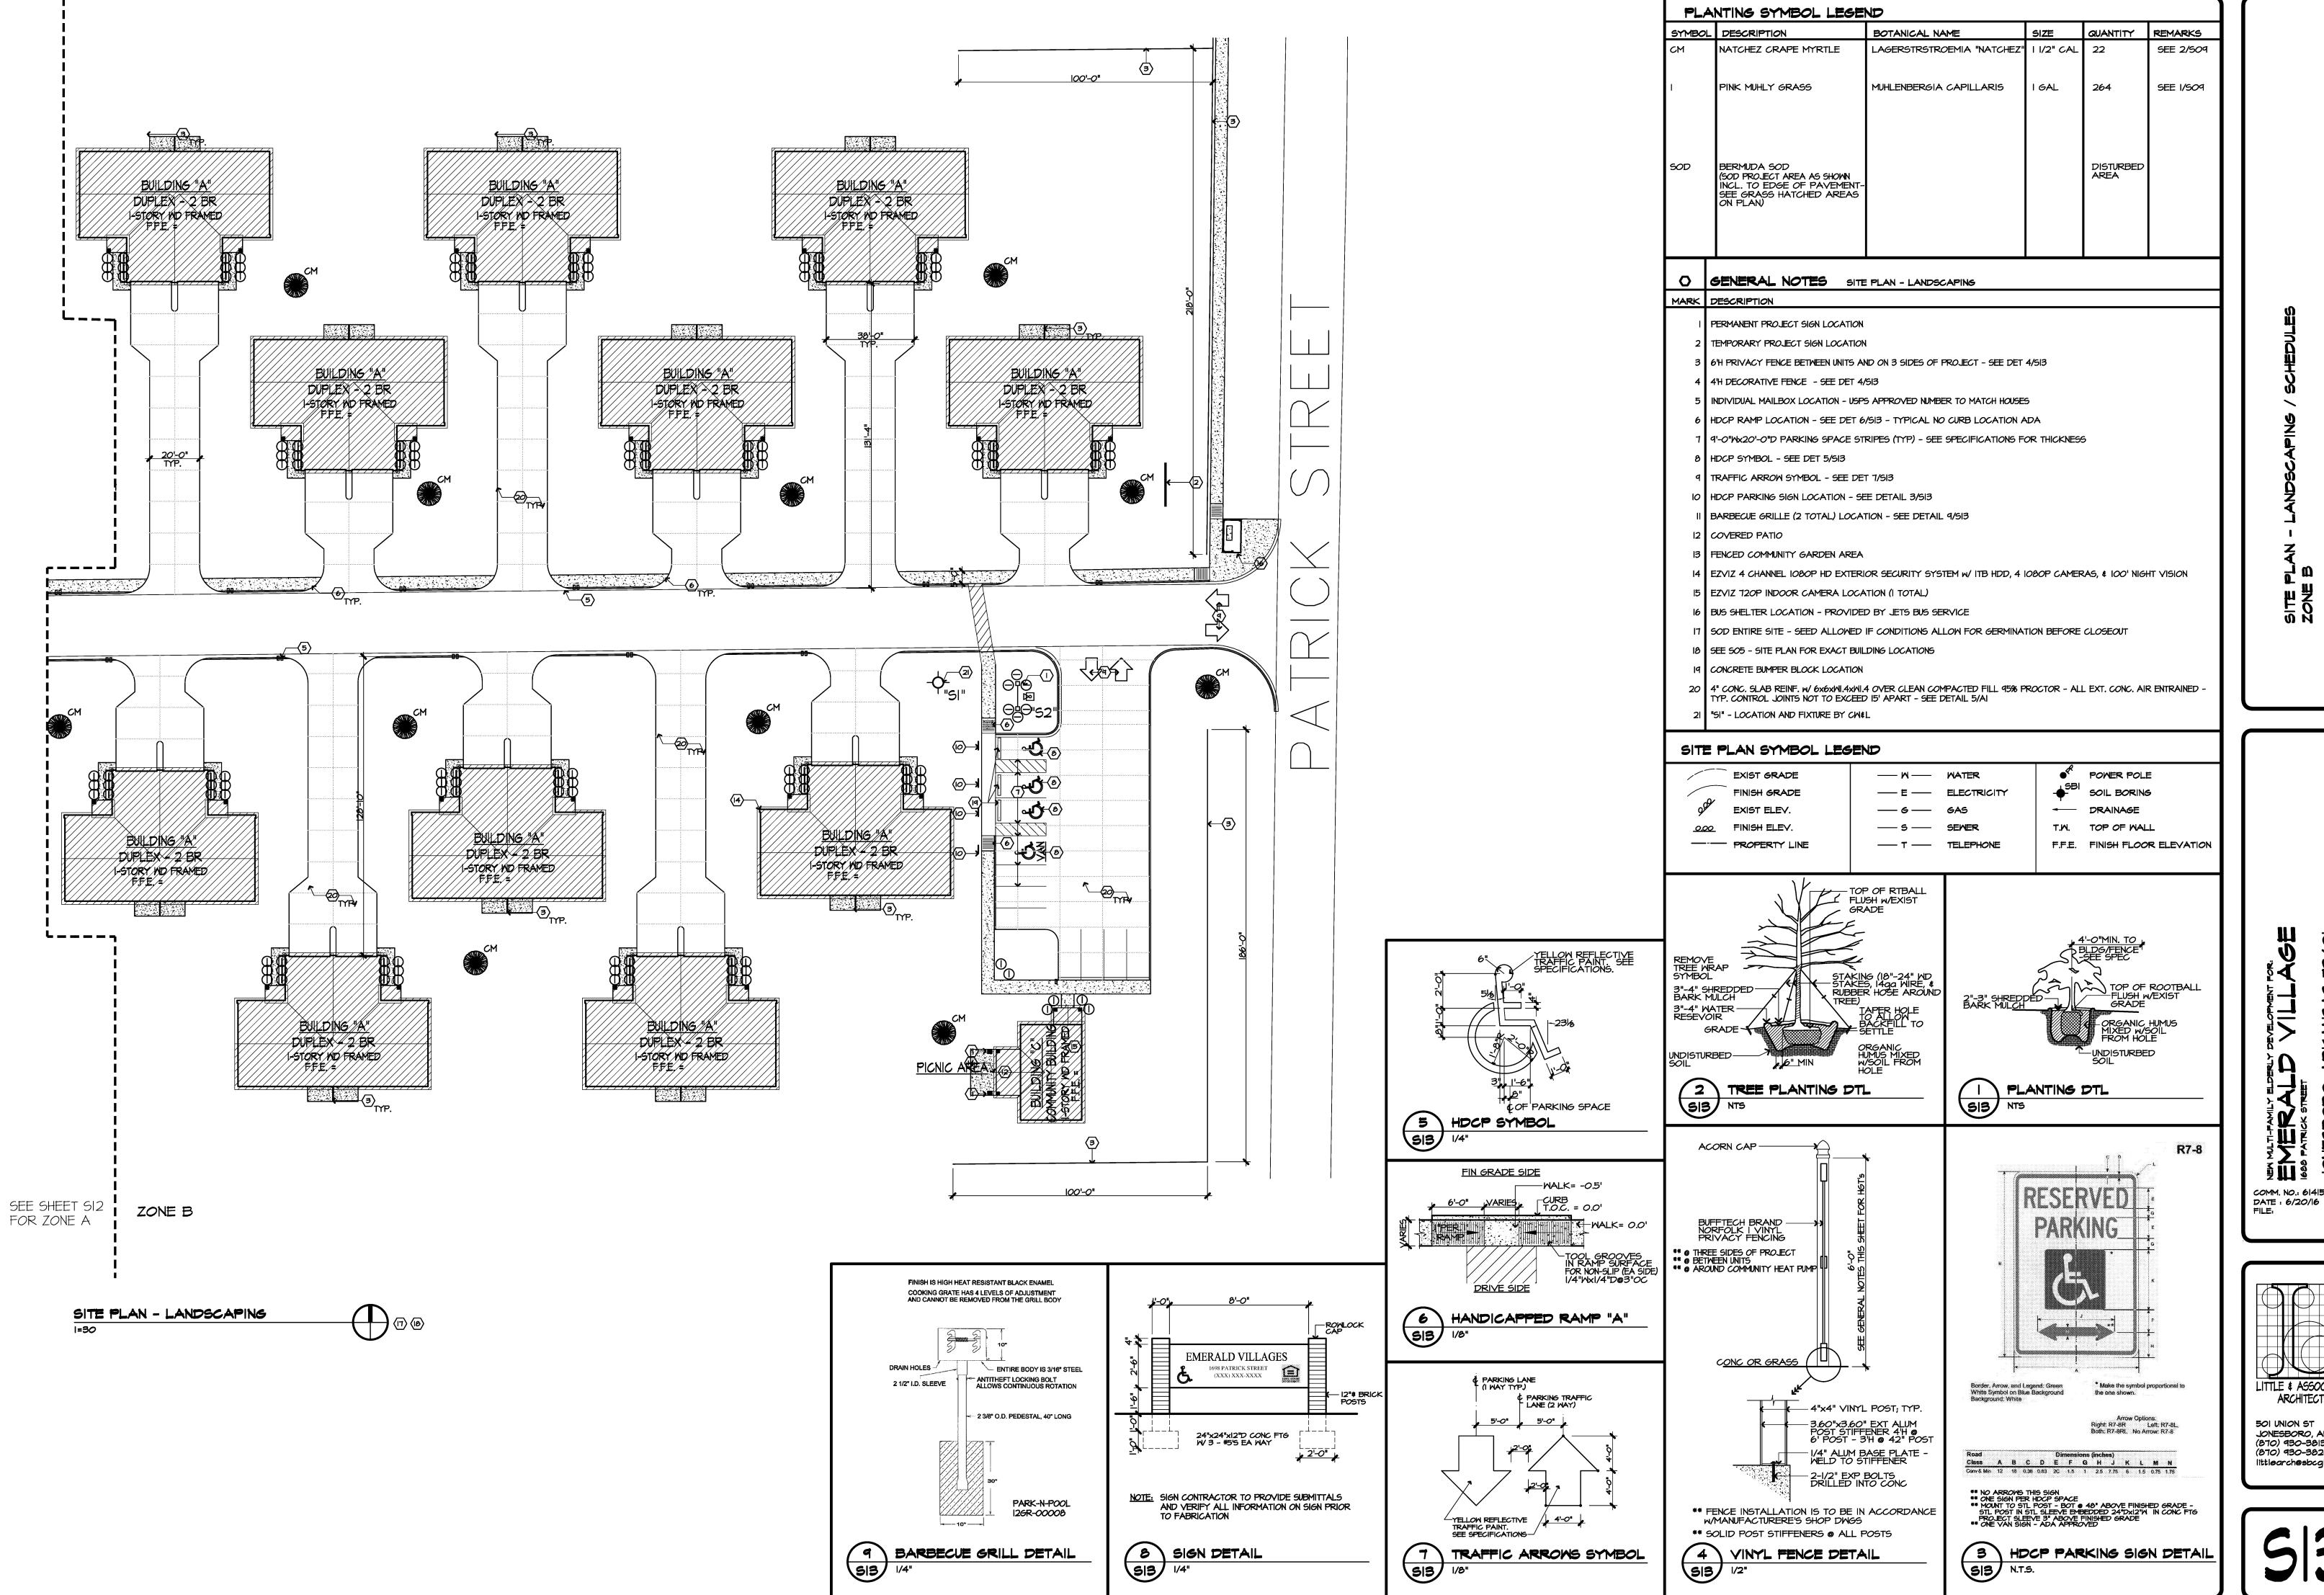ONESBORO, ARKANSAS 12401



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