PROPERTY OWNER: THE FORUM 115 E MONROE AVE JONESBORO, AR 72401 PHONE: 870.935.2726

ARCHITECT:
COOPER MIXON ARCHITECTS 505 UNION STREET, SECOND FLOOR JONESBORO, AR 72401 PHONE: 870.336.0536

AUTHORITY HAVING JURISDICTION

JONESBORO, ARKANSAS - FIRE MARSHAL

2012 International Building Codes 2012 International Residential Codes

APPLICABLE CODES

2010 ADA Standards for Accessibility 2012 Existing Building Code 2012 Arkansas Fire Prevention Code Vol. I: Fire 2012 Arkansas Fire Prevention Code Vol. II: Building 2012 Arkansas Fire Prevention Code Vol. III: Residential 2006 APC: Arkansas Plumbing Codes 2010 AMC: Arkansas Mechanical Codes 2017 NEC: National Electrical Codes 2006 AFAG: Arkansas Fuel and Gas Codes 2014 Arkansas Energy Code (2009 IECC w/ supplements & amendments)

2003 ICC/ANSI A117.1: American National Standards(ADA requirements)

GENERAL NOTES

- 1. FIELD VERIFY ALL MEASUREMENTS REQUIRED. USE DIMENSIONS SHOWN ON DRAWINGS AND ACTUAL FIELD MEASUREMENTS. DO NOT SCALE DRAWINGS. VERIFY ALL DIMENSIONS AND CONDITIONS AND NOTIFY ARCHITECT OF ANY DISCREPANCIES IN WRITING BEFORE PROCEEDING WITH WORK.
- 2. PRIOR TO THE SUBMISSION OF BIDS, THE CONTRACTOR SHALL VISIT THE SITE AND BE RESPONSIBLE FOR COORDINATING THE EXISTING CONDITIONS WITH THE WORK SPECIFIED IN THE CONTRACT DOCUMENTS, TO CONFIRM THAT THE INTENT OF THE CONTRACT DOCUMENTS CAN BE FULFILLED. NOTIFY THE ARCHITECT IN WRITING OF ALL DISCREPANCIES.
- 3. CONTRACTOR SHALL RECEIVE IN WRITING, AUTHORIZATION TO PROCEED BEFORE STARTING ANY WORK THAT IS NOT CLEARLY DEFINED BY THE CONTRACT DOCUMENTS.
- 4. CONTRACTORS SHALL INSTALL ALL EQUIPMENT AND MATERIALS IN ACCORDANCE WITH MANUFACTURERS RECOMMENDATIONS UNLESS SPECIFICALLY, OR OTHERWISE INDICATED, OR WHERE APPLICABLE CODES OR REGULATIONS TAKE PRECEDENCE.
- 5. ALL WORK PERFORMED AND MATERIALS INSTALLED SHALL BE IN STRICT ACCORDANCE WITH ALL APPLICABLE CODES, REGULATIONS AND ORDINANCES. CONTRACTOR SHALL GIVE NOTICES AND COMPLY WITH ALL LAWS, ORDINANCES RULE, REGULATIONS AND LAWFUL ORDERS OF ANY PUBLIC AUTHORITY BEARING ON PERFORMANCE OF THE WORK. MECHANICAL, ELECTRICAL SYSTEMS SHALL BE INSTALLED IN ACCORDANCE WITH ALL APPLICABLE MUNICIPAL AND UTILITY COMPANY SPECIFICATIONS, LOCAL AND STATE JURISDICTIONS, ORDINANCES, AND APPLICABLE REGULATIONS.
- 6. GENERAL CONTRACTOR OR CONSTRUCTION MANAGER SHALL SUPERVISE, AND DIRECT THE WORK. CONTRACTORS SHALL BE SOLELY RESPONSIBLE FOR ALL CONSTRUCTION MEANS, METHODS, TECHNIQUES, SEQUENCES AND PROCEDURES FOR COORDINATING ALL PORTIONS OF THE WORK UNDER THE CONTRACT, INCLUDING CONTRACT AND COORDINATION WITH ALL AUTHORIZED OWNER REPRESENTATIVES.
- 7. DETAILS ARE INTENDED TO SHOW THE END RESULT OF THE DESIGN AND PERFORMANCE, MINOR MODIFICATIONS MAY BE REQUIRED TO SUIT EXISTING CONDITIONS. SUCH MODIFICATIONS SHALL BE INCLUDED AS PART OF THE WORK.
- 8. CONTRACTORS SHALL VERIFY LOCATIONS OF ALL UTILITIES AND SERVICES PRIOR TO PROCEEDING WITH THE WORK TO ENSURE PROPER COORDINATION, SEQUENCING AND INSTALLATION OF NEW WORK.
- 9. PROVIDE FIRE SEALANT TO PERIMETER OF ALL PIPING, HVAC SLEEVING OR OTHER TYPE OF THRU-WALL PENETRATION.
- 10. NOTIFY ARCHITECT IMMEDIATELY OF ANY UNFORESEEN CONDITIONS FOR DIRECTION BEFORE PROCEEDING WITH WORK.
- 11. PAINT ALL EXPOSED SURFACES, EXCEPT WHERE ITEMS ARE SCHEDULED TO REMAIN NATURAL OR ARE OTHERWISE RESTRICTED BY LOCAL CODES, ORDINANCES OR AUTHORITIES HAVING JURISDICTION
- 12. COORDINATE/VERIFY WITH ARCHITECT EXTERIOR LIGHTING MOUNTING HEIGHTS.

ABV A.F.F. ACOUS	ABOVE ABOVE FINISH FLOOR ACOUSTICAL	F.E.C. F.H.C. FLASH	FIRE EXTINGUISHER CABINET FIRE HOSE CABINET FLASHING	PGLS PLYWD PP	PLATE GLASS PLYWOOD POWER POLE
ACOUS A/C	ACOUSTICAL AIR CONDITIONING	FLASH	FLASHING FLOOR (ING)	P.V.C.	POLYVINYL CHLORIDE
ALT	ALTERNATE	FLCO	FLOOR CLEANOUT	P.C.C.	PRE-CAST CONCRETE
ALUM	ALUMINUM	F.D.	FLOOR DRAIN	PEMB	PRE-ENGINEERED
A.B. L	ANCHOR BOLT ANGLE	FLOUR FT	FLUORESCENT FOOT OR FEET	PFAB	METAL BUILDING PREFABRICATED
@	AT	FTG	FOOTING	P.T.D.F.	PRESSURE TREATED
APPROX	APPROXIMATE	FDN	FOUNDATION		DOUGLAS FIR
ARCH	ARCHITECTURE (URAL)	0.1117	0.41.\/.41.11755		PROPERTY LINE
A.D. A.C.	AREA DRAIN ASPHALT CONCRETE	GALV GA	GALVANIZED GAUGE	PL	PROPERTY LINE
ASPH	ASPHALT	G.C.	GENERAL CONTRACTOR	Q.T.	QUARRY TILE
		GLS	GLASS		
BM	BEAM	GLS BLK	GLASS BLOCK	RAD	RADIUS
BLW B.G.	BELOW BELOW GRADE	GLB G.B.	GLUE LAM BEAM GRAB BAR	REDWD REF or RE:	REDWOOD REFERENCE
B.M.	BENCH MARK	G.B. GR	GRADE, GRADING	REINF	REINFORCE (D) (ING)
BLK	BLOCK	GND	GROUND	RA	RETURN AIR
BLKG	BLOCKING	GYP BD	GYPSUM BOARD	REV	REVISION
BD B.O.B.	BOARD BOTTOM OF BEAM	HC	HANDICAPPED	REQD R.O.W.	REQUIRED (ING) RIGHT OF WAY
BOT	BOTTOM	HDW	HARDWARE	R	RISER
BLDG	BUILDING	HDR	HEADER	RF	ROOF
B.U.R.	BUILT-UP ROOFING	HVAC	HEATING/VENTILATION/	RFG RD	ROOFING ROOF DRAIN
CAB	CABINET	H.D.	AIR CONDITIONING HEAVY DUTY	RFH	ROOF DRAIN ROOF HATCH
CFMS	COLD FORMED METAL STUD	HGT	HEIGHT	RM	ROOM
CRPT	CARPET	H.C.	HOLLOW CORE	R.O.	ROUGH OPENING
CSMT CLG	CASEMENT CEILING	H.M. or HM HORIZ	HOLLOW METAL HORIZONTAL	SCH	SCHEDULE
CTR	CENTER	H.B.	HOSE BIBB	SEC	SECTION
CL	CENTER LINE	HR	HOUR	SHTG	SHEATHING
CEM	CEMENT	INIO	INCLUDE	SHT	SHEET
CLR CLO	CLEAR CLOSET	INCL INFO	INCLUDE INFORMATION	SIM SL	SIMILAR SKYLIGHT
C.O.	CLEAN OUT	I.D.	INSIDE DIAMETER	SC	SOLID CORE
COL	COLUMN	INSUL	INSULATE, INSULATION	S	SOUTH
COMB CONC	COMBINATION CONCRETE	INT INSTALL	INTERIOR INSTALLATION	SPECS SQ	SPECIFICATIONS SQUARE
CMU	CONCRETE MASONRY UNIT	INSTALL	INSTALLATION	SS	STAINLESS STEEL
COND	CONDENSATE	JST	JOIST	STD	STANDARD
CONN	CONNECTION	J	JOINT	STL	STEEL
CONST CONT	CONSTRUCTION CONTINUOUS (ATION)	ко	KNOCKOUT	STOR SD	STORAGE STORM DRAIN
CONTR	CONTRACTOR	KPLT	KICKPLATE	STRUCT	STRUCTURAL
C.J.	CONTROL JOINT	= .		SUS	SUSPENDED
CORR	CORRUGATED	L.B.	LAG BOLT	S.C.	SUBCONTRACTOR
C.S. CFT	COUNTERSINK CUBIC FOOT	LAM LT	LAMINATE LIGHT	SYS	SYSTEM
CYD	CUBIC YARD	LWC	LIGHT LIGHTWEIGHT CONCRETE	TEL	TELEPHONE
		LVR	LOUVER	TEMP	TEMPORARY
DEMO DEPT	DEMOLITION	MATL	MATERIAL	THK T & G	THICK
DET	DEPARTMENT DETAIL	MATE	MANAGEMENT	T.O.B.	TONGUE AND GROOVE TOP OF BEAM
DIAG	DIAGONAL	MFG	MANUFACTURER	T.O.C.	TOP OF CURB
DIA	DIAMETER	MAS	MASONRY	T.O.L.	TOP OF LEDGER
DIM DISP	DIMENSION DISPENSER	M.O. MAT	MASONRY OPENING MATERIAL	T.O.P. T.O.P.	TOP OF PARAPET TOP OF PAVEMENT
DR	DOOR	MH	MANHOLE	T.O.PL.	TOP OF PLATE
DBL	DOUBLE	MAX	MAXIMUM	T.O.S.	TOP OF SLAB
DN	DOWN	MECH	MECHANICAL	T.O.T.	TOP OF TRUSS
D.S. DWR	DOWN SPOUT DRAWER	MBR MEMB	MEMBER MEMBRANE	T.O.W.	TOP OF WALL TREAD
DWG	DRAWING	MTL	METAL	TYP	TYPICAL
D	DRAIN	MTR	METER	U.G.	UNDERGROUND
E	EAST	MIN MISC	MINIMUM MISCELLANEOUS	UNF U.N.O.	UNFINISHED UNLESS NOTED OTHERWISE
E EA	EAST	IVIIOU	WIISCELLANECUS	U.N.O. UR	URINAL
EL	ELEVATION	(N)	NEW	Ü	UTILITIES
ELEC	ELECTRIC (AL)	NOM	NOMINAL	V D	VADOD BARRIED
ELEV ENCL	ELEVATOR ENCLOSE (URE)	N N.I.C.	NORTH NOT IN CONTRACT	V.B. V.I.F.	VAPOR BARRIER VERIFY IN FIELD
E.N.	END NAILING	N.T.S.	NOT TO SCALE	VERT	VERTICAL
ENG	ENGINEER (ING)	NO.	NUMBER	VEST	VESTIBULE
EQ EQUID	EQUAL EQUIPMENT	O.C.	ON CENTER	VIN.	VINYL VINYL BASE
EQUIP EXH	EXHAUST	O.C. OPAQ	OPAQUE	V.B.	VIIVI L DAGE
(E)	EXISTING	OPNG	OPENING	W.H.	WALL HUNG
E.J.	EXPANSION JOINT	O.D.	OUTSIDE DIAMETER	W TO W	WALL TO WALL
EXT	EXTERIOR	O.H. O/HANG	OVERHEAD OVERHANG	W/C W/H	WATER CLOSET WATER HEATER
F.O.C.	FACE OF CONCRETE (CURB)	5/11/1110	5.2	WP	WATERPROOF
F.O.F.	FACE OF FINISH	PR	PAIR	W.R.	WATER RESISTANT
F.O.M.	FACE OF MASONRY FACE OF STUB	PKG d	PARKING PENNY	WT W.W.M.	WEIGHT WELDED WIRE MESH
F.O.S. FGLS	FIBERGLASS	a P.C.F.	PENNY PER CUBIC FOOT	VV.VV.M.	WEST
F.N.	FIELD NAILING	P.L.F.	PER LINEAL FOOT	WDW	WINDOW
FIN	FINISH	P.S.F.	PER SQUARE FOOT	W/	WITH
F.G. F.F.	FINISH GRADE FINISH FLOOR	P.S.I. P	PER SQUARE INCH PLATE	W/IN W/O	WITHIN WITHOUT
r.r. F.F.E.	FINISH FLOOR FINISH FLOOR ELEVATION	P PL	PLATE PLATE LINE	WD WD	WOOD
F.A.	FIRE ALARM			W.B.	WOOD BASE
F.E.	FIRE EXTINGUISHER			W.I.	WROUGHT IRON
F.E.B.	FIRE EXTINGUISHER ON BRACKET				
	ON DIVIONET				

PROJECT ABBREVIATIONS


REFERENCE SYMBOLS 1 1/2" X/AXXX INTERIOR ELEVATION LINEAR DIMENSION **REVISION BUBBLE** EXTERIOR ELEVATION **ROOM NAME** Χ **ROOM TAG BUILDING SECTION** WINDOW TYPE WALL SECTION **COLUMN GRID & BUBBLE** DETAIL (XXX) **ELEVATION MARK** DOOR TAG PARTITION TYPE BREAK LINE NORTH ARROW (CLG. HEIGHT) BACK REF.

CEILING TAG


DRAWING TITLE



NEW TICKET BOOTH & CONCESSION FOR: THE FORUM JONESBORO, AR

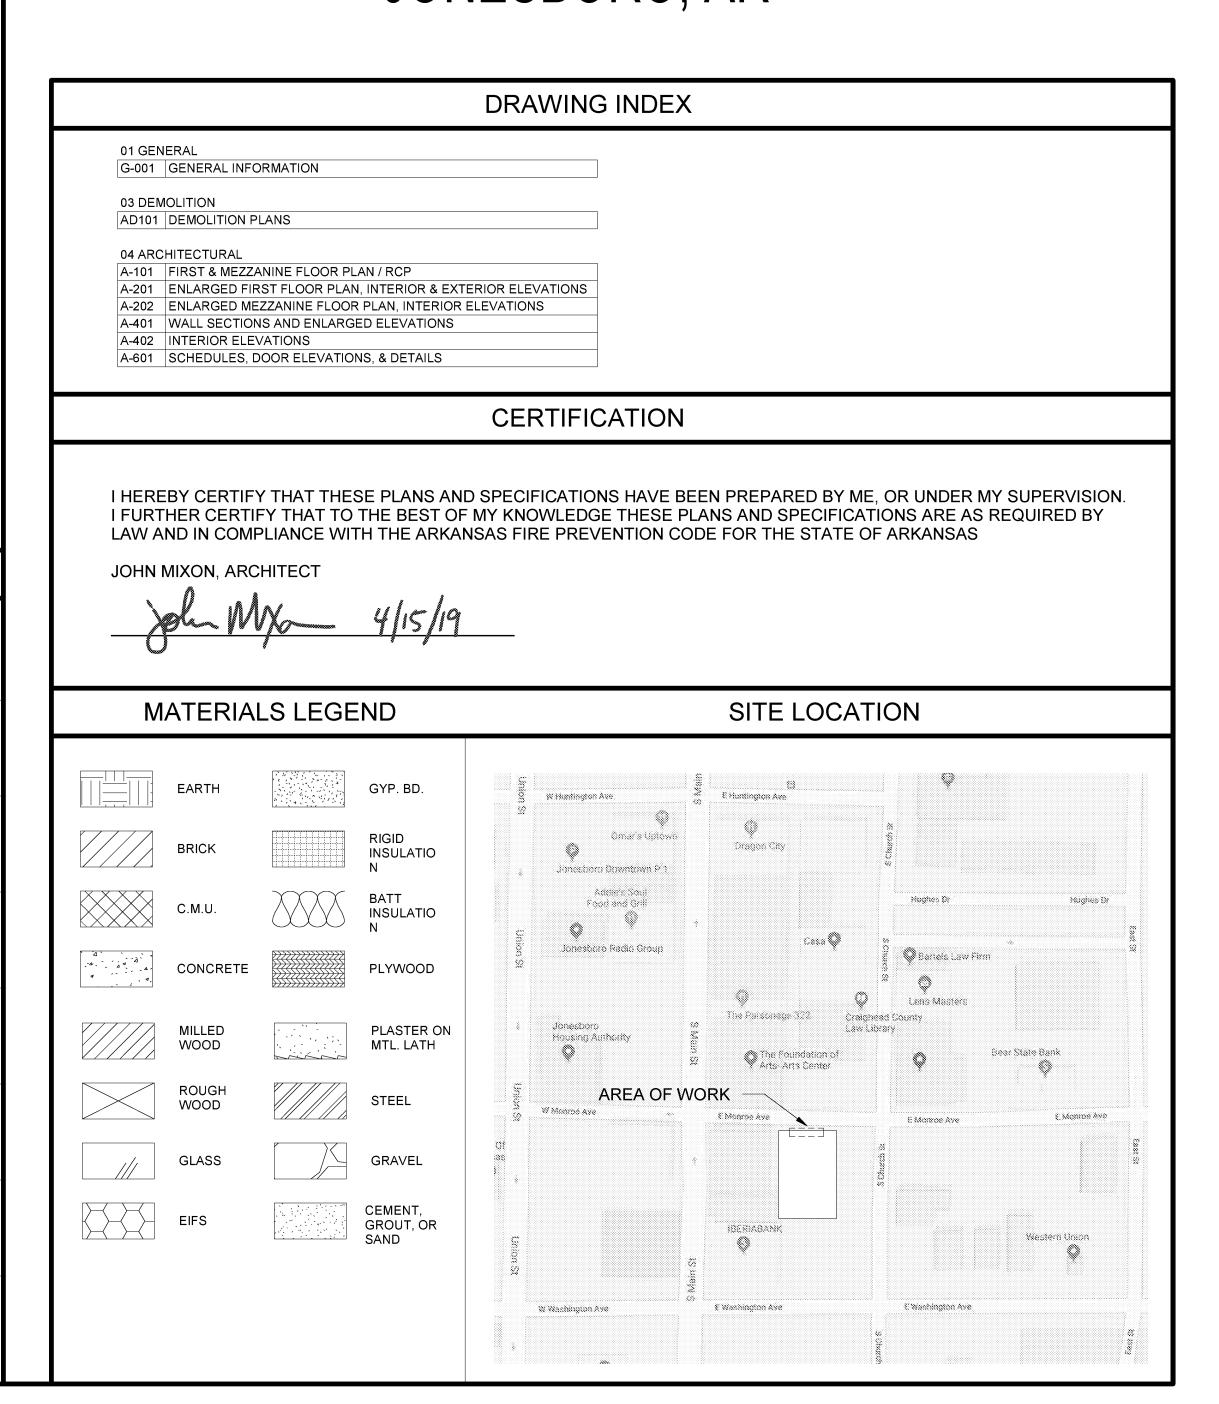

뿓

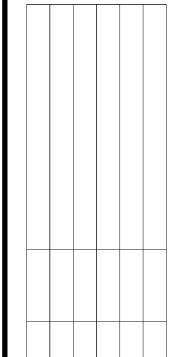



BIDDING

PROJECT NO.

PROJECT NAME THE FORUM

CONTENTS **GENERAL**

SHEET NUMBER

INFORMATION

SHEET NOTES - CLG PLAN

2. LIGHT FIXTURES ARE BASIS OF DESIGN

LEGEND - CEILING PLAN

1. ALL CEILING HEIGHT NOTATIONS TAKEN FROM FINISHED FLOOR ELEVATION OF THIS LEVEL UNLESS NOTED OTHERWISE.

GYP. BD. CEILING

EXISTING TO REMAIN

EXIT SIGN

SHEET NOTES - FLOOR PLAN

G002 FOR PARTITION TYPES.

1. ALL PARTITIONS SHALL BE TYPE 1 U.N.O. REFER TO SHEET

2. ALL DOORS SHALL BE LOCATED 4" FROM ADJACENT WALL (DOOR FRAME SHALL BE 2" FROM ADJACENT WALL) U.N.O.

3. RATED ASSEMBLIES SHALL BE ERECTED IN ENTIRETY PRIOR

4. DEVICES WHICH PENETRATE FIRE RATED WALLS MUST BE

7. REFER TO A7 SHEET SERIES FOR FINISHES AND EQUIPMENT.

9. A SURVEY OF ALL FLOOR SURFACES SHALL BE MADE PRIOR TO CONSTRUCTION TO DETERMINE OUT-OF-LEVEL CONDITIONS THAT WOULD PROHIBIT THE LEVEL PLACEMENT OF FLOORING, FILES, FURNITURE OR INTERFERE WITH THE INSTALLATION OF

UNACCEPTABLE AREAS SHALL BE REPAIRED PRIOR TO ANY

10. GENERAL CONTRACTOR AND SUBCONTRACTORS SHALL BE

SCHEDULES. ANY DISCREPANCY REASONABLY DISCOVERABLE WITH DUE DILIGENCE SHALL BE NOTED AS A QUALIFICATION TO

11. PROVIDE CONTROL JOINTS IN GYP. BD. AT 30' MAXIMUM

12. FIELD VERIFY ALL DIMENSIONS LOCATED IN EXISTING CONSTRUCTION PRIOR TO PROCEEDING WITH ANY WORK.

13. PROVIDE ACCESS PANELS WHERE PLUMBING AND HEATING

ALIGN FINISHED FACE OF NEW AND EXISTING WALLS.

PATCH AND REPAIR CEILING WHERE LIGHT FIXTURES

RAISE EXISTING SPRINKLER HEAD AND REMOUNT IN

11. REINSTALL EXISTING LIGHT FIXTURE IN NEW LOCATION.

NEW GYP BD CEILING TO BE INSTALLED AT THE

13. EXISTING SECURITY GLASS TO BE CUT TO SIZE AND

NEW LOCATION OF RELOCATED PRECAST SIGN.

VALVES, WATER SWITCHES, OXYGEN PRESSURE SWITCHES,

KEYNOTES - FLOOR PLAN

INTERIOR TRANSACTION COUNTER.

EXTERIOR TRANSACTION COUNTER.

EXISTING STOREFRONT ENTRANCE.

NO WORK IN THIS AREA.

ARE REMOVED.

REINSTALLED.

SCALE: 1/4" = 1'-0"

NEW LIGHT FIXTURE.

NEW RAISED CEILING.

HIGHEST ELEVATION POSSIBLE.

SHROUD FOR COILING DOOR.

VENTILATION SPLITTER DAMPERS, ETC. ARE SHOWN ON MEP DRAWINGS. COORDINATE FINAL LOCATION WITH ARCHITECT.

TO NON-RATED ASSEMBLIES. REFER TO LIFE SAFETY DRAWINGS FOR EXTENT OF RATED PARTITIONS.

SEALED AND DAMPERED TO RESIST FIRE & SMOKE.

5. ALL DIMENSIONS ARE TO FACE OF MATERIAL U.N.O.

8. REFER TO A8 SERIES FOR OPENINGS SCHEDULE.

ARCHITECTURAL OR MILLWORK ELEMENTS. ANY

RESPONSIBLE FOR COORDINATING THE WORK OF ALL ARCHITECTURAL DRAWINGS WITH ARCHITECTURAL

THE GENERAL CONTRACTOR'S BID SUBMISSION. ANY REASONABLY DISCOVERABLE DISCREPANCY NOT INDICATED AS A QUALIFICATION SHALL BE CONSTRUED IN FAVOR OF THE

WORK BY OTHER TRADES


OWNER AT NO COST.


INTERVALS, OR WHEN APPROPRIATE.

6. REFER TO A3 SHEET SERIES FOR REFLECTED CEILING

NICOR LSC-10-4H-UNV-35

KOMEE KMDL-15-30K-F-WH-S

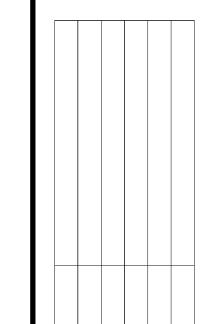

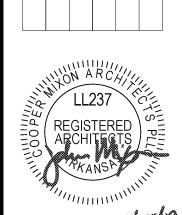

ISSUE FOR BIDDING

PROJECT NO. 1808

PROJECT NAME THE FORUM

DATE

CONTENTS FIRST & MEZZANINE

FLOOR PLAN / RCP


SHEET NUMBER






23' - 8" FIELD VERIFY 6' - 4" 9' - 0" 6' - 4" A-201 COOLER $\langle 6 \rangle$ **VESTIBULE** BOOTH VESTIBULE (3) 02 $\langle 13 \rangle$ A-201 8' - 0" 4 1/2" 7' - 7" 4 1/2" 8' - 0" 04



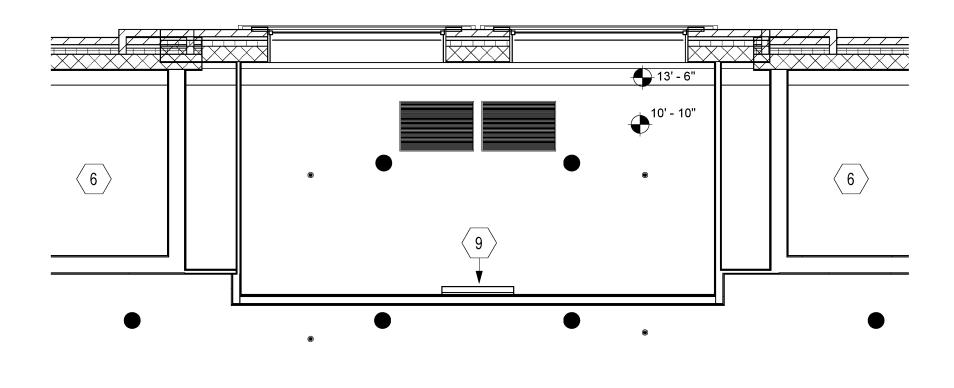




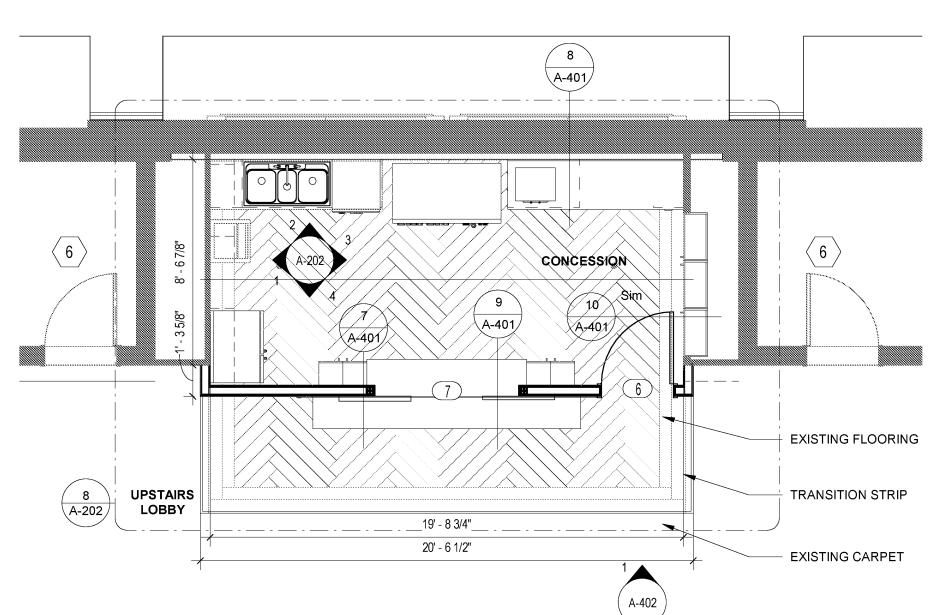


2 MEZZANINE FLOOR PLAN


1/4" = 1'-0" 2 / A-202


3 FIRST FLOOR REFLECTED CEILING PLAN
1/4" = 1'-0" 6 / A-201

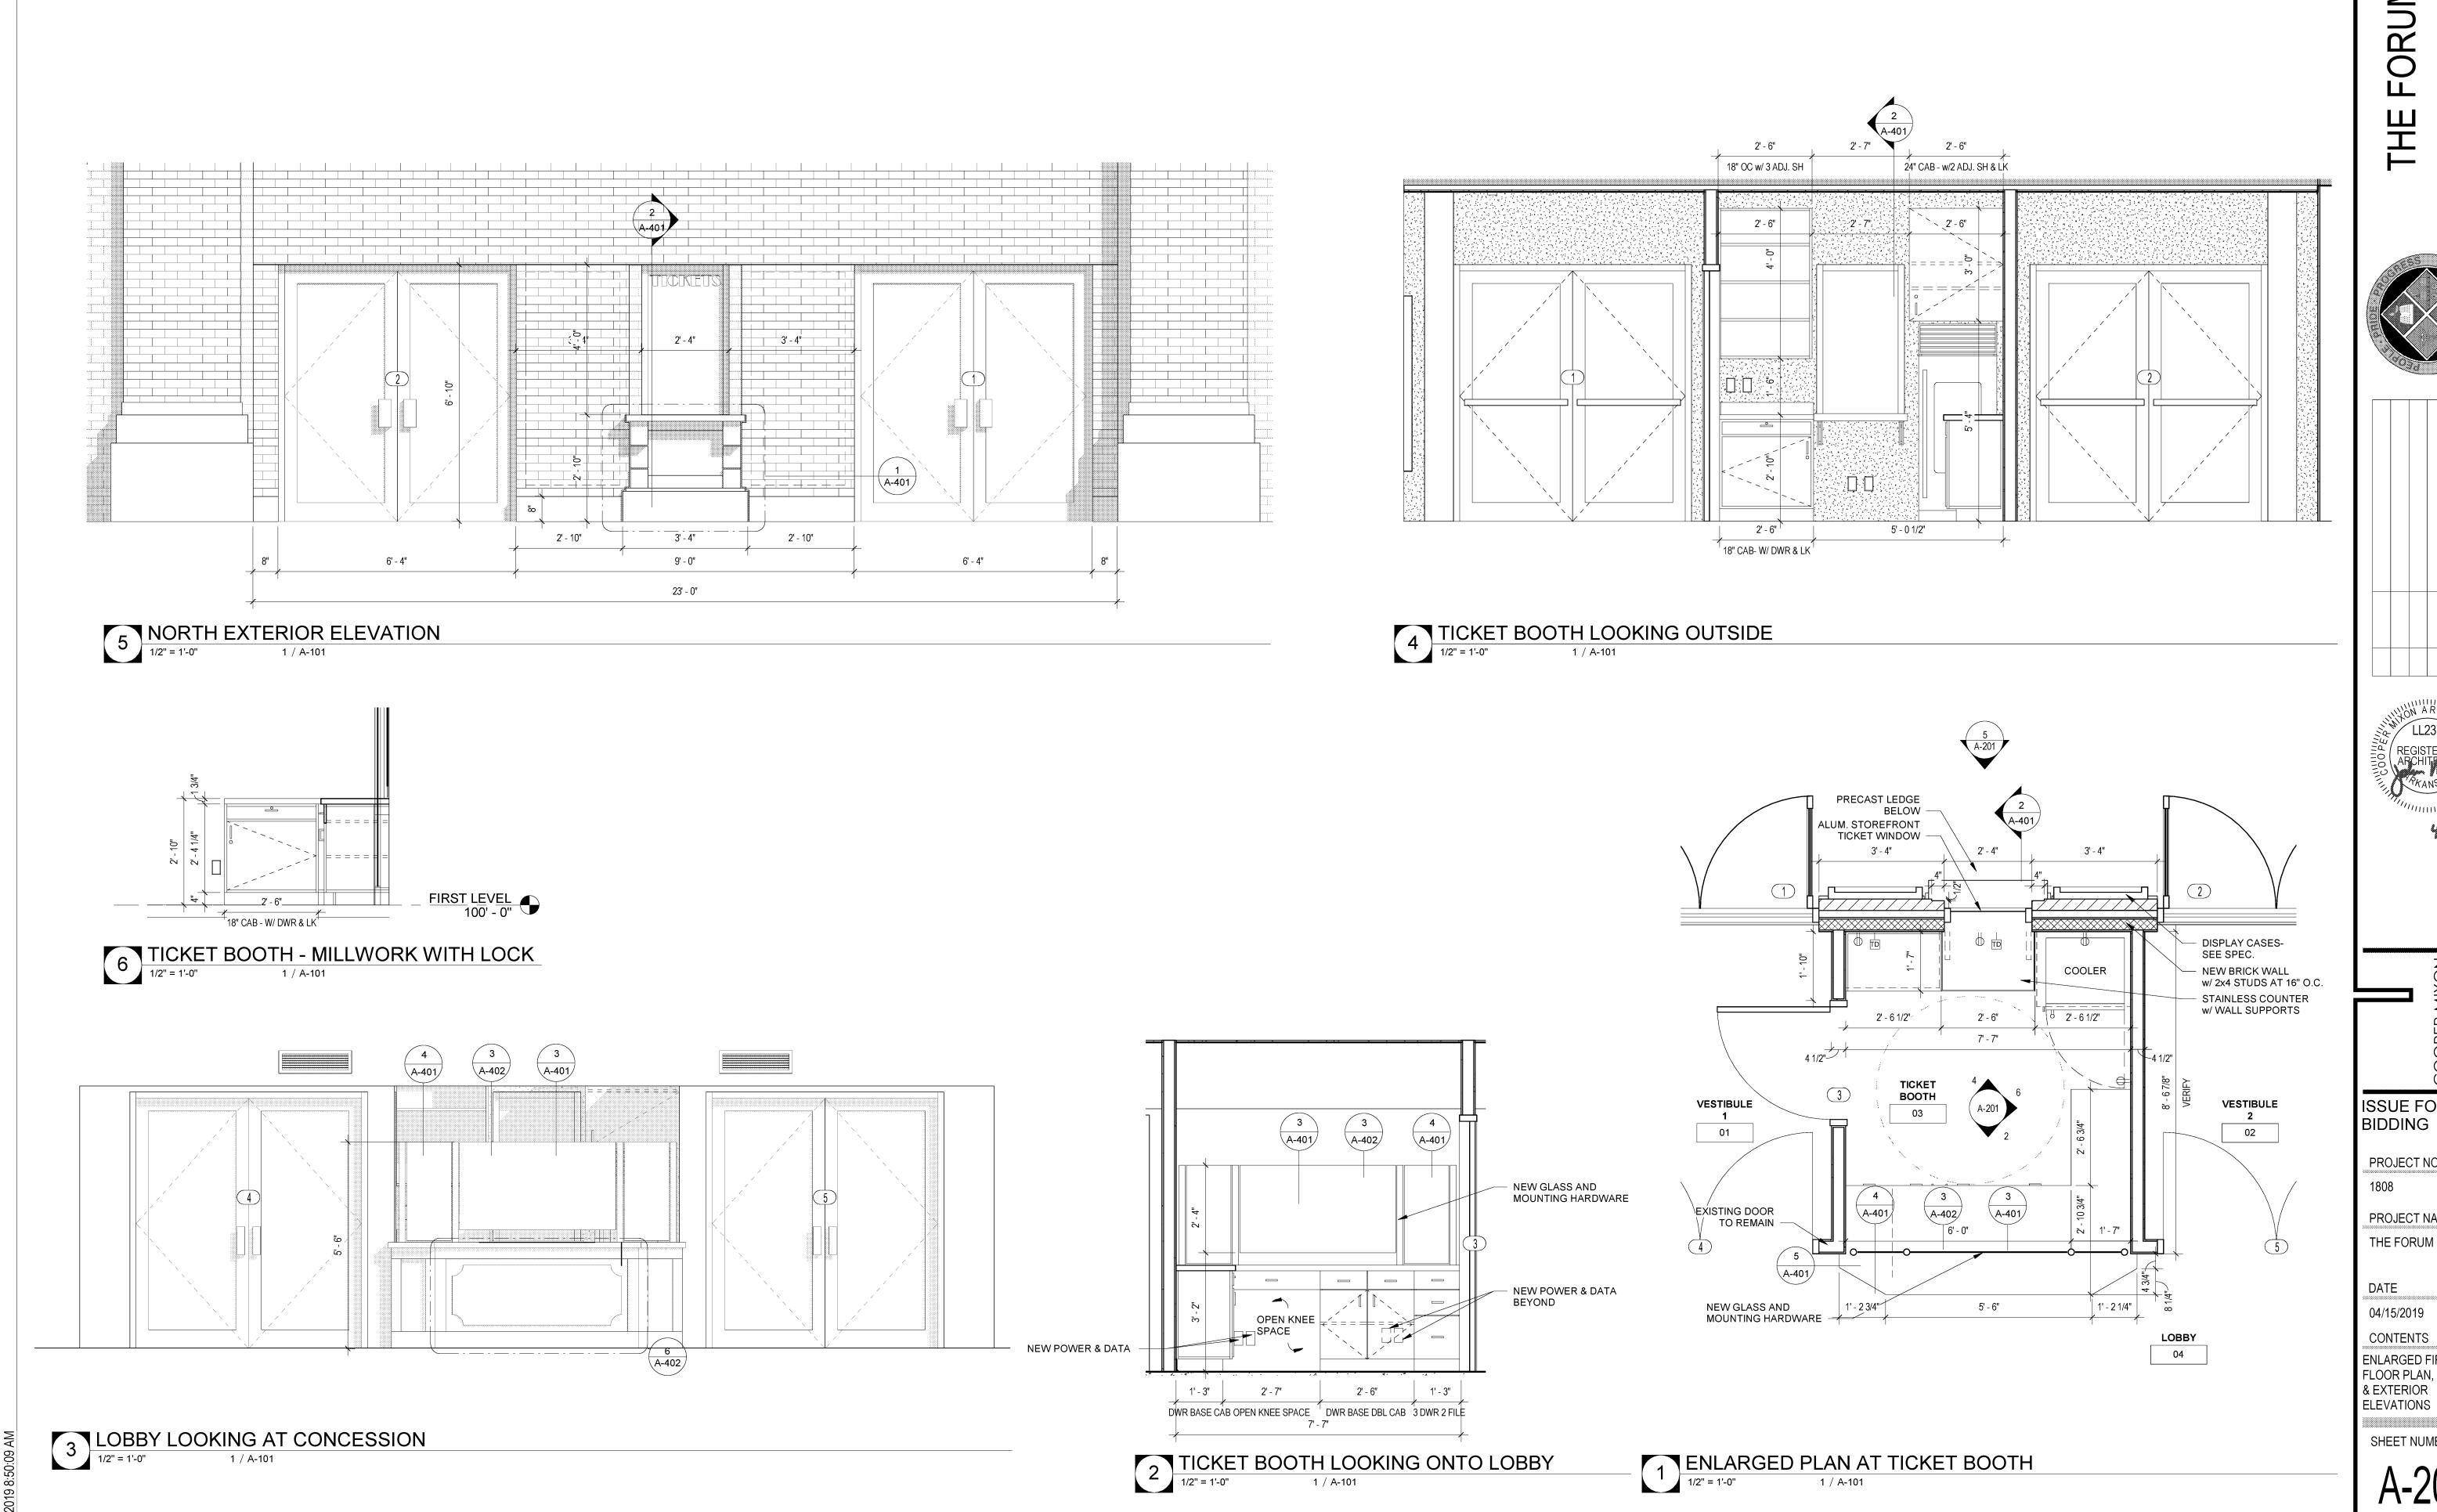

FORUM 里

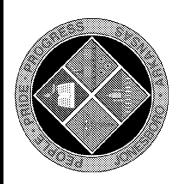

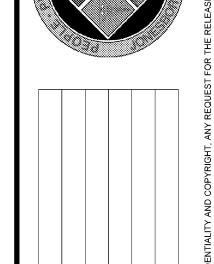

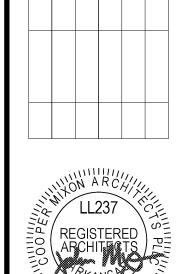



ISSUE FOR BIDDING


PROJECT NO.

PROJECT NAME THE FORUM

04/15/2019

CONTENTS ENLARGED FIRST FLOOR PLAN, INTERIOR & EXTERIOR

SHEET NUMBER

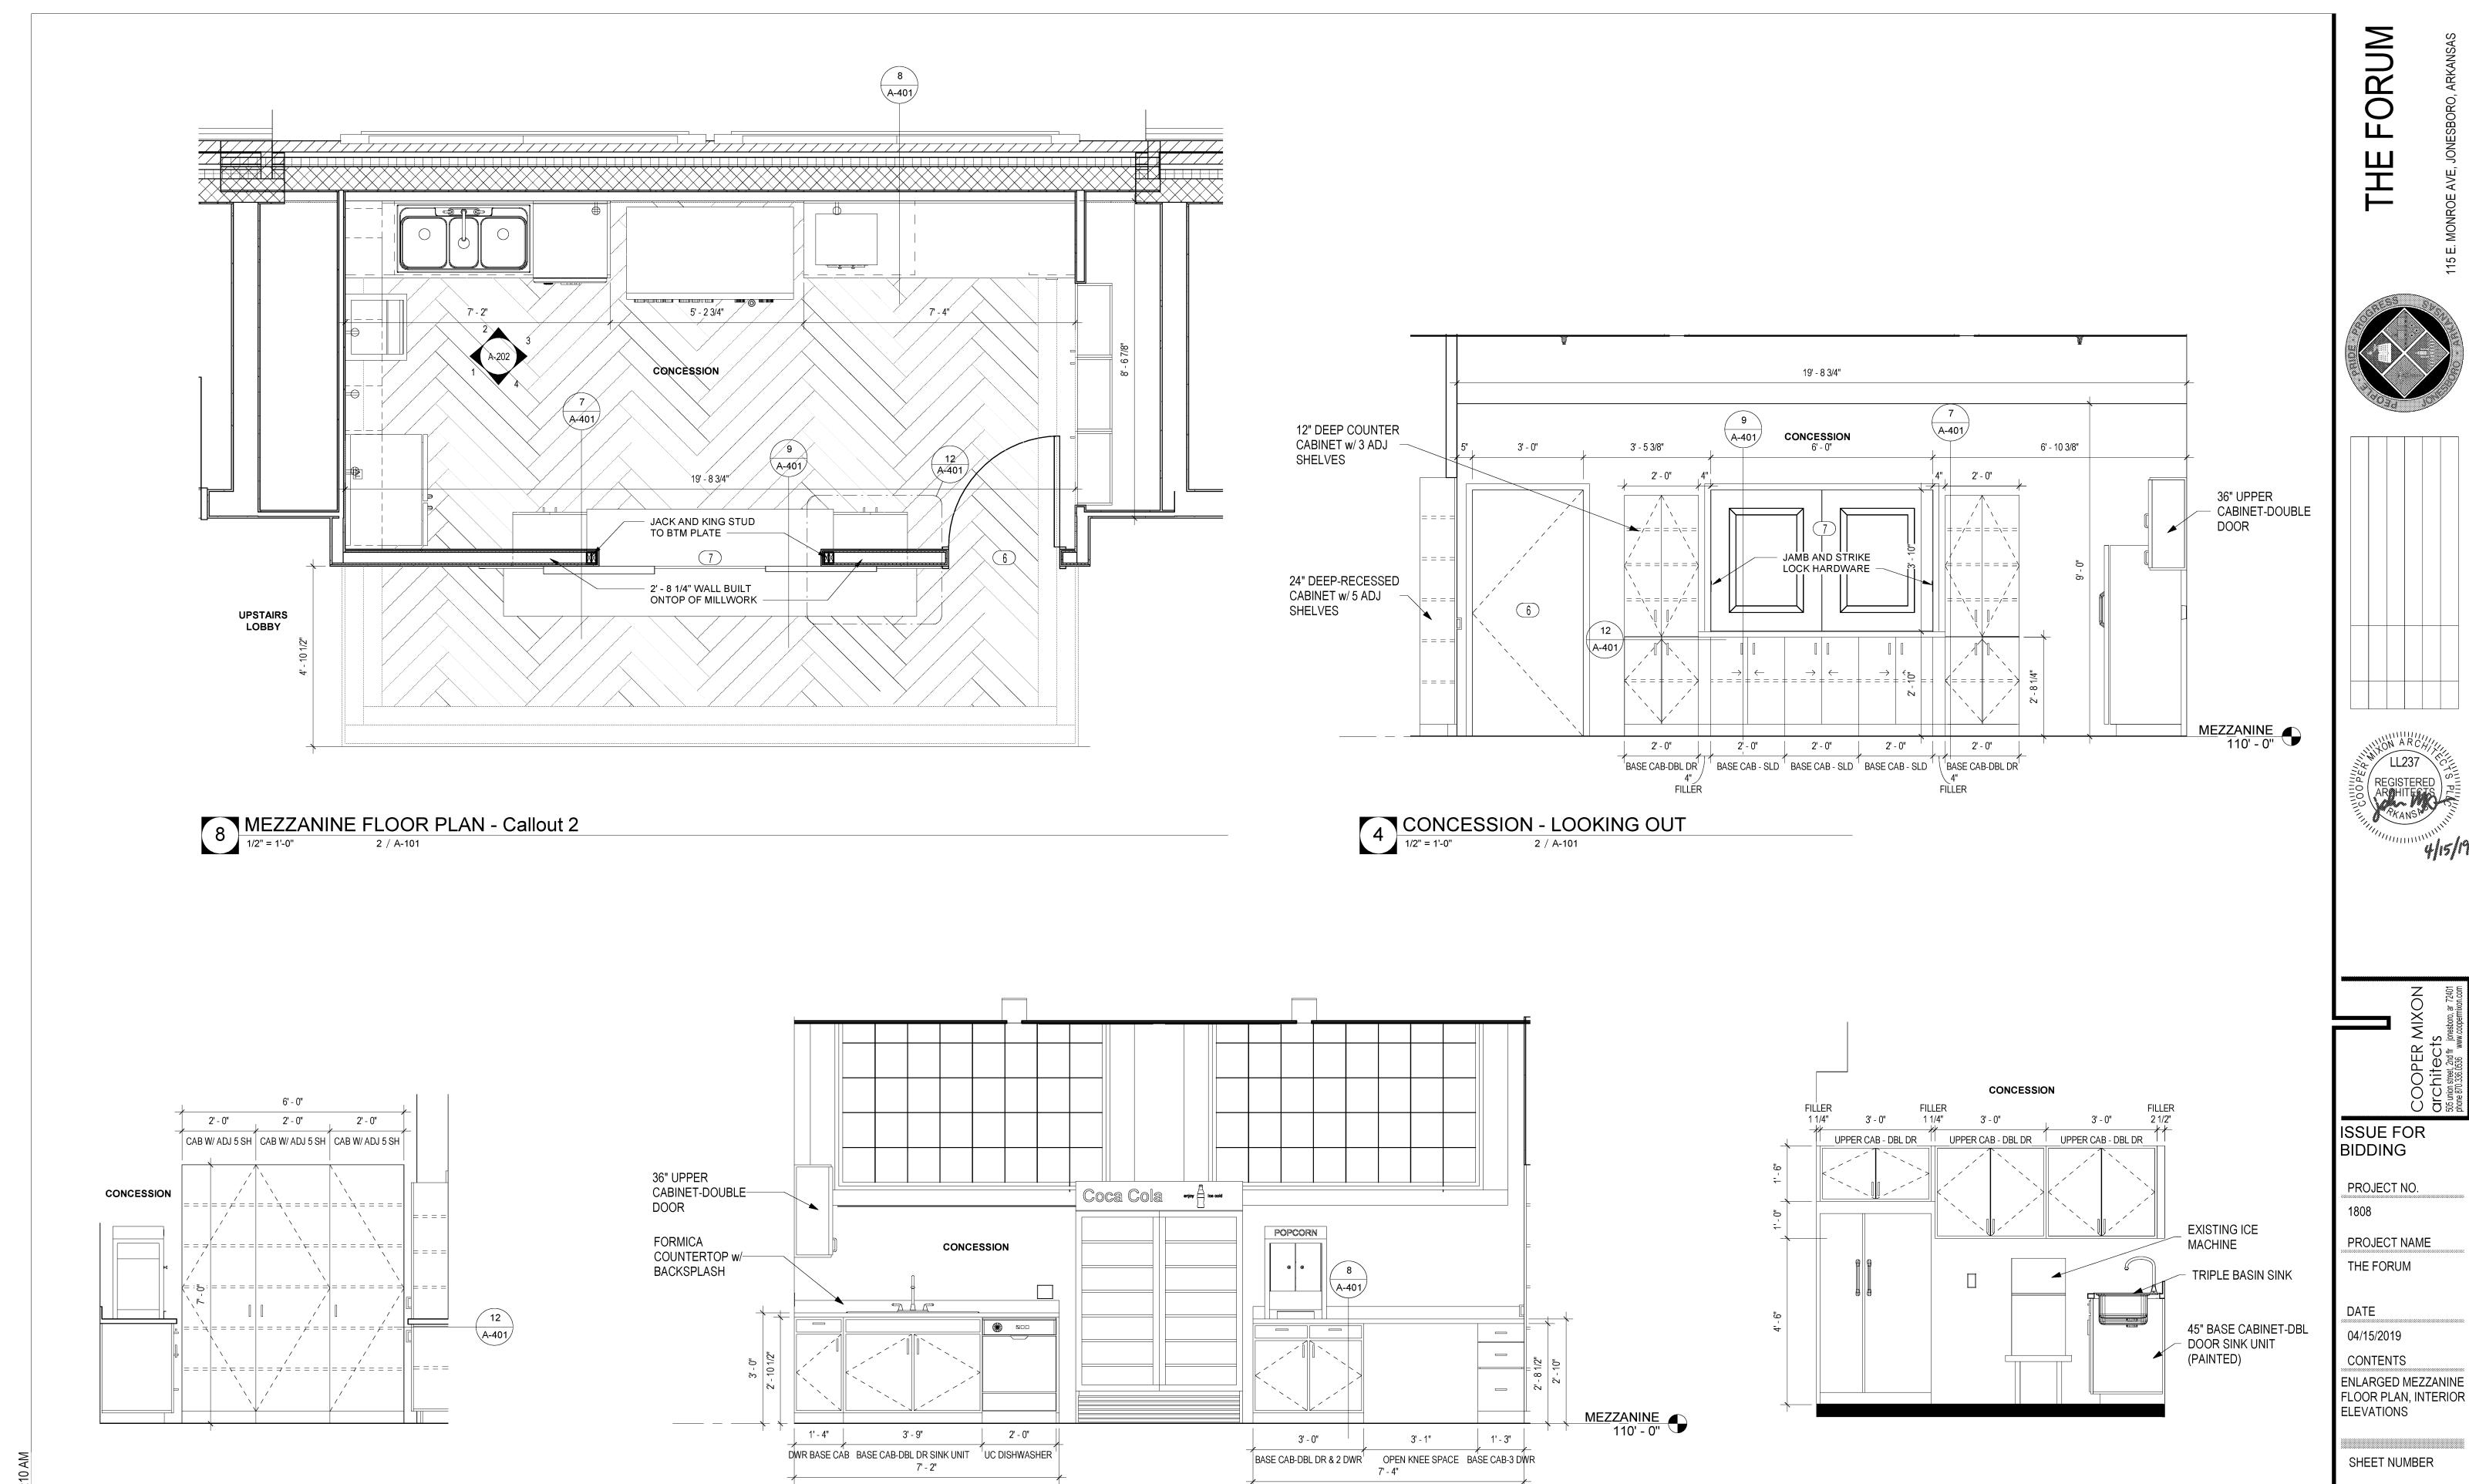



2 CONCESSION - BACK OF WALL

1/2" = 1'-0" 2 / A-101

3 CONCESSION - RIGHT VIEW
1/2" = 1'-0" 2 / A-101

1 CONCESSION - LEFT VIEW
1/2" = 1'-0" 2 / A-101

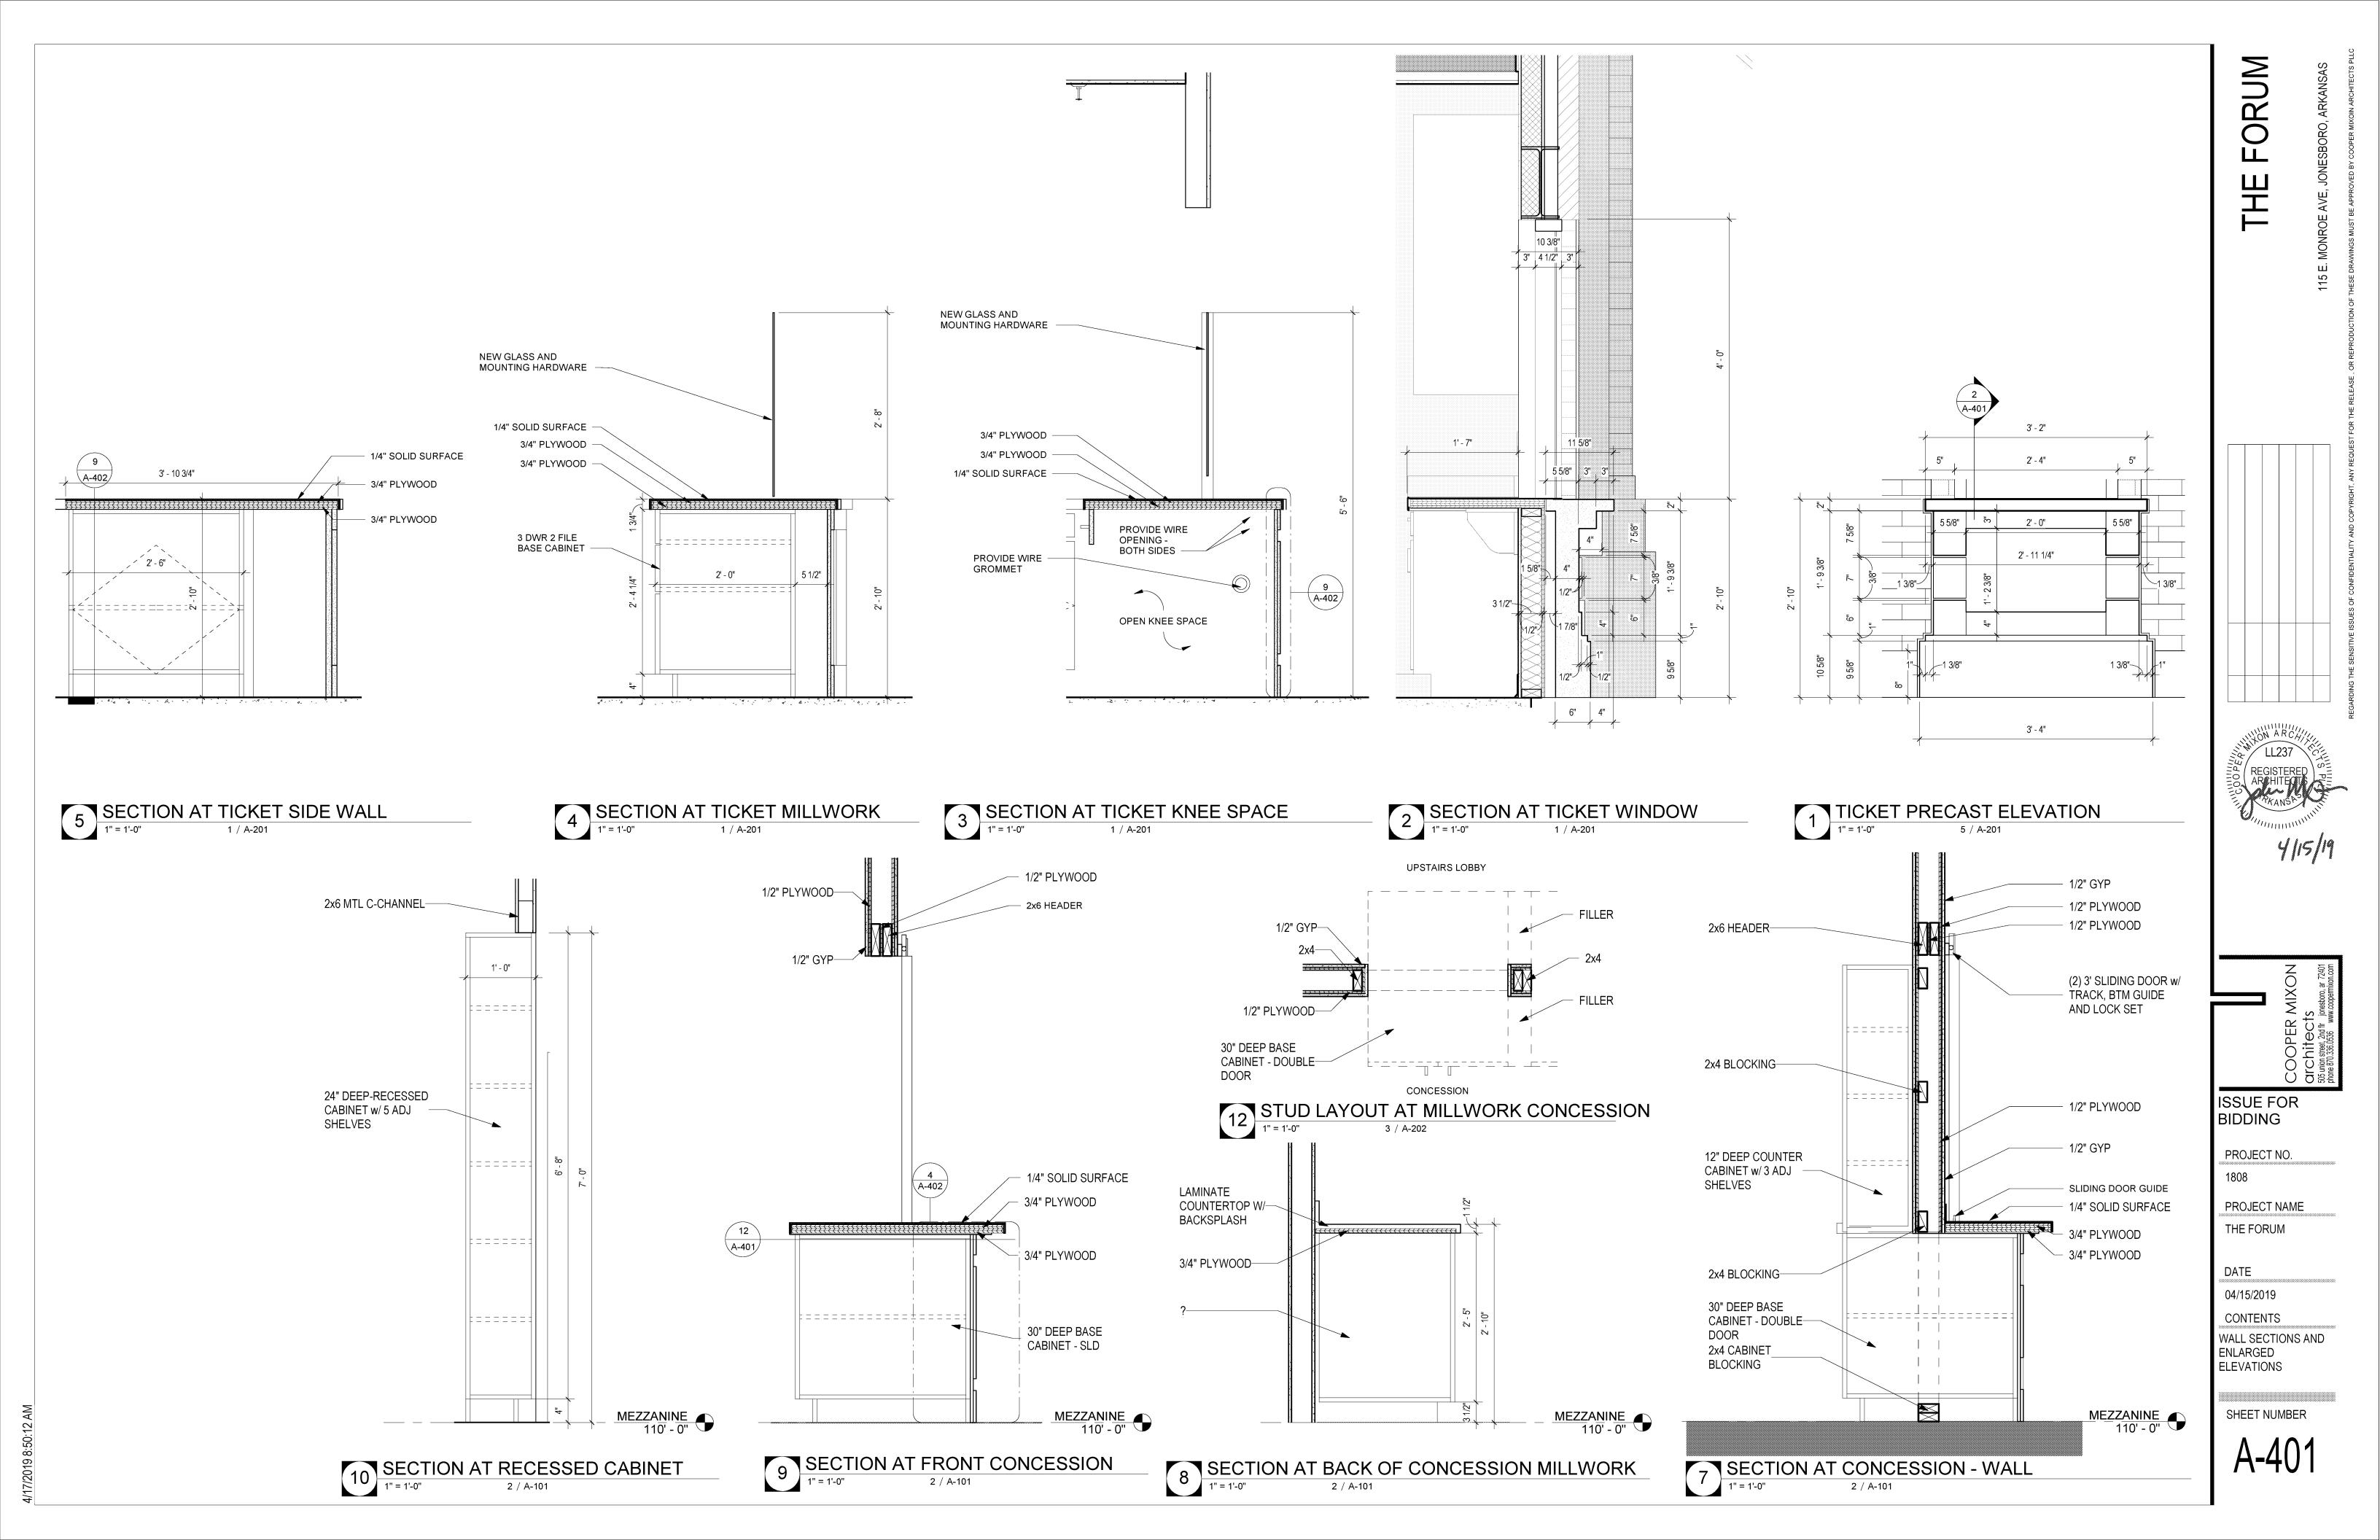

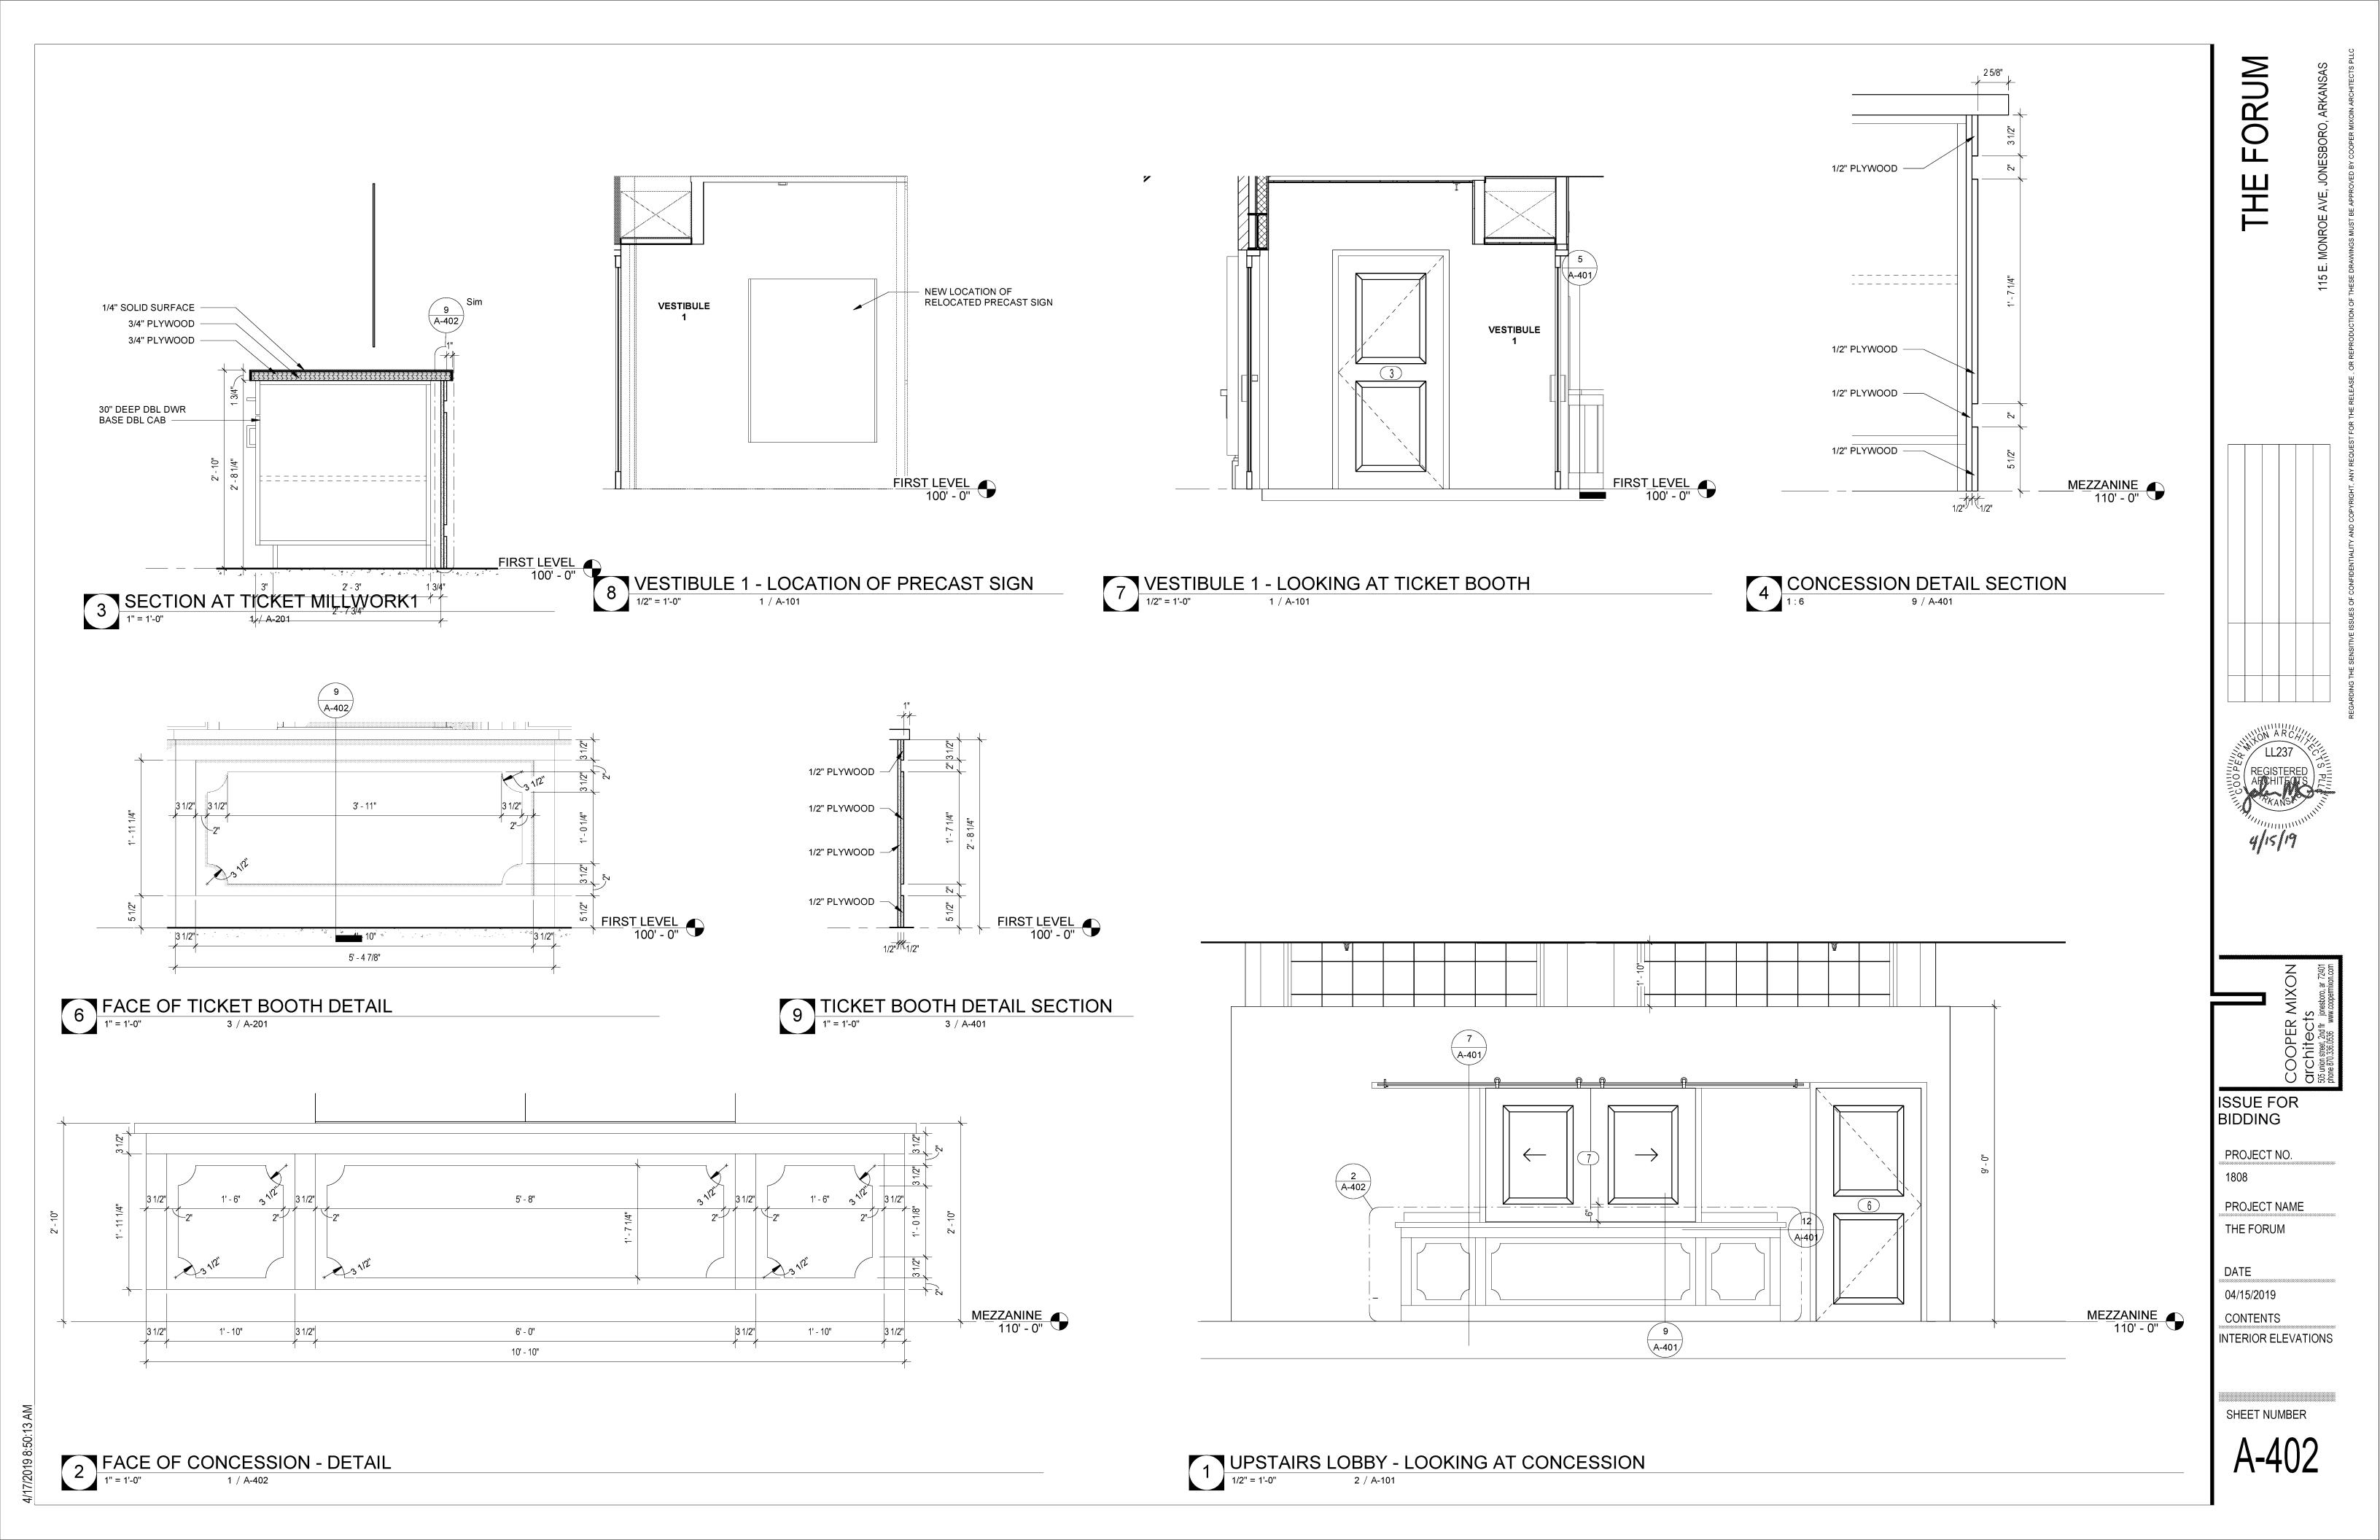

BIDDING

PROJECT NO.

PROJECT NAME

THE FORUM

CONTENTS


ELEVATIONS, &


SCHEDULES, DOOR


SHEET NUMBER

DATE

DETAILS

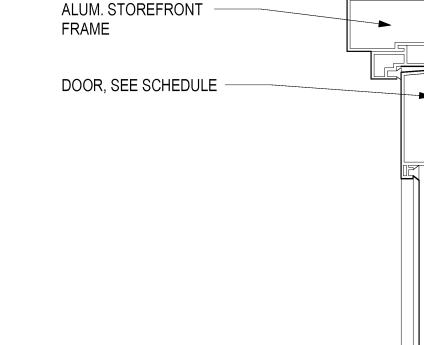

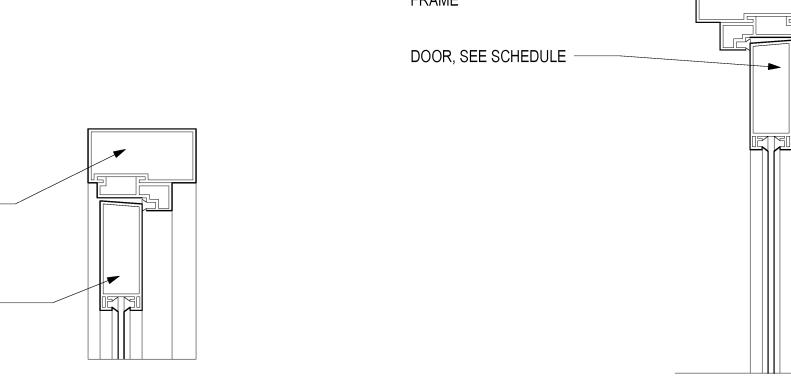

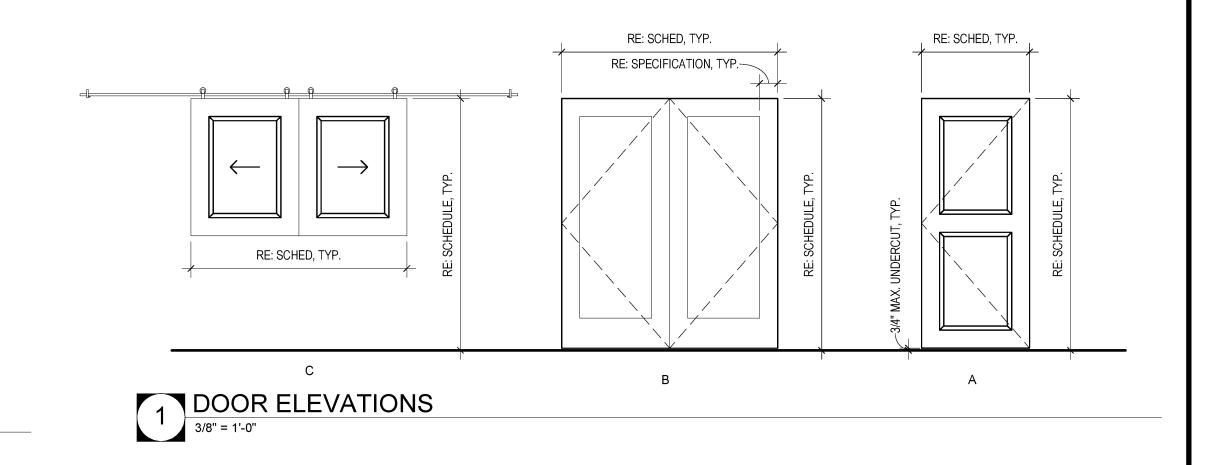

THRESHOLD, ALUMINUM EXT.

3" = 1'-0"

THRESHOLD SEE DOOR HARDWARE SPEC'S

NON TRACKING JOINT SEALANT

SLOPE CONC. @ 1/4"/FT.

JOINT FILLER

4 HEAD, INT. STOREFRONT
/

ALUM. STOREFRONT FRAME

DOOR, SEE SCHEDULE


JAMB, INT. STOREFRONT
/

1/2" PLYWOOD 3/4" WOOD TRIM DOOR - SEE SCHEDULE

7 TYP. DOOR HEAD

3" = 1'-0" /

DOOR - SEE SCHEDULE 1/2" PLYWOOD 3/4" WOOD TRIM

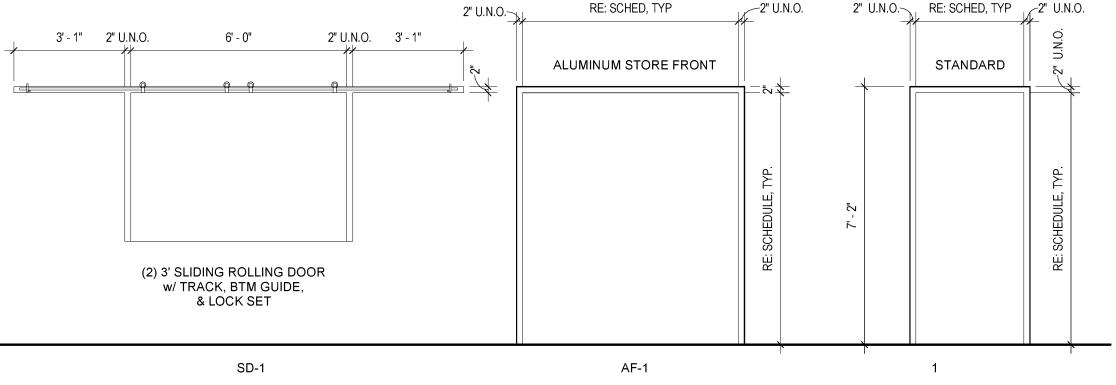

6 TYP. DOOR JAMB
3" = 1'-0" /

2 DOOR FRAME ELEVATIONS
3/8" = 1'-0"

SHEET NOTES - DOORS

1. ALL HARDWARE SHALL CONFORM TO APPLICABLE PROVISIONS OF ICC A117.1, ACCESSIBLE AND USABLE BUILDINGS AND FACILITIES.

DOOR SCHEDULE REMARKS

A. PROVIDE MAGNETIC HOLD OPENS TIED TO FIRE ALARM

B. PROVIDE ELECTRIC LOCKSET FOR CONTROLLED ACCESS.

2. KEYING CRITERIA WILL BE ESTABLISHED BY THE OWNER AFTER BID. ALLOW FOR INDIVIDUAL LOCK KEYING AND MULTIPLE MASTERS AND SUBMASTERS. THE HARDWARE CONTRACTOR SHALL PREPARE A SEPARATE KEYING SCHEDULE BASED UPON THE OWNERS CRITERIA.

3. PROVIDE NON REMOVABLE PINS AT ALL DOOR HINGES WHERE THE HINGE IS EXPOSED TO THE LOCK SIDE OF THE

4. DOORS SHALL NOT BE LOCKABLE IN THE DIRECTION OF

5. PROVIDE UL LISTED HARDWARE AT ALL FIRE RATED

6. IN GENERAL DOOR CLOSERS SHALL BE LOCATED ON THE ROOM SIDE OF THE DOOR. PROVIDE REGULAR OR PARALLEL ARMS AS NECESSARY.

7. PROVIDE HOLLOW METAL ASTRAGALS AT DOOR PAIRS WHERE REQUIRED TO ACHIEVE SPECIFIED UL LABEL.

8. THE CONTRACTOR SHALL COORDINATE THE VARIOUS HARDWARE COMPONENTS FOR EACH DOOR AND MAKE NECESSARY MODIFICATIONS TO PROVIDE FOR A FULLY FUNCTIONING DOOR OPERATION.

9. PROVIDE SEALANT AT JUNCTION OF ALL FRAMES AND

10. WIDTH OF HOLLOW METAL FRAMES ARE ACTUAL PARTITION THICKNESS PLUS 1 INCH, EXCEPT FOR CMU PARTITIONS. PARTITION TYPES ARE KEYED ON FLOOR

11. PROVIDE SPECIFIED FRAME ANCHORS LISTED IN THE SPECIFICATIONS TO ACCOMMODATE PARTITION TYPES AND REQUIREMENTS FOR FIRE RATINGS.

12. AT GYPSUM BOARD PARTITIONS PROVIDE DOUBLE METAL STUDS AT ALL DOOR OR BORROWED LITE JAMBS.

13. PAINT ALL HOLLOW METAL DOORS UNLESS NOTED OTHERWISE.

14. MAXIMUM DOOR OPERATING PRESSURES ARE 5 LBS. FOR INTERIOR DOORS AND 8 LBS. FOR EXTERIOR DOORS.


15. ALL RATED DOORS SHALL BE SELF CLOSING.

16. PROVIDE THRESHOLD AND WEATHERSTRIPPING AT ALL EXTERIOR DOORS, WHETHER SCHEDULED OR NOT.

						D	OOR SCHED	JLE					
DOOR					FRAME			FRAME DETAIL					
	OPENII	NG SIZE	DOOR	DOOR		FRAME	FRAME		HEAD	JAMB	FIRE		
DOOR NO.	WIDTH	HEIGHT	TYPE	MATERIAL	DOOR FINISH	TYPE	MATERIAL	FRAME FINISH	DETAIL	DETAIL	HDW SET	RATING	REMARKS
1	6' - 0"	6' - 8"	В	ALUM / GLS	CLR ANODIZED	AF-1	ALUM	CLR ANODIZED					
2	6' - 0"	6' - 8"	В	ALUM / GLS	CLR ANODIZED	AF-1	ALUM	CLR ANODIZED					
3	3' - 0"	6' - 8"	Α	SCWD	PAINT	1	HM	PAINT					
4	6' - 0"	6' - 8"	В	ALUM / GLS	CLR ANODIZED	AF-1	ALUM	CLR ANODIZED					
5	6' - 0"	6' - 8"	В	ALUM / GLS	CLR ANODIZED	AF-1	ALUM	CLR ANODIZED					
6	3' - 0"	6' - 8"	Α	SCWD	PAINT	1	WD	PAINT					
7	6' - 0"	6' - 0"	С	SCWD	PAINT	SD-1	WD	PAINT					

				F	₹OOM FINIS	SH SCHEDULE	Ē		
					WA	ALLS			
ROOM NO.	ROOM NAME	FLOOR	BASE	NORTH	EAST	SOUTH	WEST	CEILING	COMMENTS
				·					
01	VESTIBULE 1	EXIST TILE	RB-1	P-1	P-1	P-1	P-1	P-3	PAINT EXIST & NEW
02	VESTIBULE 2	EXIST TILE	RB-1	P-1	P-1	P-1	P-1	P-3	PAINT EXIST & NEW
03	TICKET BOOTH	LVT	RB-1	P-2	P-2	P-2	P-2	P-3	
04	LOBBY	EXIST CPT	RB-1		1				
05	CONCESSION	LVT	RB-1	P-2	P-2	P-2	P-2		CEILING - TOUCH UP PAINT AS REQ.
06	UPSTAIRS LOBBY	EXIST CPT	RB-1	P-2	1				PAINT NEW WALL

			ROOM FINISH	LEGEND		
FINISH CODE	MANUFACTURER	MODEL / TILE	COLOR NAME / NUMBER	PATTERN	DESCRIPTION	LOCATION / NOTES
BASE						
RB-1	MANUFACTURER	MODEL / TILE	COLOR NAME / NUMBER	PATTERN	DESCRIPTION	LOCATION / NOTES
FLOOR		,				<u> </u>
LVT-1	MANUFACTURER	MODEL / TILE	COLOR NAME / NUMBER	PATTERN	DESCRIPTION	LOCATION / NOTES
WALLS						<u> </u>
P-1	MANUFACTURER	MODEL / TILE	COLOR NAME / NUMBER	PATTERN	DESCRIPTION	LOCATION / NOTES
P-2	MANUFACTURER	MODEL / TILE	COLOR NAME / NUMBER	PATTERN	DESCRIPTION	LOCATION / NOTES
P-3	MANUFACTURER	MODEL / TILE	COLOR NAME / NUMBER	PATTERN	DESCRIPTION	LOCATION / NOTES

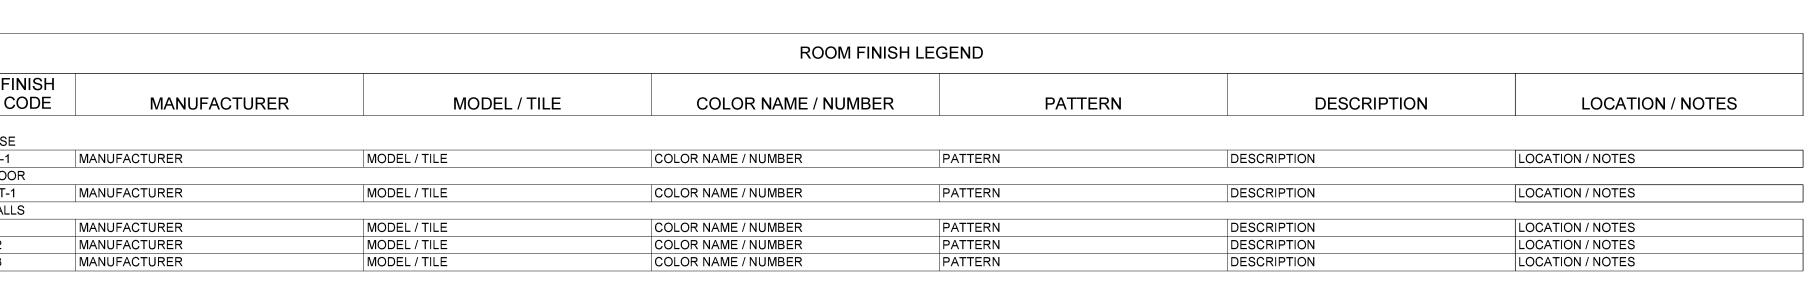

SHEET NOTES - DEMOLITION 1. THE TOTAL AMOUNT OF DEMOLITION REQUIRED FOR THE PROJECT IS NOT INDICATED ON THE DEMOLITION PLANS. THEY ARE INCLUDED FOR THE CONVENIENCE OF THE CONTRACTOR. THEY INDICATE THE GENERAL EXTENT OF THE REMOVAL WORK REQUIRED. IT IS THE CONTRACTOR'S RESPONSIBILITY TO FULLY INSPECT THE BUILDING AND VERIFY ALL CONDITIONS AND FULL EXTENT OF DEMOLITION 2. THE SUBCONTRACTORS FOR PLUMBING, ELECTRICAL,

INCLUDED FOR THE CONVENIENCE OF THE CONTRACTOR. 3. MAINTAIN BUILDING IN STRUCTURALLY SOUND CONDITION AT ALL TIMES. DO NOT REMOVE ANY PORTION OF THE BUILDING STRUCTURE INCLUDING COLUMNS, LOAD BEARING WALLS, BEAMS FLOOR CONSTRUCTION, PERIMETER WALLS OR FIREPROOFING OF STRUCTURAL ELEMENTS UNLESS SPECIFICALLY NOTED.

HVAC AND FIRE PROTECTION ARE RESPONSIBLE FOR ESTABLISHING THE SCOPE OF DEMOLITION REQUIRED TO PERFORM THE WORK FOR THEIR RESPECTIVE TRADE. DEMOLITION DRAWINGS FOR THESE DISCIPLINES ARE

PRIOR TO SUBMITTING BID.

4. PROTECT ALL FINISHES AND COMPONENTS OF BUILDING WHICH ARE TO REMAIN. ANY DAMAGED MATERIAL, EQUIPMENT OR ITEMS TO REMAIN SHALL BE REPAIRED OR REPLACED TO MATCH EXISTING CONSTRUCTION, AND ARE THE RESPONSIBILITY OF THE CONTRACTOR.

5. VERIFY CONCEALED CONSTRUCTION CONDITIONS PRIOR TO REMOVAL OF ANY ITEMS. CAREFULLY ASSESS EACH ITEM TO BE REMOVED FOR DETRIMENTAL RESULTS IF REMOVED. PERFORM EXPLORATORY DEMOLITION TO DETERMINE METHODS OF ATTACHMENTS, UTILITY INTERFACES, INTERCONNECTIONS AND OTHER CONCEALED CONDITIONS PRIOR TO DEMOLITION.


6. ITEMS DESIGNATED TO BE REMOVED AND SALVAGED SHALL BE DELIVERED TO A SAFE REMOTE LOCATION FOR RETROFITTING OR A SAFE LOCATION ON SITE FOR CLEANING AND STORAGE BY THE CONTRACTOR.

7. MAINTAIN CODE COMPLIANT AND UNOBSTRUCTED EXIT PATHS AT ALL TIMES.

8. PRIOR TO DEMOLITION WORK, THE CONTRACTOR SHALL ASSESS AND IDENTIFY UTILITIES WITHIN THE DEMOLITION AREA THAT SERVE OCCUPIED SPACES OUTSIDE OF THE AREA OF THAT PHASE OF WORK. THOSE UTILITIES SHALL BE PROTECTED AND RESUPPORTED WHERE NECESSARY TO MAINTAIN CONTINUITY OF SERVICE.


9. AREAS SURROUNDING THE AREA OF THIS CONTRACT SHALL REMAIN FULLY OCCUPIED DURING THE WORK. CAREFULLY SCHEDULE AND COORDINATE THIS WORK WITH THE OWNER TO MINIMIZE DISRUPTION TO ANY ACTIVITIES. SOME OF THE WORK MAY NEED TO BE PERFORMED OFF HOURS.

10. WHERE PARTIAL DEMOLITION IS NOT INDICATED BUT IS NECESSARY TO PERFORM NEW WORK, THAT AREA SHALL BE REMOVED AS NECESSARY AND REFINISHED/REPLACED TO MATCH THE EXISTING CONTIGUOUS CONSTRUCTION

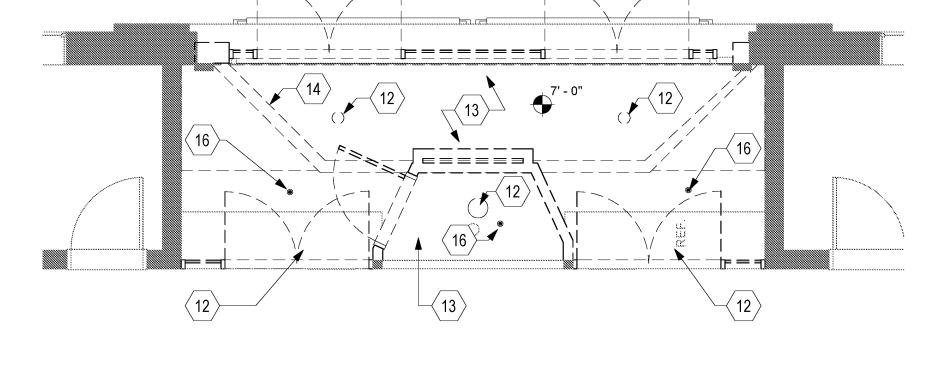






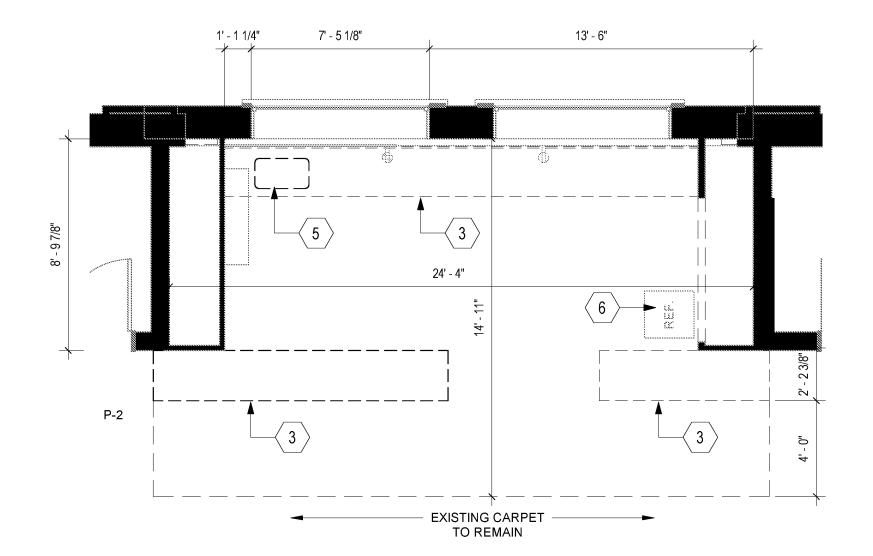




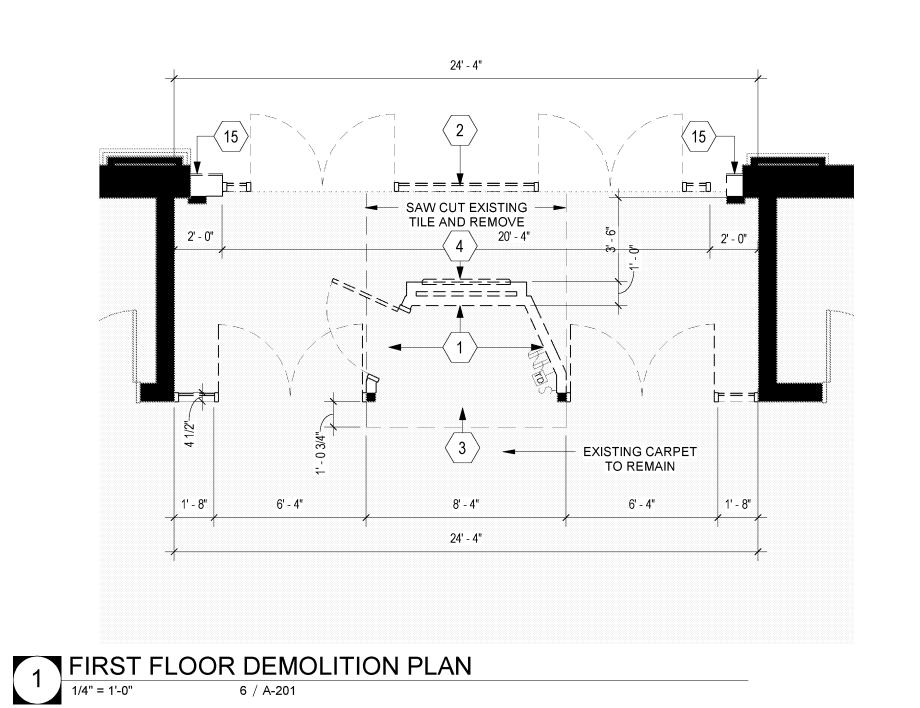

KEYNOTES - DEMOLITION

- REMOVE EXISTING WALL AND ALL ASSOCIATED FRAMES, DOORS, WIRING, ETC.
- REMOVE EXISTING STOREFRONT AND ALL ASSOCIATED DOORS AND HARDWARE.
- REMOVE EXISTING MILLWORK AND COUNTERTOPS CAREFULLY.
- REMOVE EXISTING PRECAST SIGN AND STORE FOR INSTALLATION IN NEW LOCATION.
- REMOVE EXISTING SINK AND STORE FOR REINSTALLATION, ALL PLUMBING TO BE TEMPORARY CAPPED AND RECONNECTED.
- OWNER TO REMOVE REFRIGERATOR FOR OWNER'S REINSTALLATION.
- LIGHT FIXTURES TO REMAIN. DO NOT PAINT.
- SPRINKLER HEAD TO REMAIN. DO NOT PAINT.
- RETURN AIR REGISTER TO REMAIN. DO NOT PAINT.
- 10. REMOVE AND REUSE LIGHT FIXTURE.
- 11. EXISTING CEILING TRANSITIONS FROM FLAT TO SLOPING.
- DEMOLISH LIGHT FIXTURE.
- DEMOLISH EXISTING GYP BD CEILING AND ASSOCIATED FRAMING.
- DEMOLISH EXISTING FURR DOWN AND ASSOCIATED FRAMING.
- DEMOLISH FACE BRICK.
- PROTECT SPRINKLER HEAD DURING DEMOLITION OF

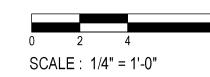





ISSUE FOR

PROJECT NO.

PROJECT NAME

THE FORUM

CONTENTS

DEMOLITION PLANS

SHEET NUMBER

BIDDING

1808

DATE