

VETERANS' VILLAGE COMMUNITY BLDG
CITY OF JONESBORO

FLOOR MATERIAL TAKEOFF

REGISTERED ARCHITEOTS

202,1,-0,1,-0,3

COOPER MIXON
A R C H I T E C T S

505 union street, 2nd flr jonesboro, ar 72401
phone 870.336.0536 www.coopermixon.com

CONSTRUCTION DOCUMENTS

PROJECT NO. 2029

PROJECT NAME
VETERANS' VILLAGE
COMMUNITY BLDG

DATE

2021-01-03 CONTENTS

FOUNDATION PLAN

SHEET NUMBER


SCALE: 1/4" = 1'-0"

A0.1

	DOOR SCHEDULE							
#	TYPE	WIDTH	HEIGHT	DOOR MATERIAL	DOOR FINISH	FRAME MATERIAL	FRAME FINISH	
100	Α	3' - 0"	6' - 8"	ALUM CLAD	FACTORY PAINT	ALUM CLAD	FACTORY PAINT	
101	Α	3' - 0"	6' - 8"	ALUM CLAD	FACTORY PAINT	ALUM CLAD	FACTORY PAINT	
101A	В	3' - 0"	6' - 8"	SCWD	FACTORY PAINT	WD	PAINT	
101B	В	3' - 0"	6' - 8"	SCWD	FACTORY PAINT	WD	PAINT	
101C	С	3' - 0"	6' - 8"	SCWD	FACTORY PAINT	WD	PAINT	
102	Α	3' - 0"	6' - 8"	ALUM CLAD	FACTORY PAINT	ALUM CLAD	FACTORY PAINT	
102A	С	3' - 0"	6' - 8"	SCWD	FACTORY PAINT	WD	PAINT	
102B	В	3' - 0"	6' - 8"	SCWD	FACTORY PAINT	WD	PAINT	
103	В	3' - 0"	6' - 8"	SCWD	FACTORY PAINT	WD	PAINT	
104	В	3' - 0"	6' - 8"	SCWD	FACTORY PAINT	WD	PAINT	
105	В	3' - 0"	6' - 8"	SCWD	FACTORY PAINT	WD	PAINT	

FIN	ISH LEGEND
FLOORS	3
LVT-1	LUXURY VINYL TILE: BOD = MOHAWK - URBAN NATIVE WOOD
PT-1	PORCELAIN TILE: BOD = DAL TILE - URBANIZED PORCELAIN 12X24
CONC	SEALED CONCRETE
BASE	
RB-1	4 INCH RESILIENT BASE
PTB-1	PORCELAIN TILE BASE TO MATCH FLOOR
WALLS	
P-1	PAINT: COLOR 1
P-2	PAINT: COLOR 2
PT-2	PORCELAIN TILE (COLOR 2): BOD = DAL TILE - URBANIZED PORCELAIN 12X24
MISC	
CG-1	CORNER GUARDS: WOOD, PAINTED
WP-1	WALL PROTECTION: 48" WOOD WAINSCOT, PAINTED

				ROOM	I FINISH	SCHEDU	LE			
				WALLS						
ROOM NO.	ROOM NAME	FLOOR	BASE	NORT H	EAST	SOUTH	WEST	CEILING	CLG. HT.	COMMENTS
100	ENTRY	LVT-1	RB-1	P-1	P-2	P-1	P-1	P-3	10' - 0"	P-2 ON KITCHENETTE WALL, WP-1, CG-1
101	COMMUNITY LIVING ROOM	LVT-1	RB-1	P-1	P-2	P-1	P-1	P-3	10' - 0"	P-2 ON KITCHENETTE WALL, WP-1, CG-1
101A	STORAGE	LVT-1	RB-1	P-1	P-1	P-1	P-1	P-3	10' - 0"	WP-1
101B	RESTROOM	PT-1	PTB-1	PT-2, P-1	PT-,2, P-1	PT-2, P-1	PT-2, P-1	P-3	10' - 0"	PT-2 UP TO 48", COORD W/ ACCESSORIES
101C	MECH.	CONC	NONE	P-1	P-1	P-1	P-1	P-3	10' - 0"	
102	COMMUNITY BUSINESS CENTER	LVT-1	RB-1	PT-2	PT-2	P-1	PT-2	P-3	10' - 0"	CG-1
102A	MECH	CONC	NONE	P-1	P-1	P-1	P-1	P-3	10' - 0"	
102B	RESTROOM / SHOWER	PT-1	PTB-1	PT-2, P-1	PT-,2, P-1	PT-2, P-1	PT-2, P-1	P-3	10' - 0"	PT-2 UP TO 48", COORD W/ ACCESSORIES
103	OFFICE 1	LVT-1	RB-1	P-1	P-1	P-1	P-2	P-3	10' - 0"	
104	OFFICE 2	LVT	RB-1	P-1	P-1	P-1	P-2	P-3	10' - 0"	
105	LAUNDRY	PT-1	PTB-1	P-1	P-1	P-2	P-1	P-3	10' - 0"	

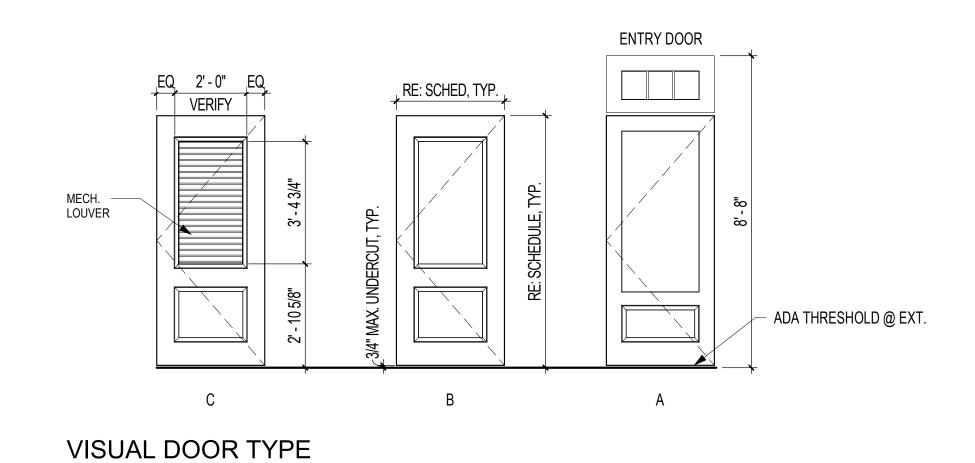

	WINDOW SCHEDULE
TYPE MARK	COMMENTS

6' - 0"

VERIFY w/ MFR

||||||| DBL 3060 |||||||

SINGLE HUNG

PAINTED WD SILLS, TYP

A	DBL. 3'-0" x 6'-0" SINGLE HUNG WINDOW
В	3'-0" x 6'-0" SINGLE HUNG WINDOW
С	DBL. 3'-0" x 6'-0" FIXED WINDOW

3/8" = 1'-0"

6' - 0"


VERIFY w/ MFR

DBL 3060 FIXED

DBL HUNG FIXED


3/8" = 1'-0"

VISUAL WINDOW TYPES

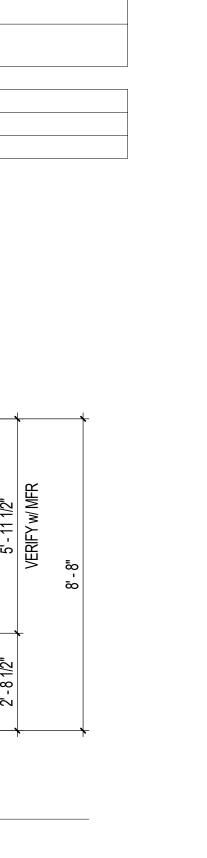

3' - 0" VERIFY w/ MFR

SINGLE HUNG

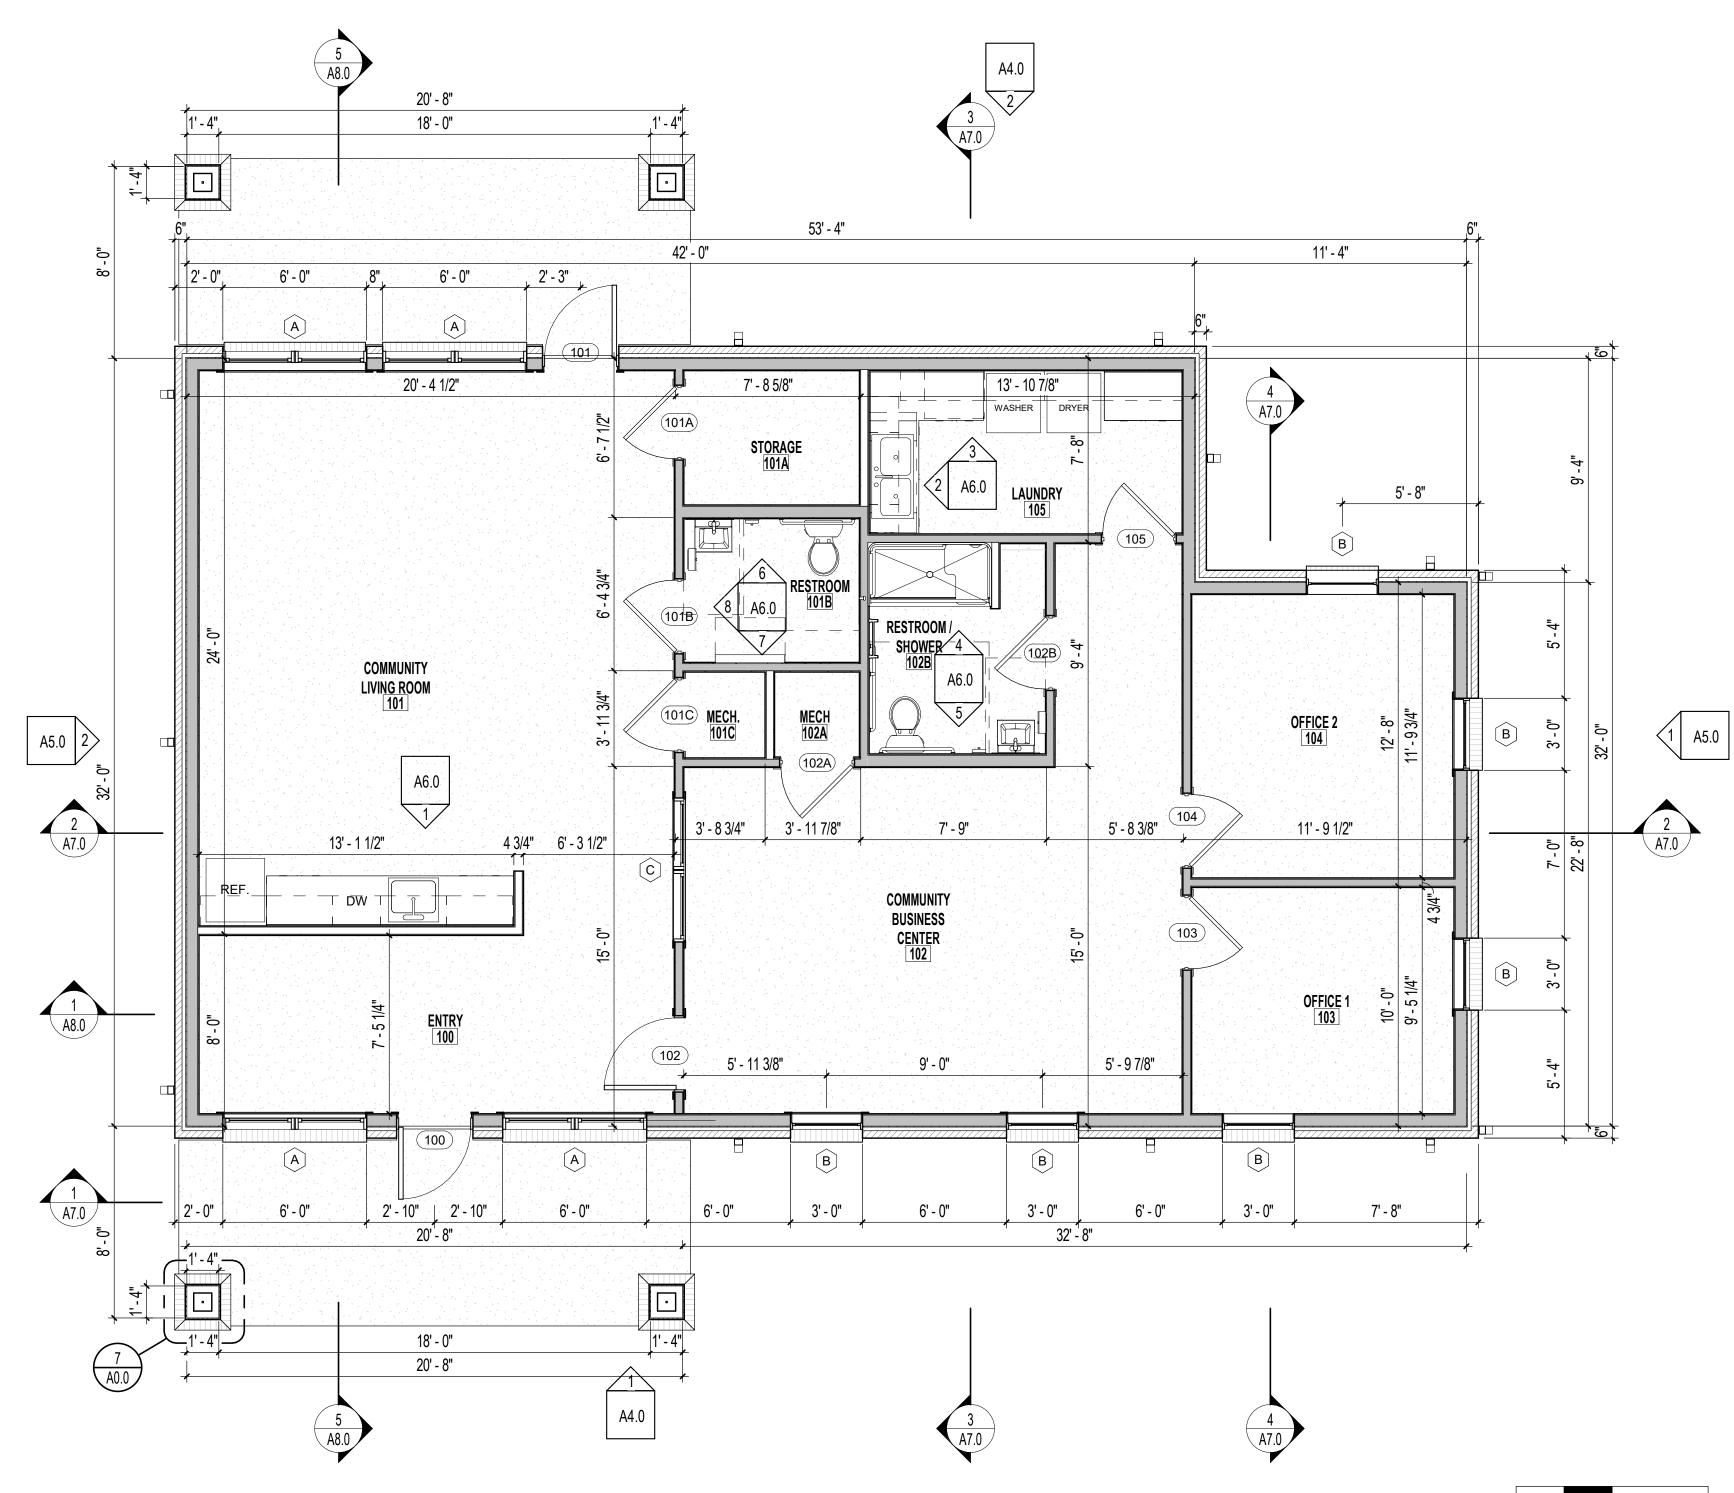

1 FLOOR PLAN
1/4" = 1'-0" 4

SCALE: 1/4" = 1'-0"

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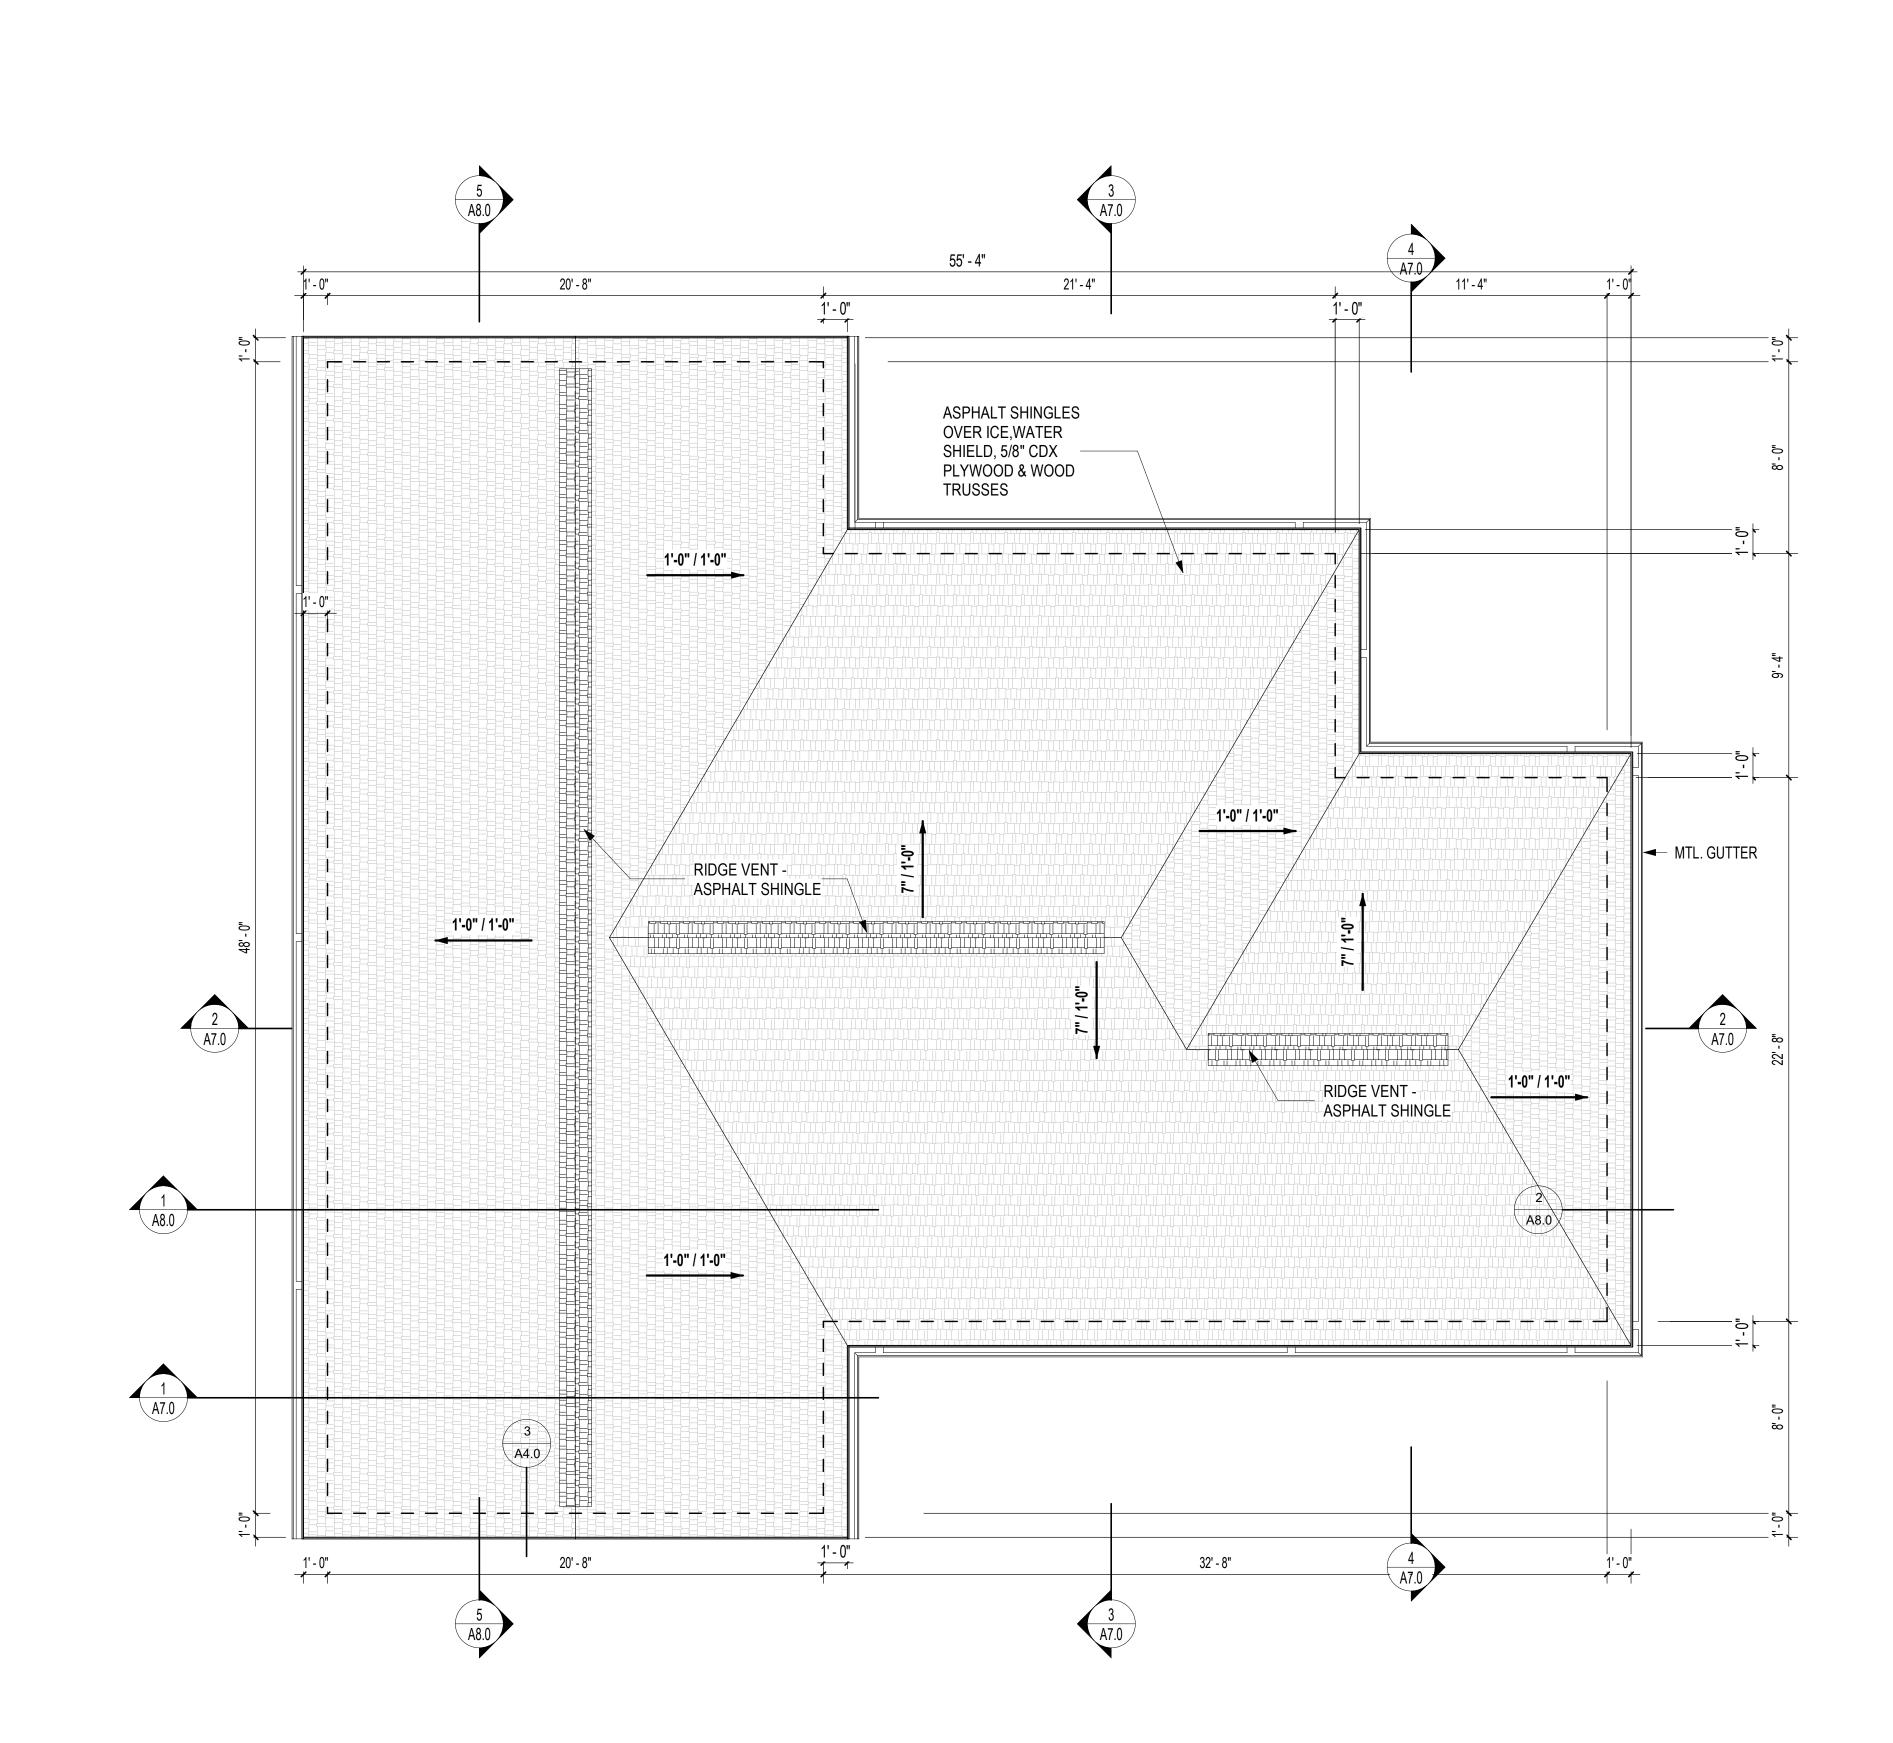
CONTENTS

FLOOR PLAN

BLDG

COMMUNITY

VETERANS' VIL



0 2 4 SCALE: 1/4" = 1'-0"

1 ROOF PLAN

1/4" = 1'-0" 4 / A

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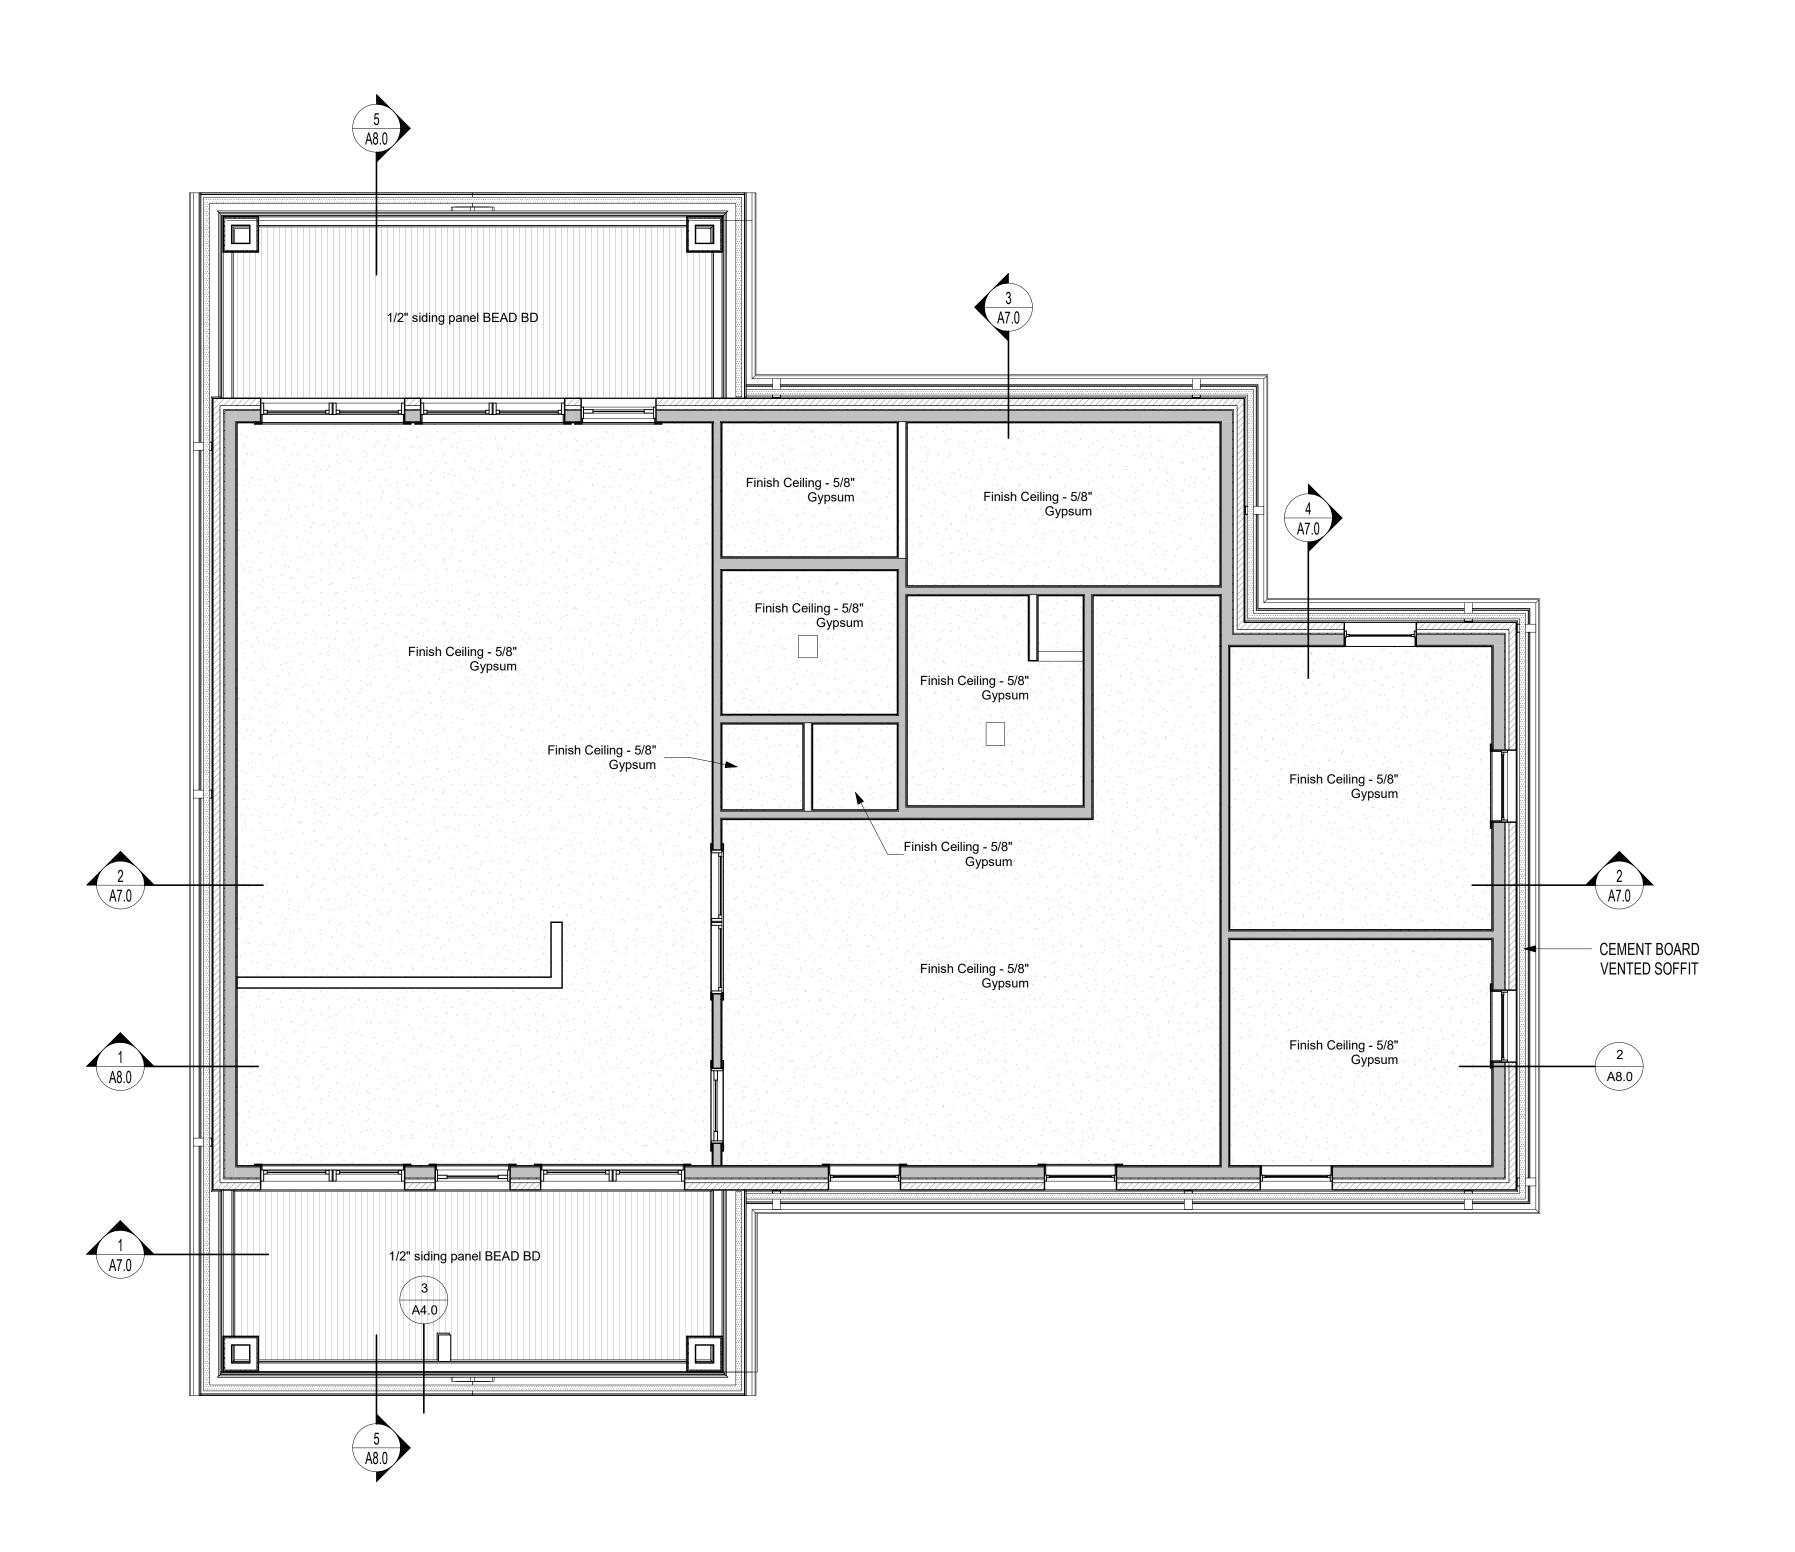
2021-01-03

ROOF PLAN

CONTENTS

COMMUNITY

VETERANS' VIL





LL237

REGISTERED

ARCHITEOTS

PHANSE

2021-01-03

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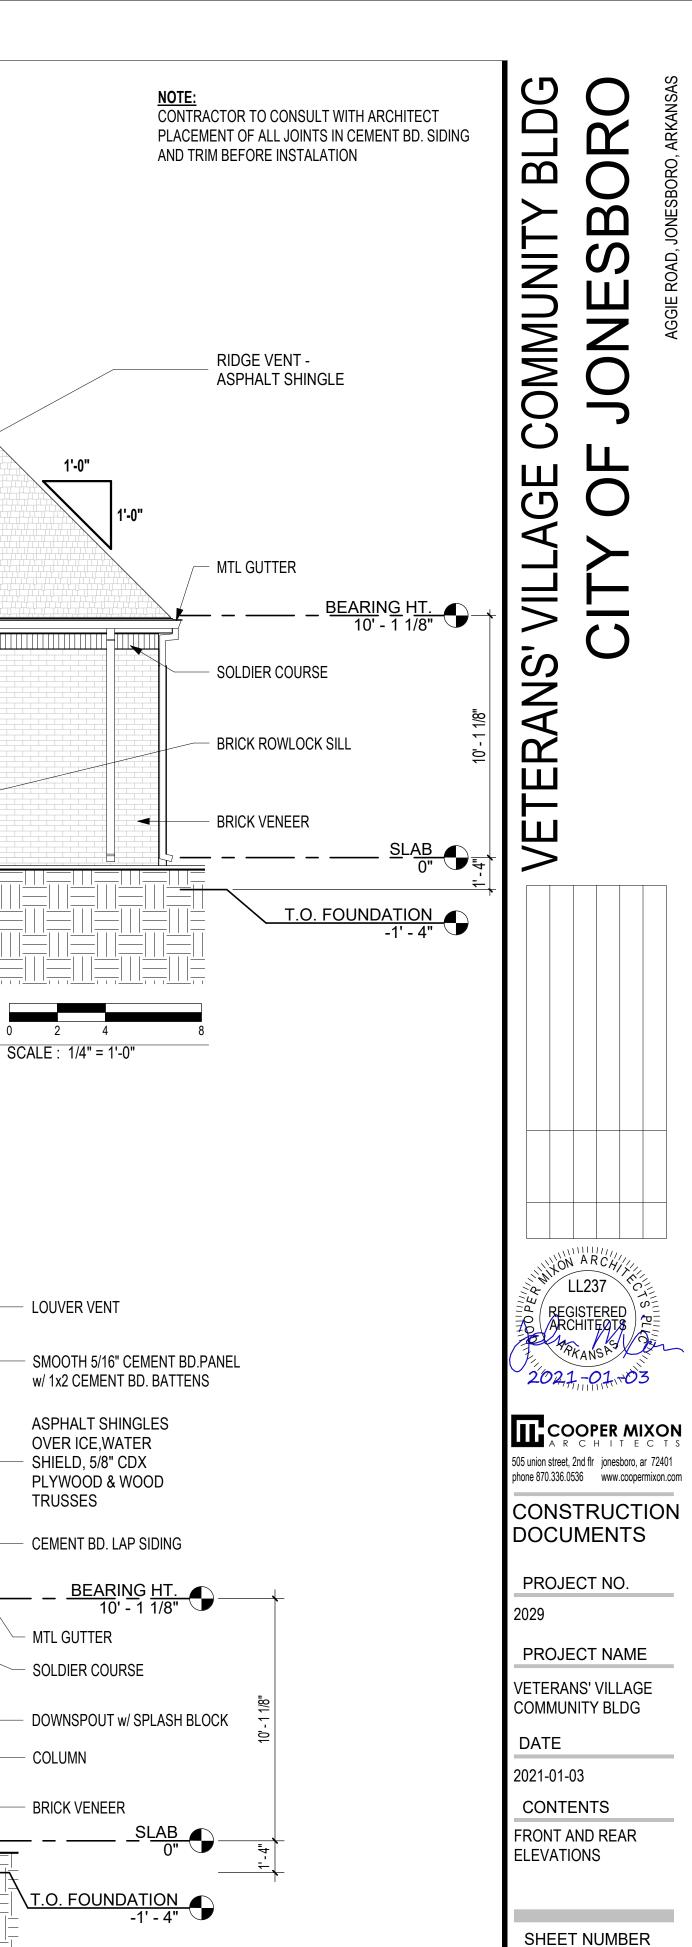
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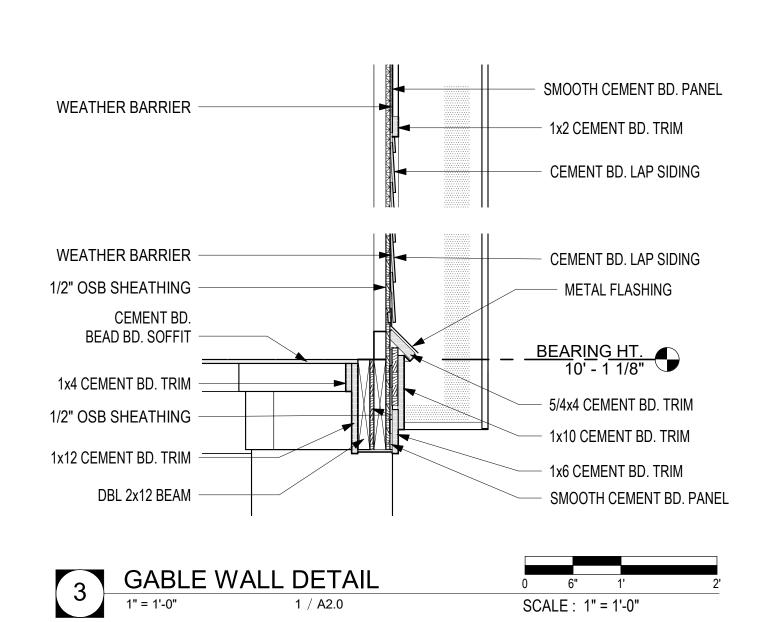
REFLECTED CEILING PLAN


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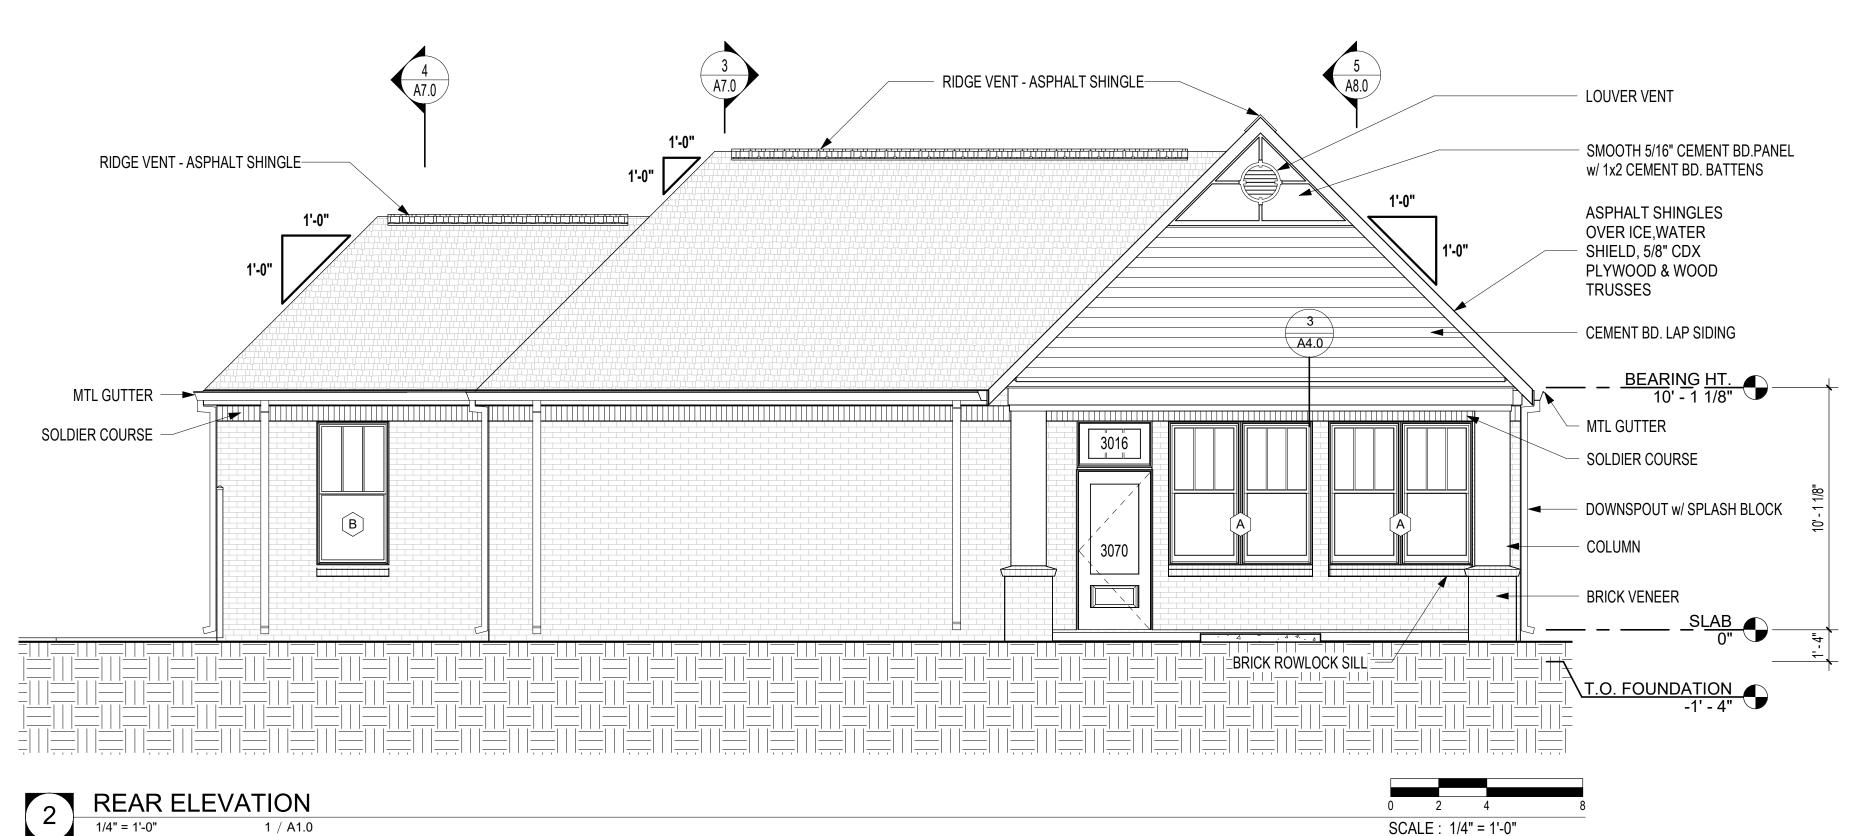
A3.0


SCALE: 1/4" = 1'-0"










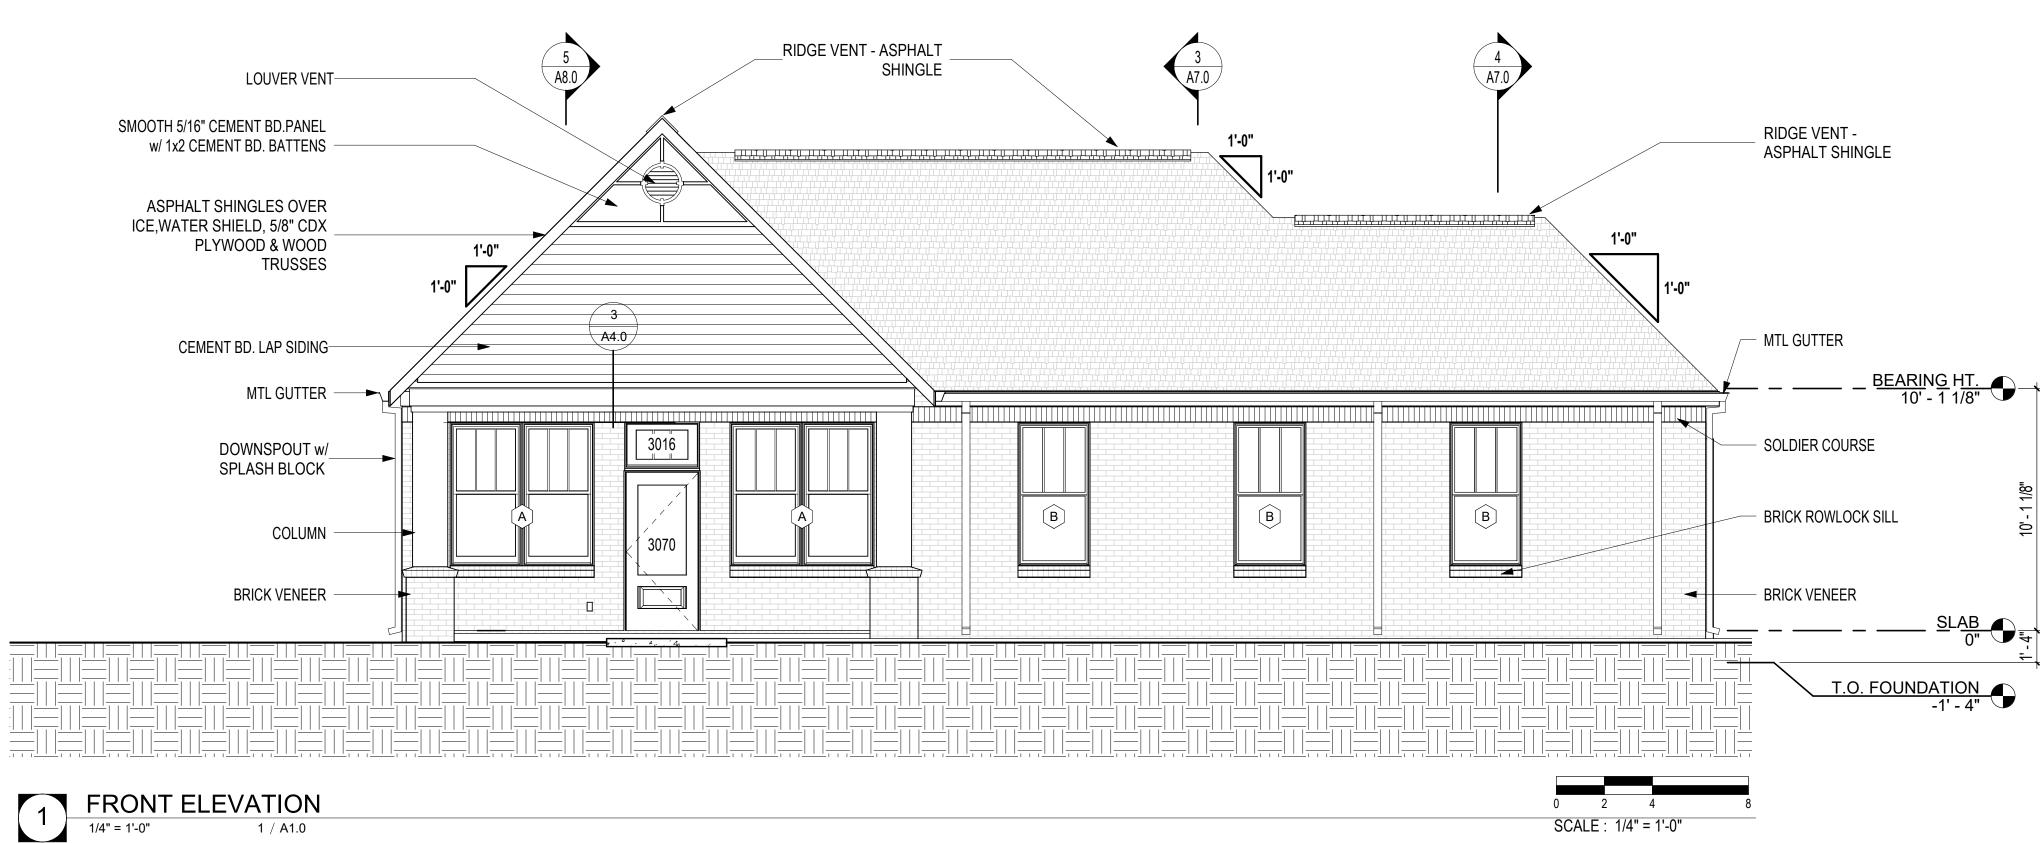


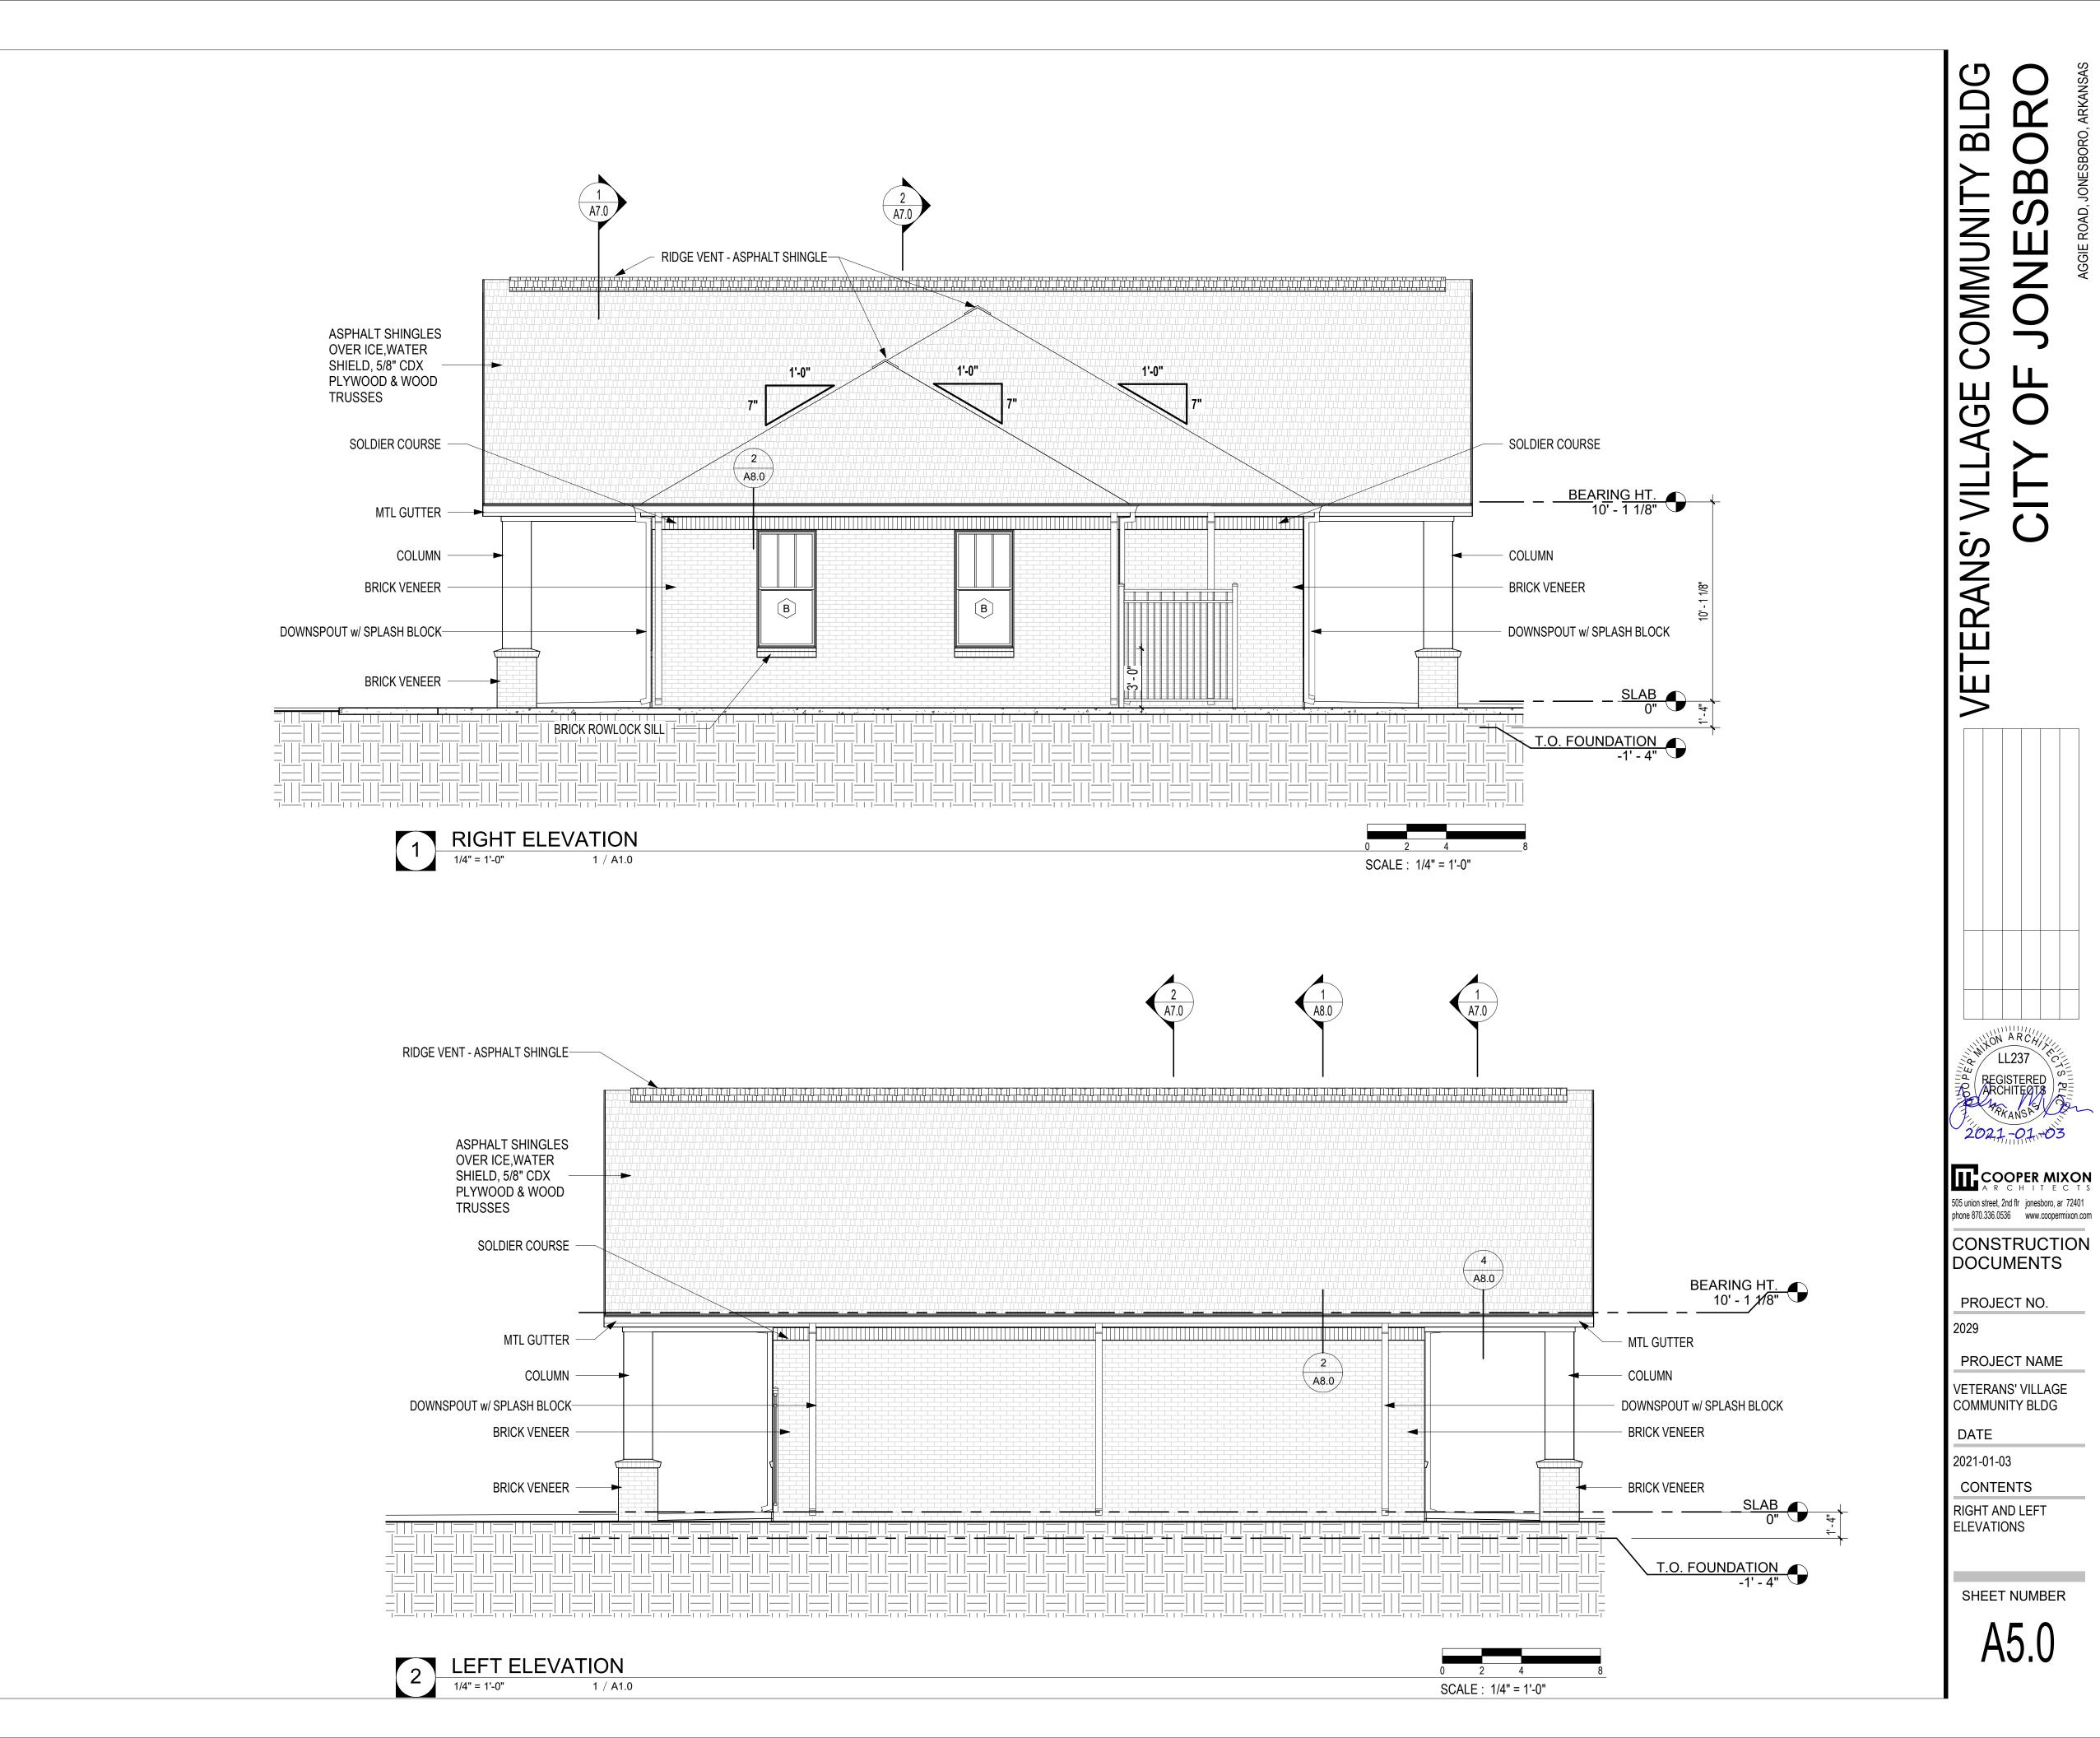


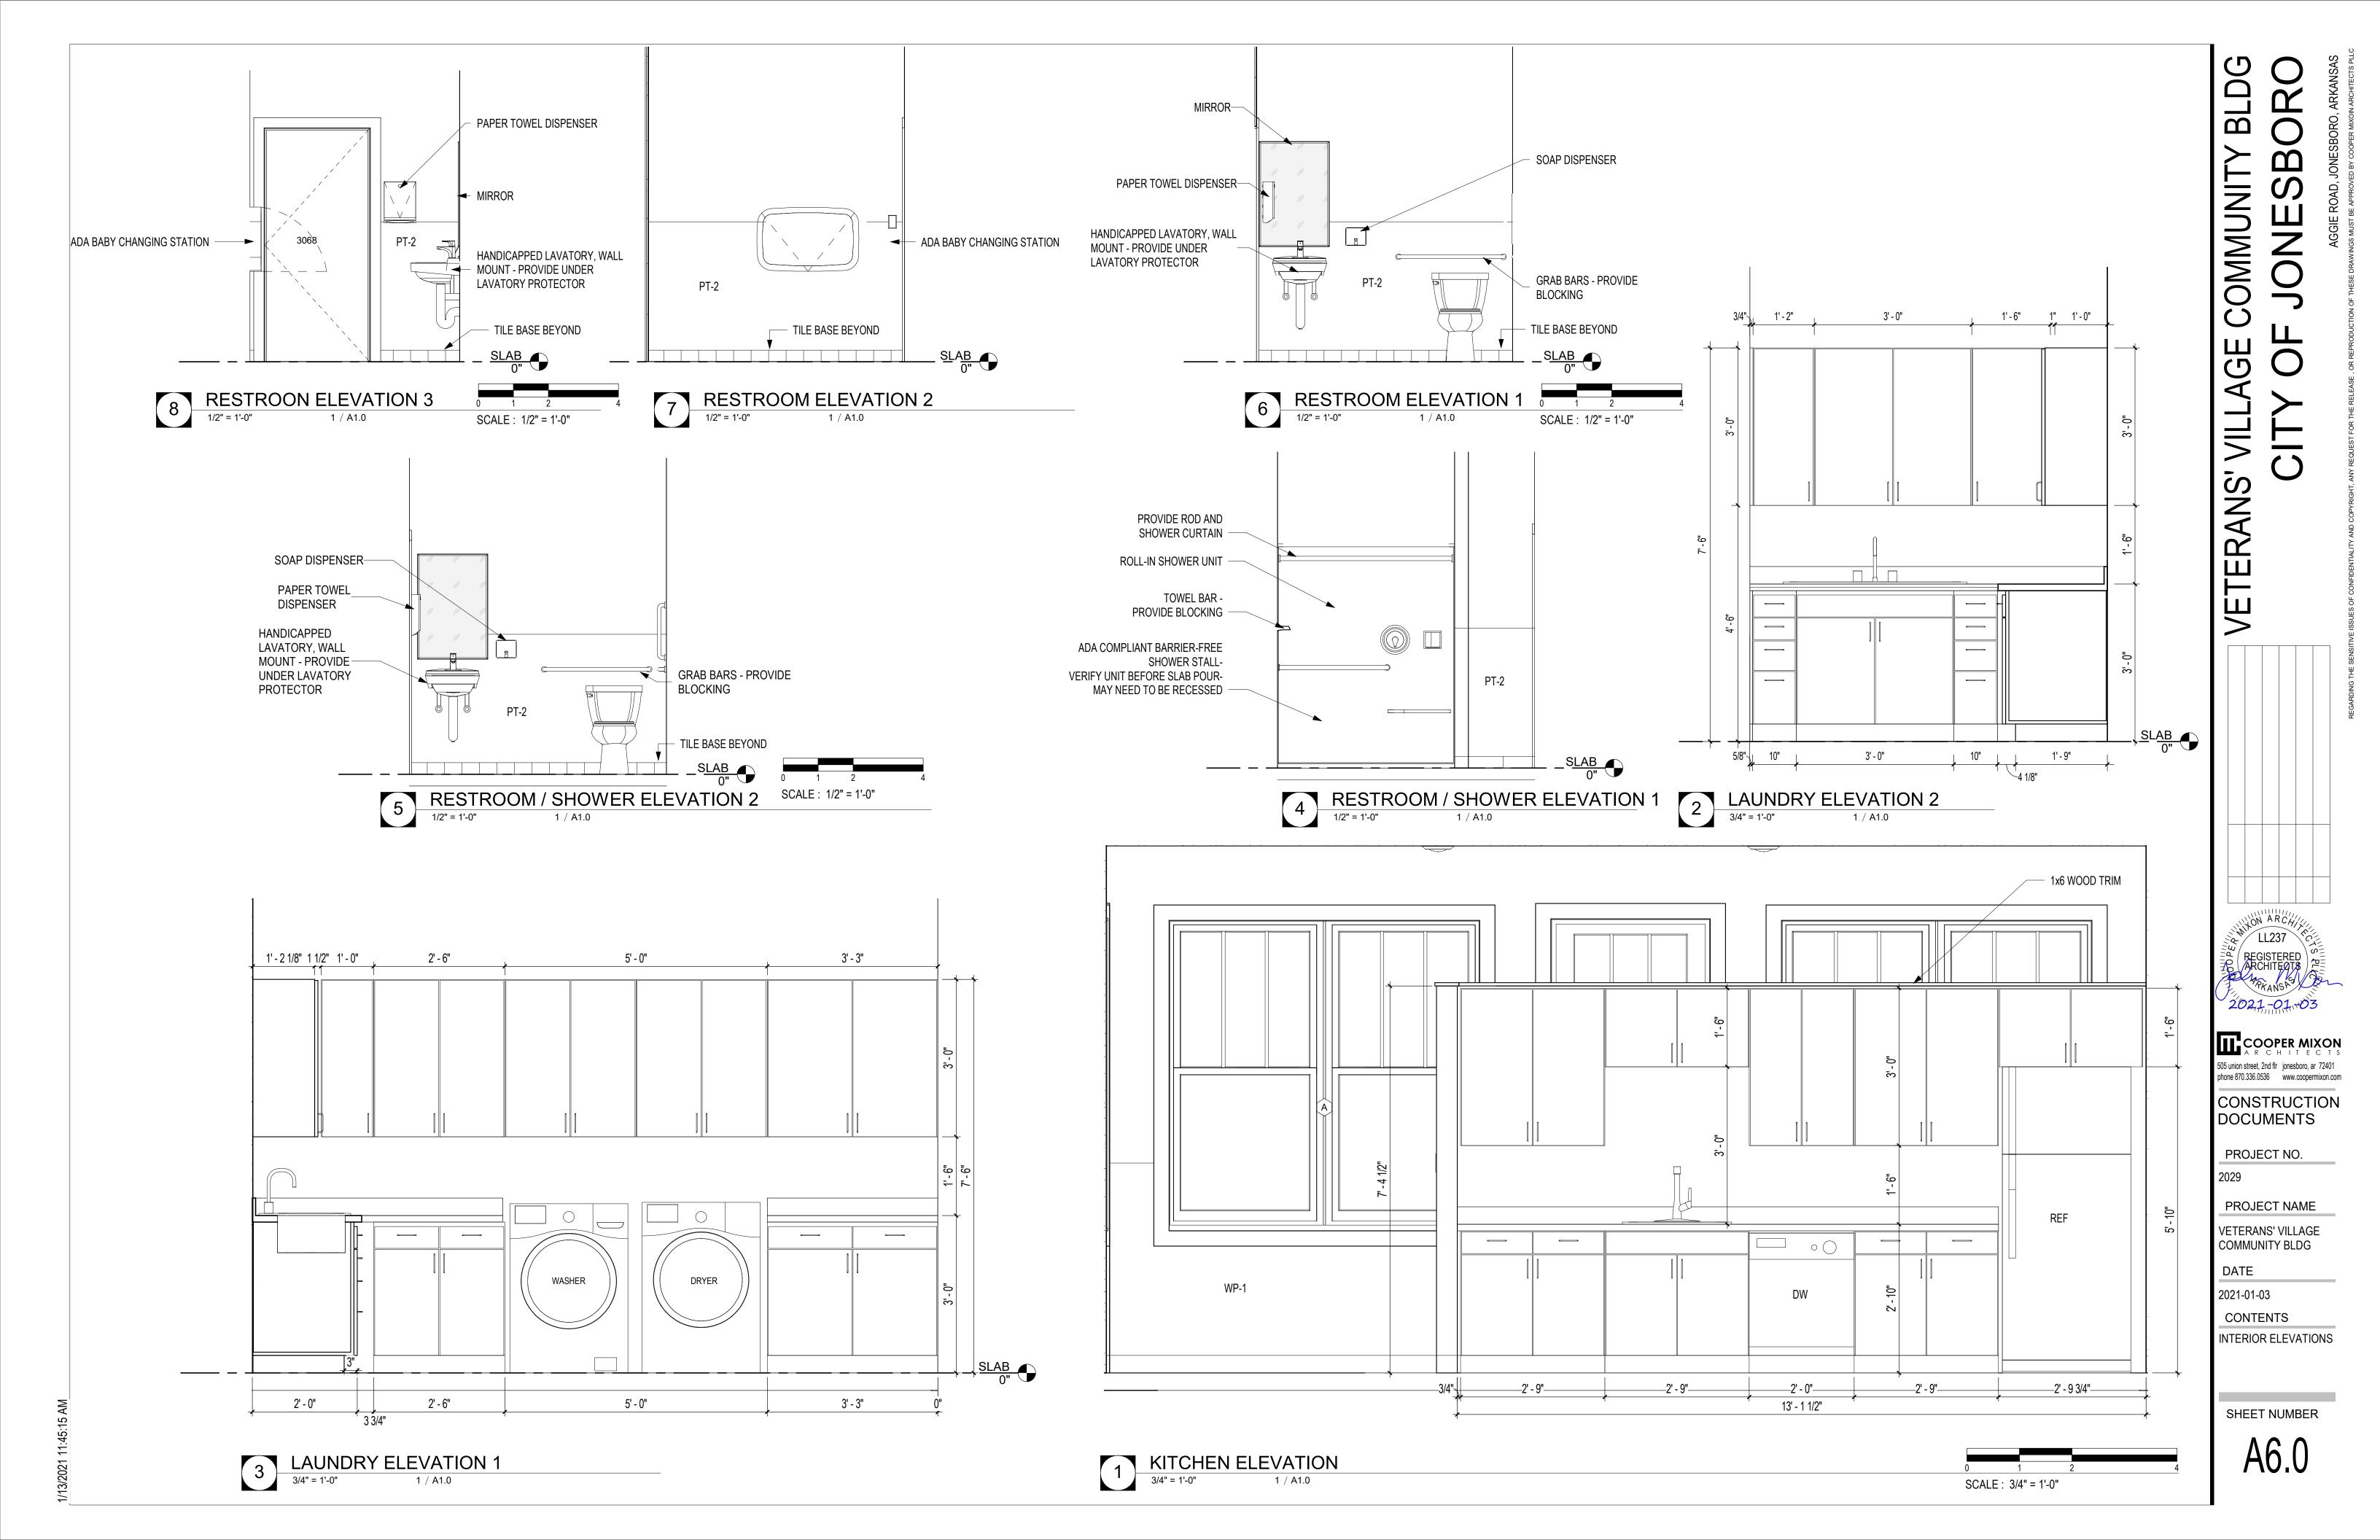

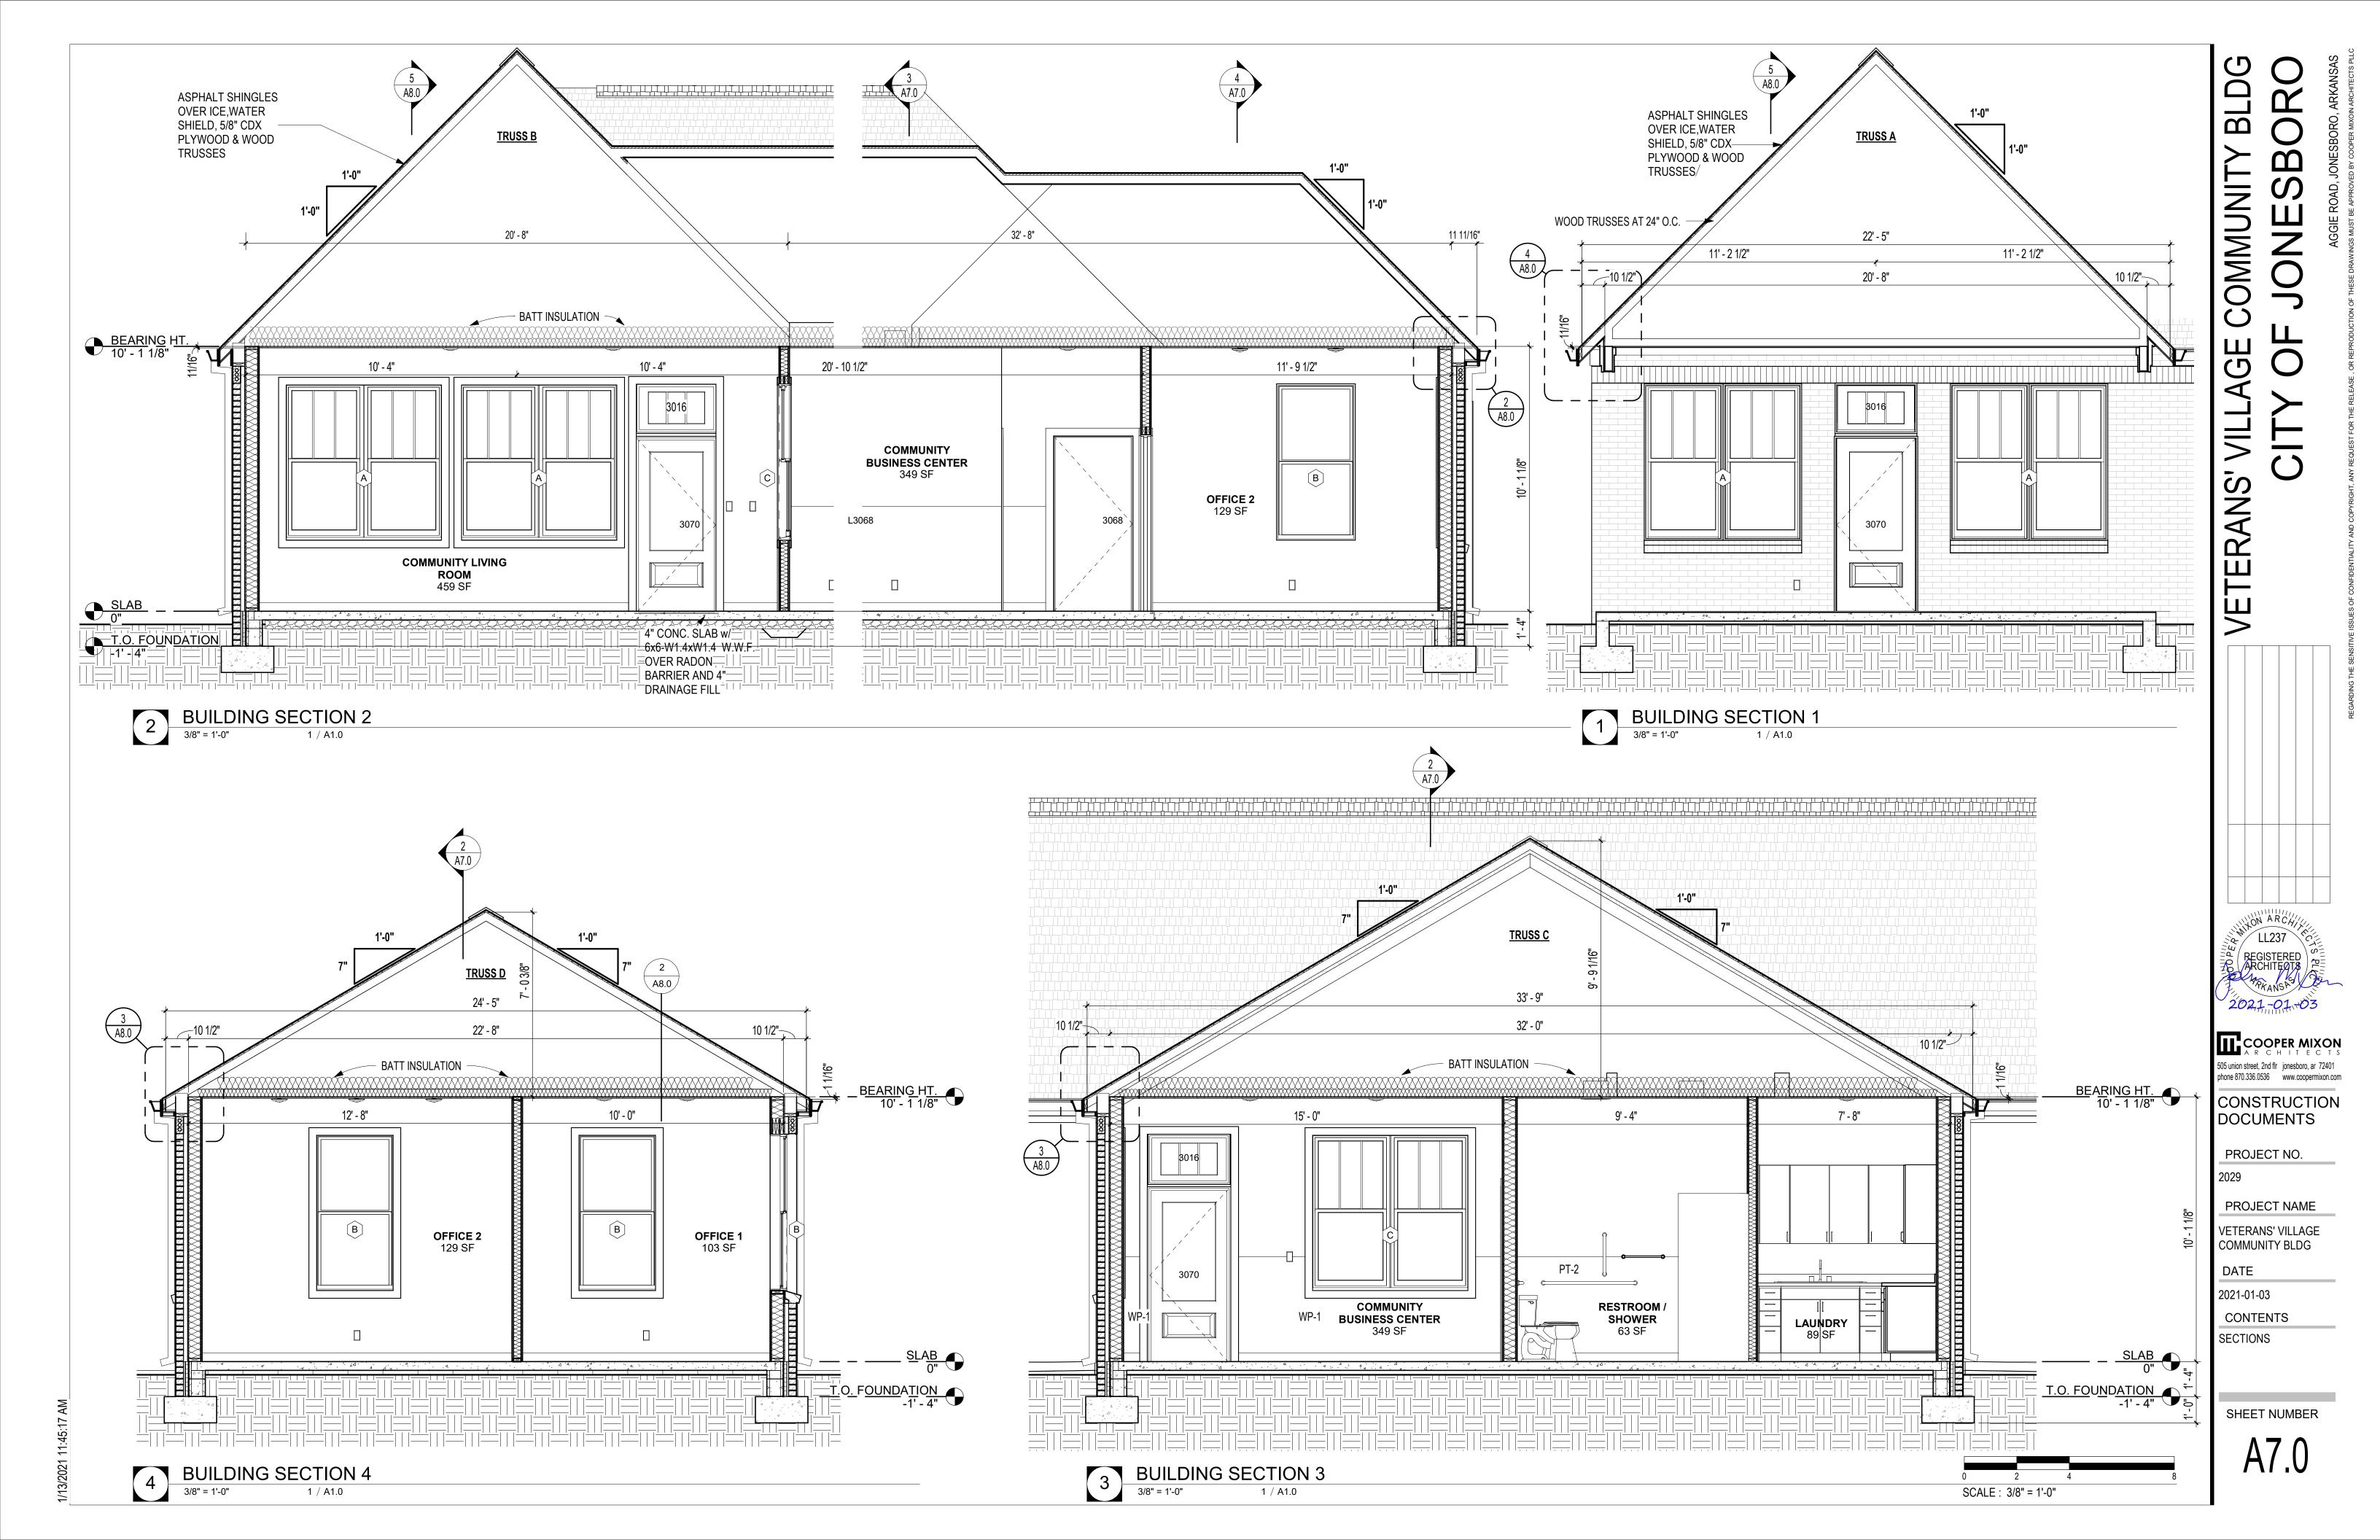

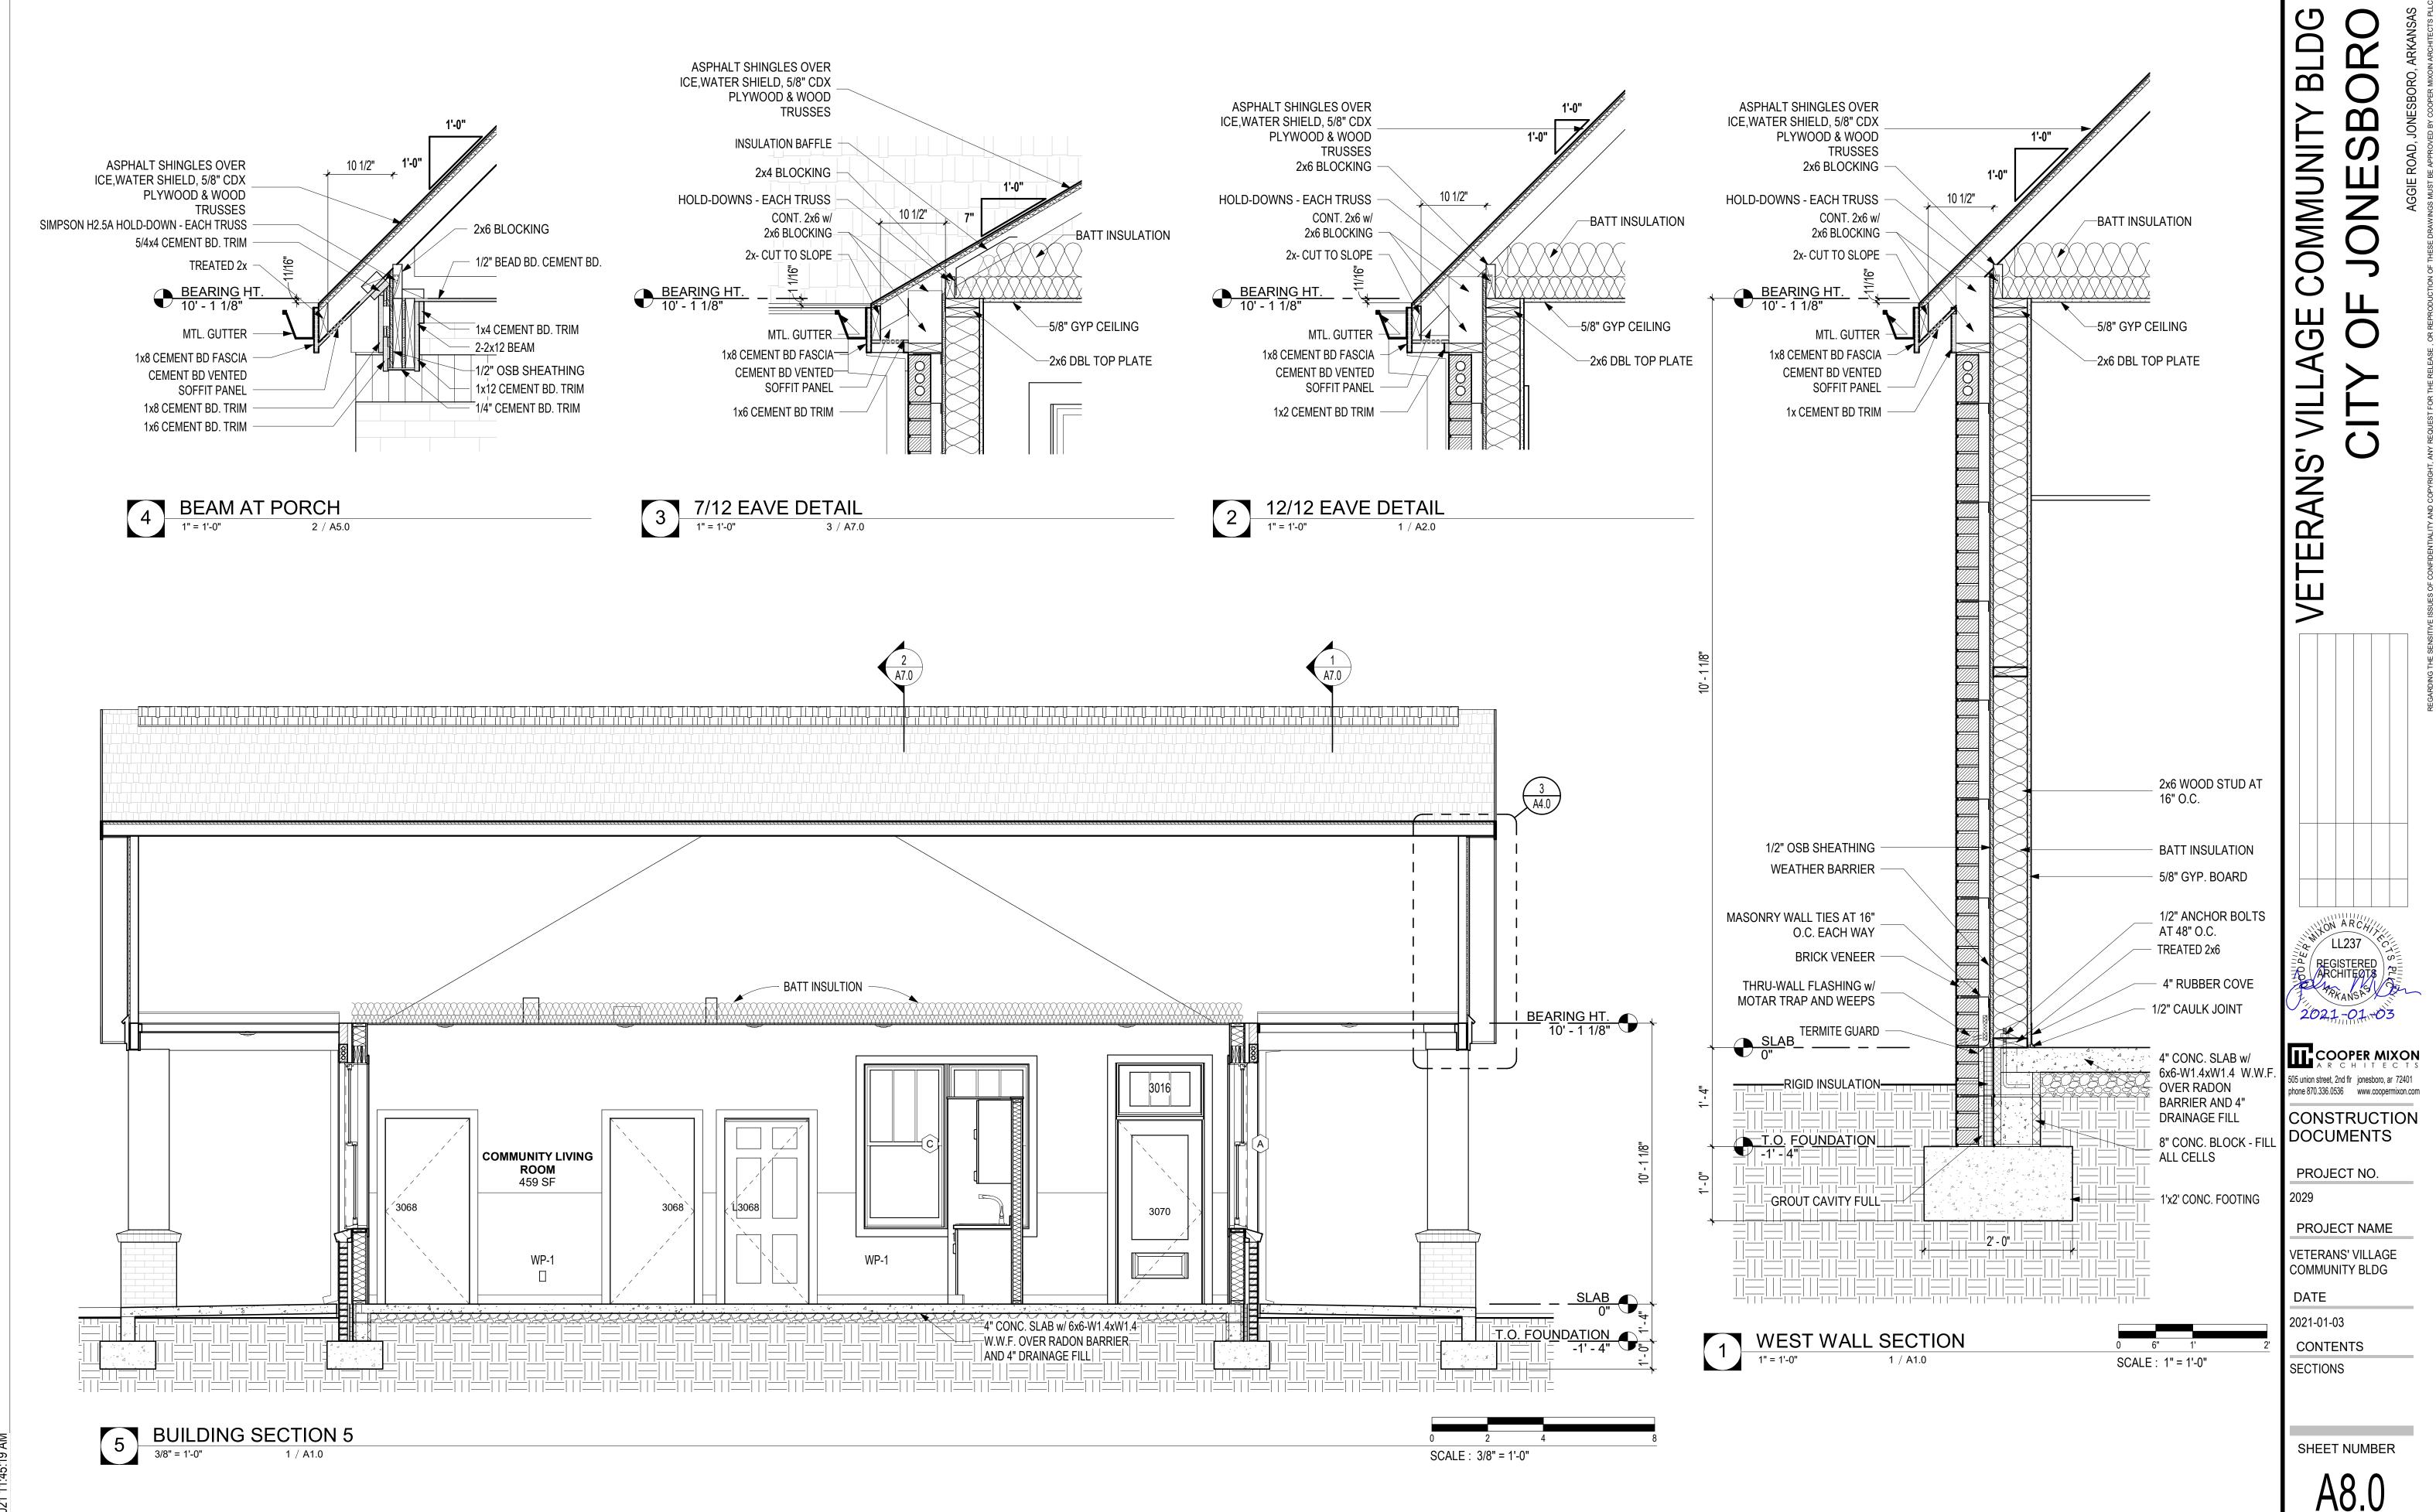

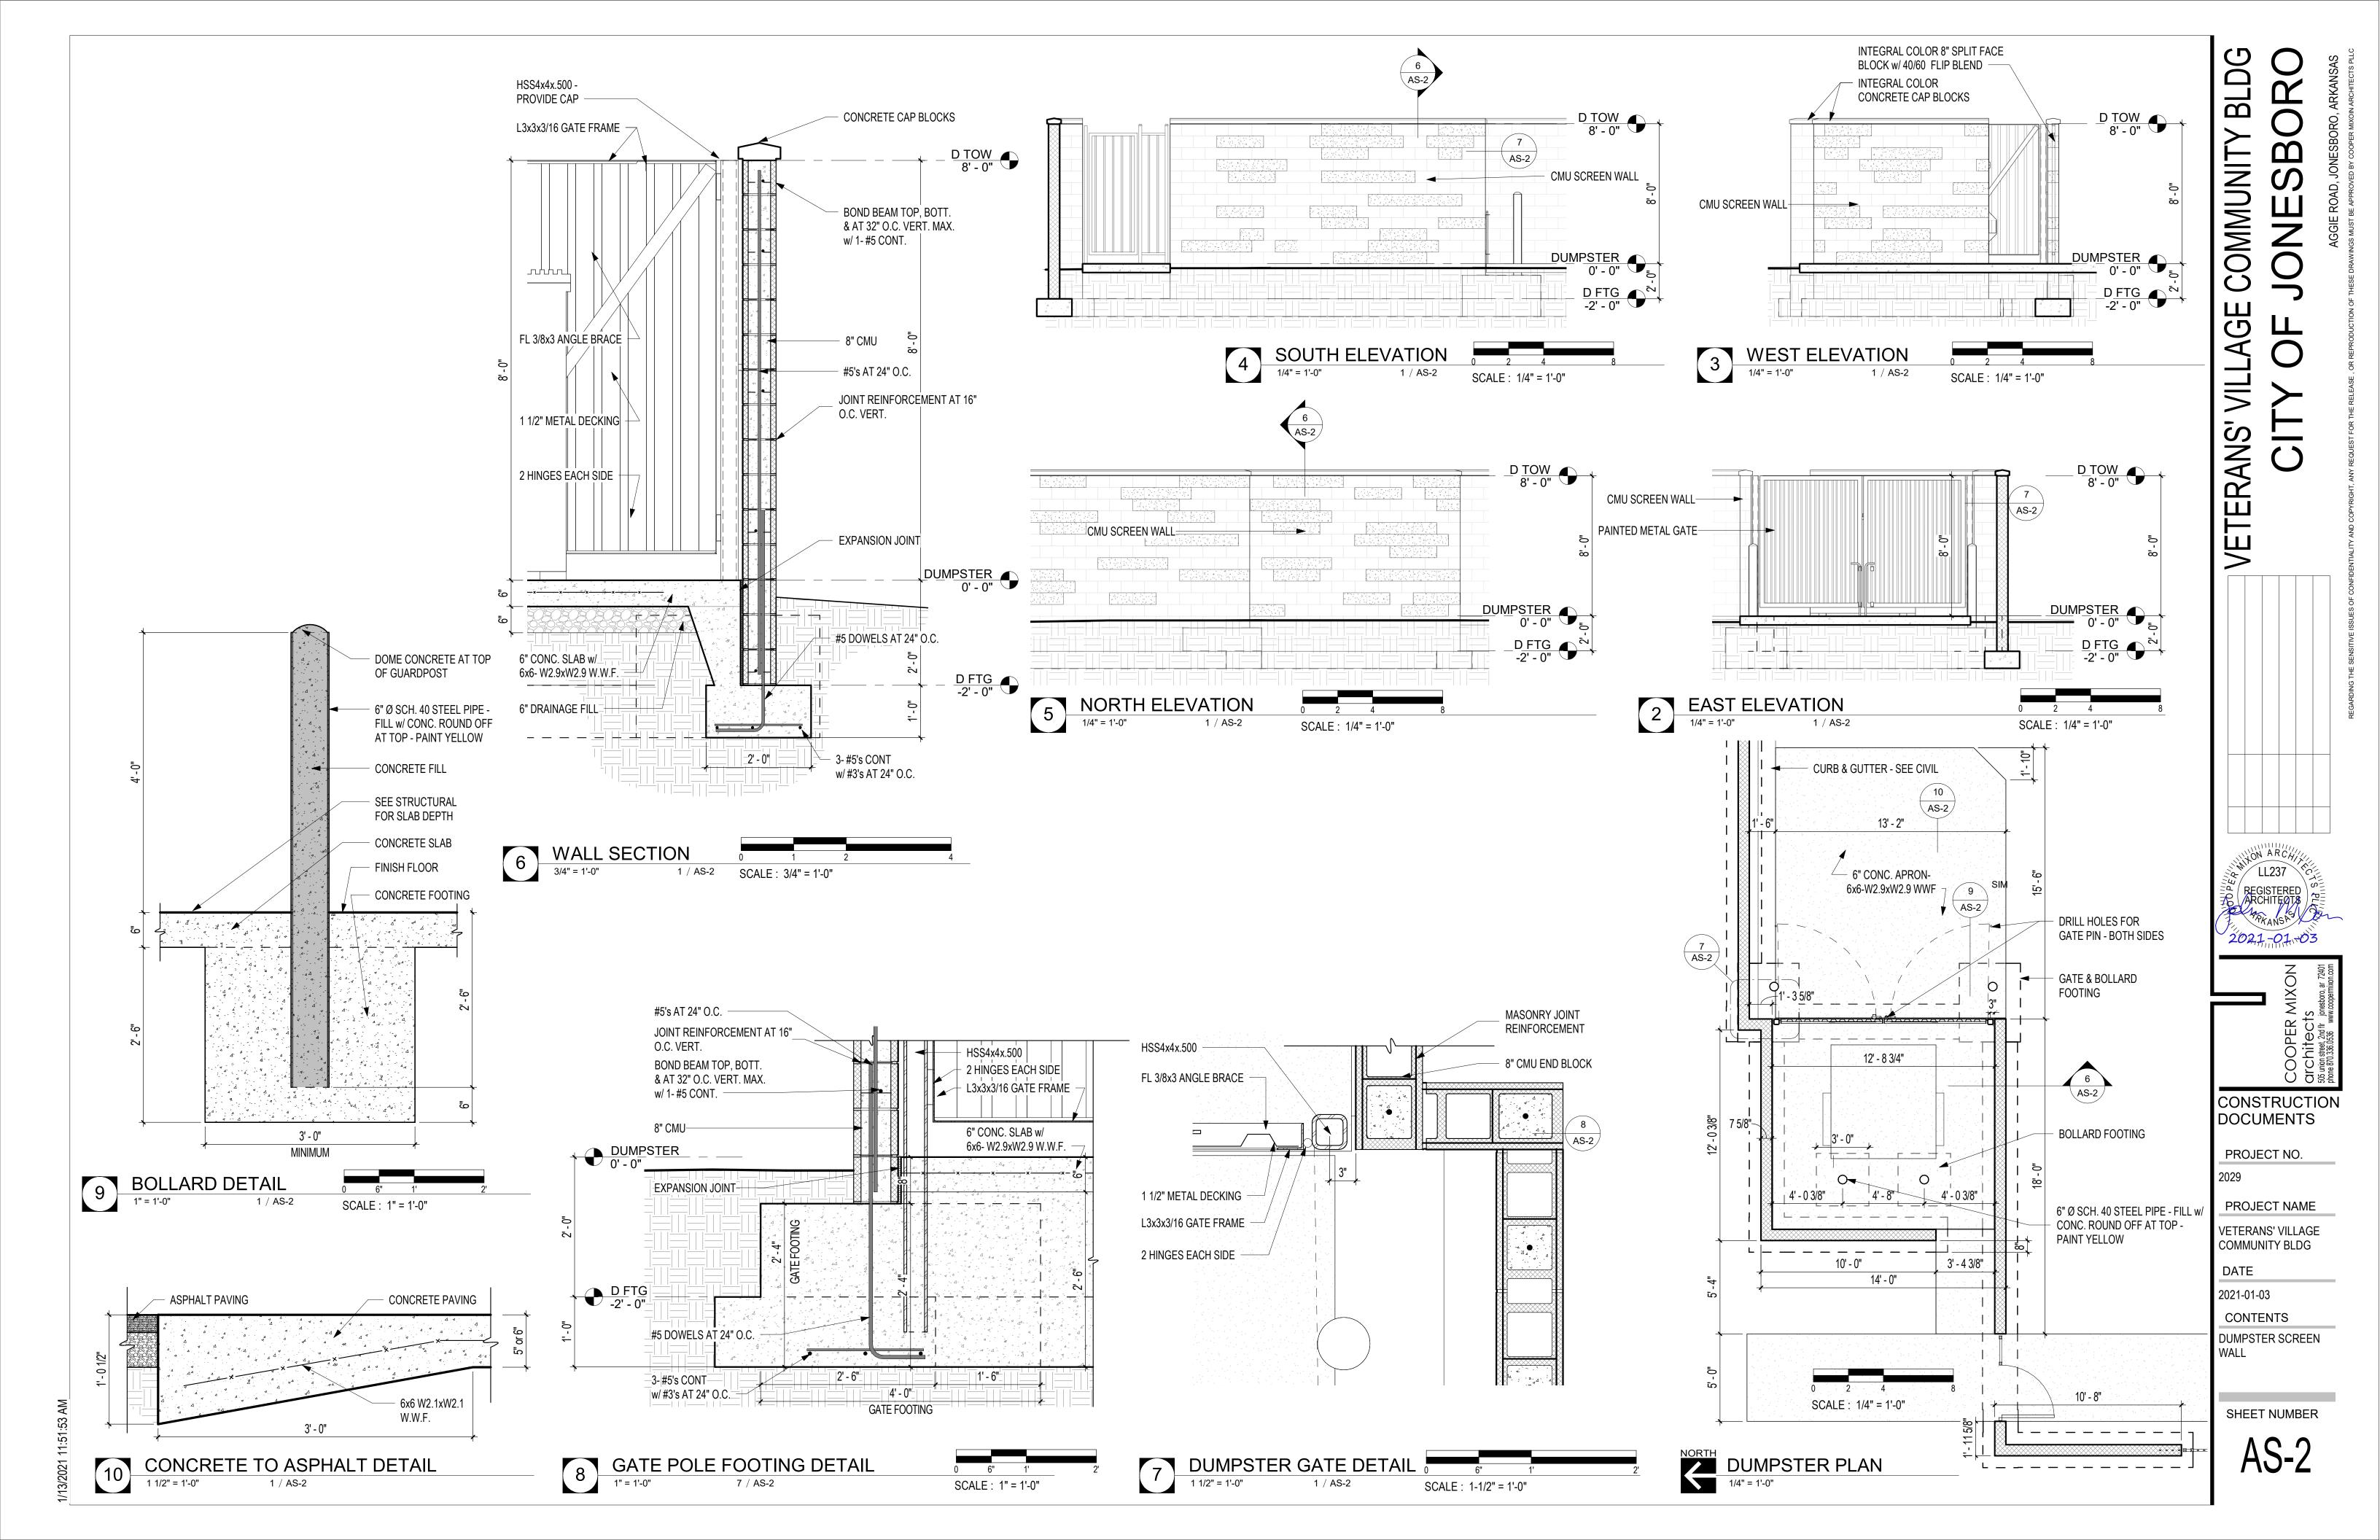

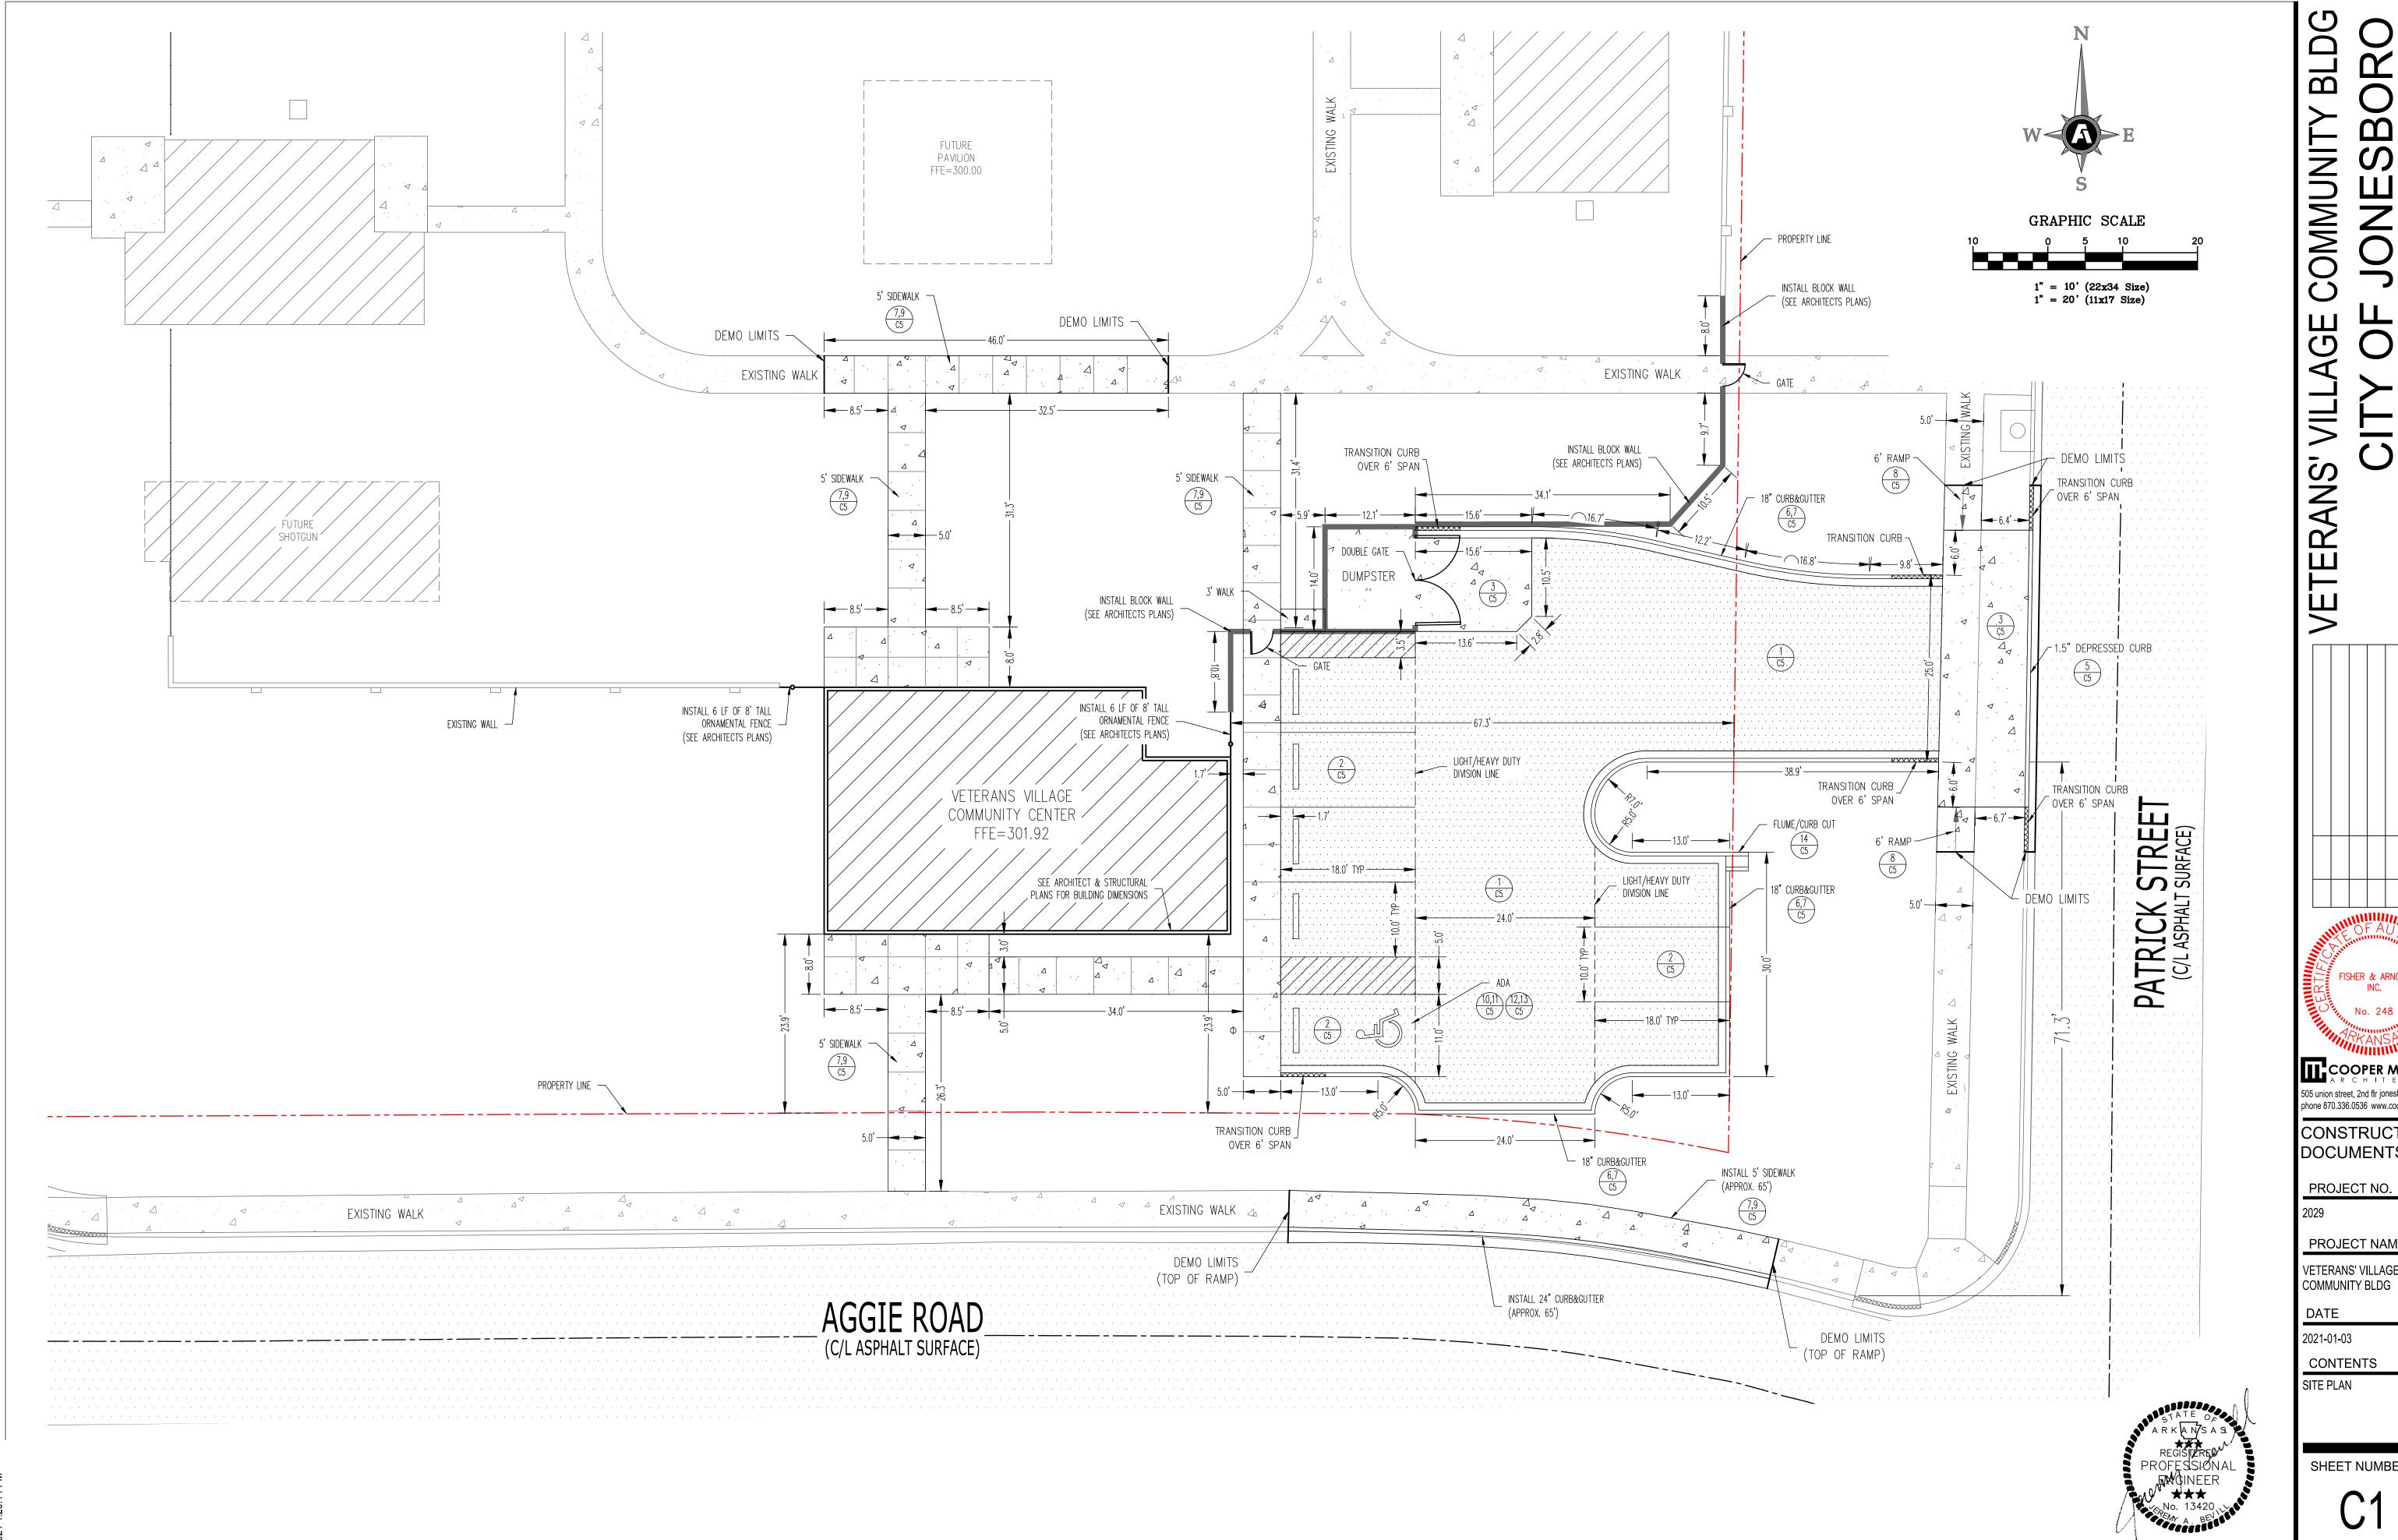

BLDG COMMUNIT ONESI

FISHER & ARNOLD

COOPER MIXON
ARCHITECTS 505 union street, 2nd flr jonesboro, ar 72401 phone 870.336.0536 www.coopermixon.com

CONSTRUCTION **DOCUMENTS**


PROJECT NAME VETERANS' VILLAGE


DATE

2021-01-03

SITE PLAN



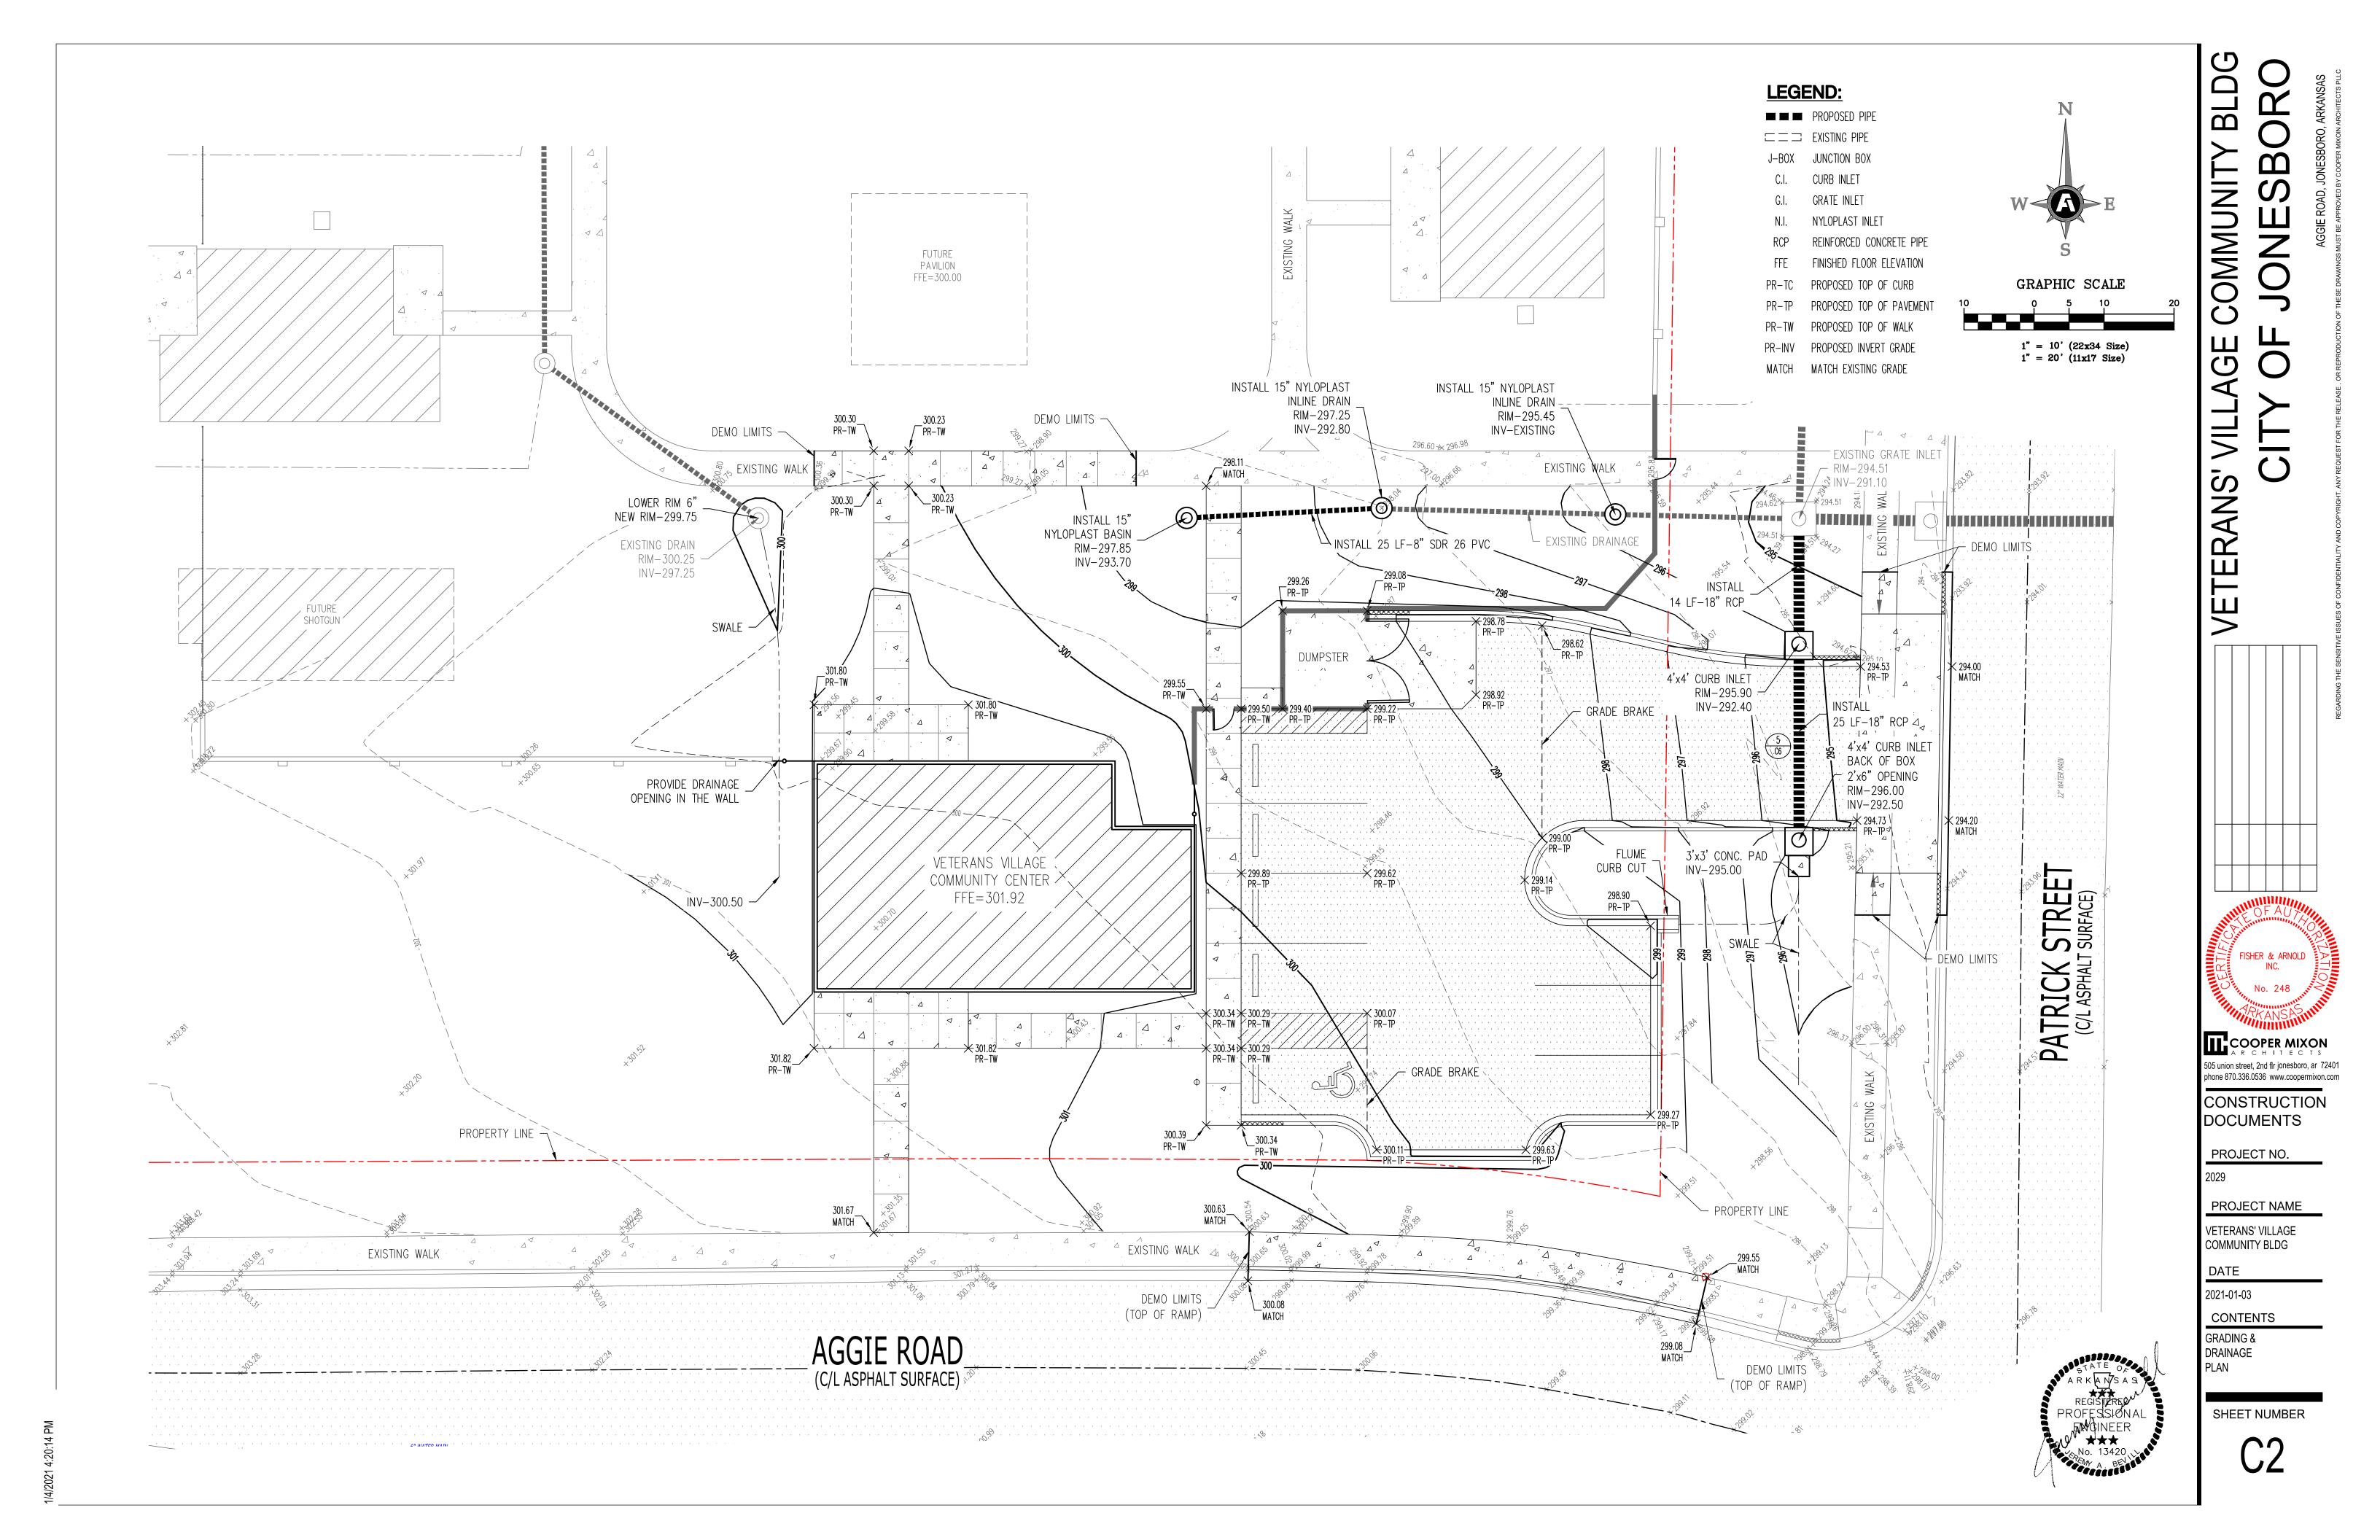


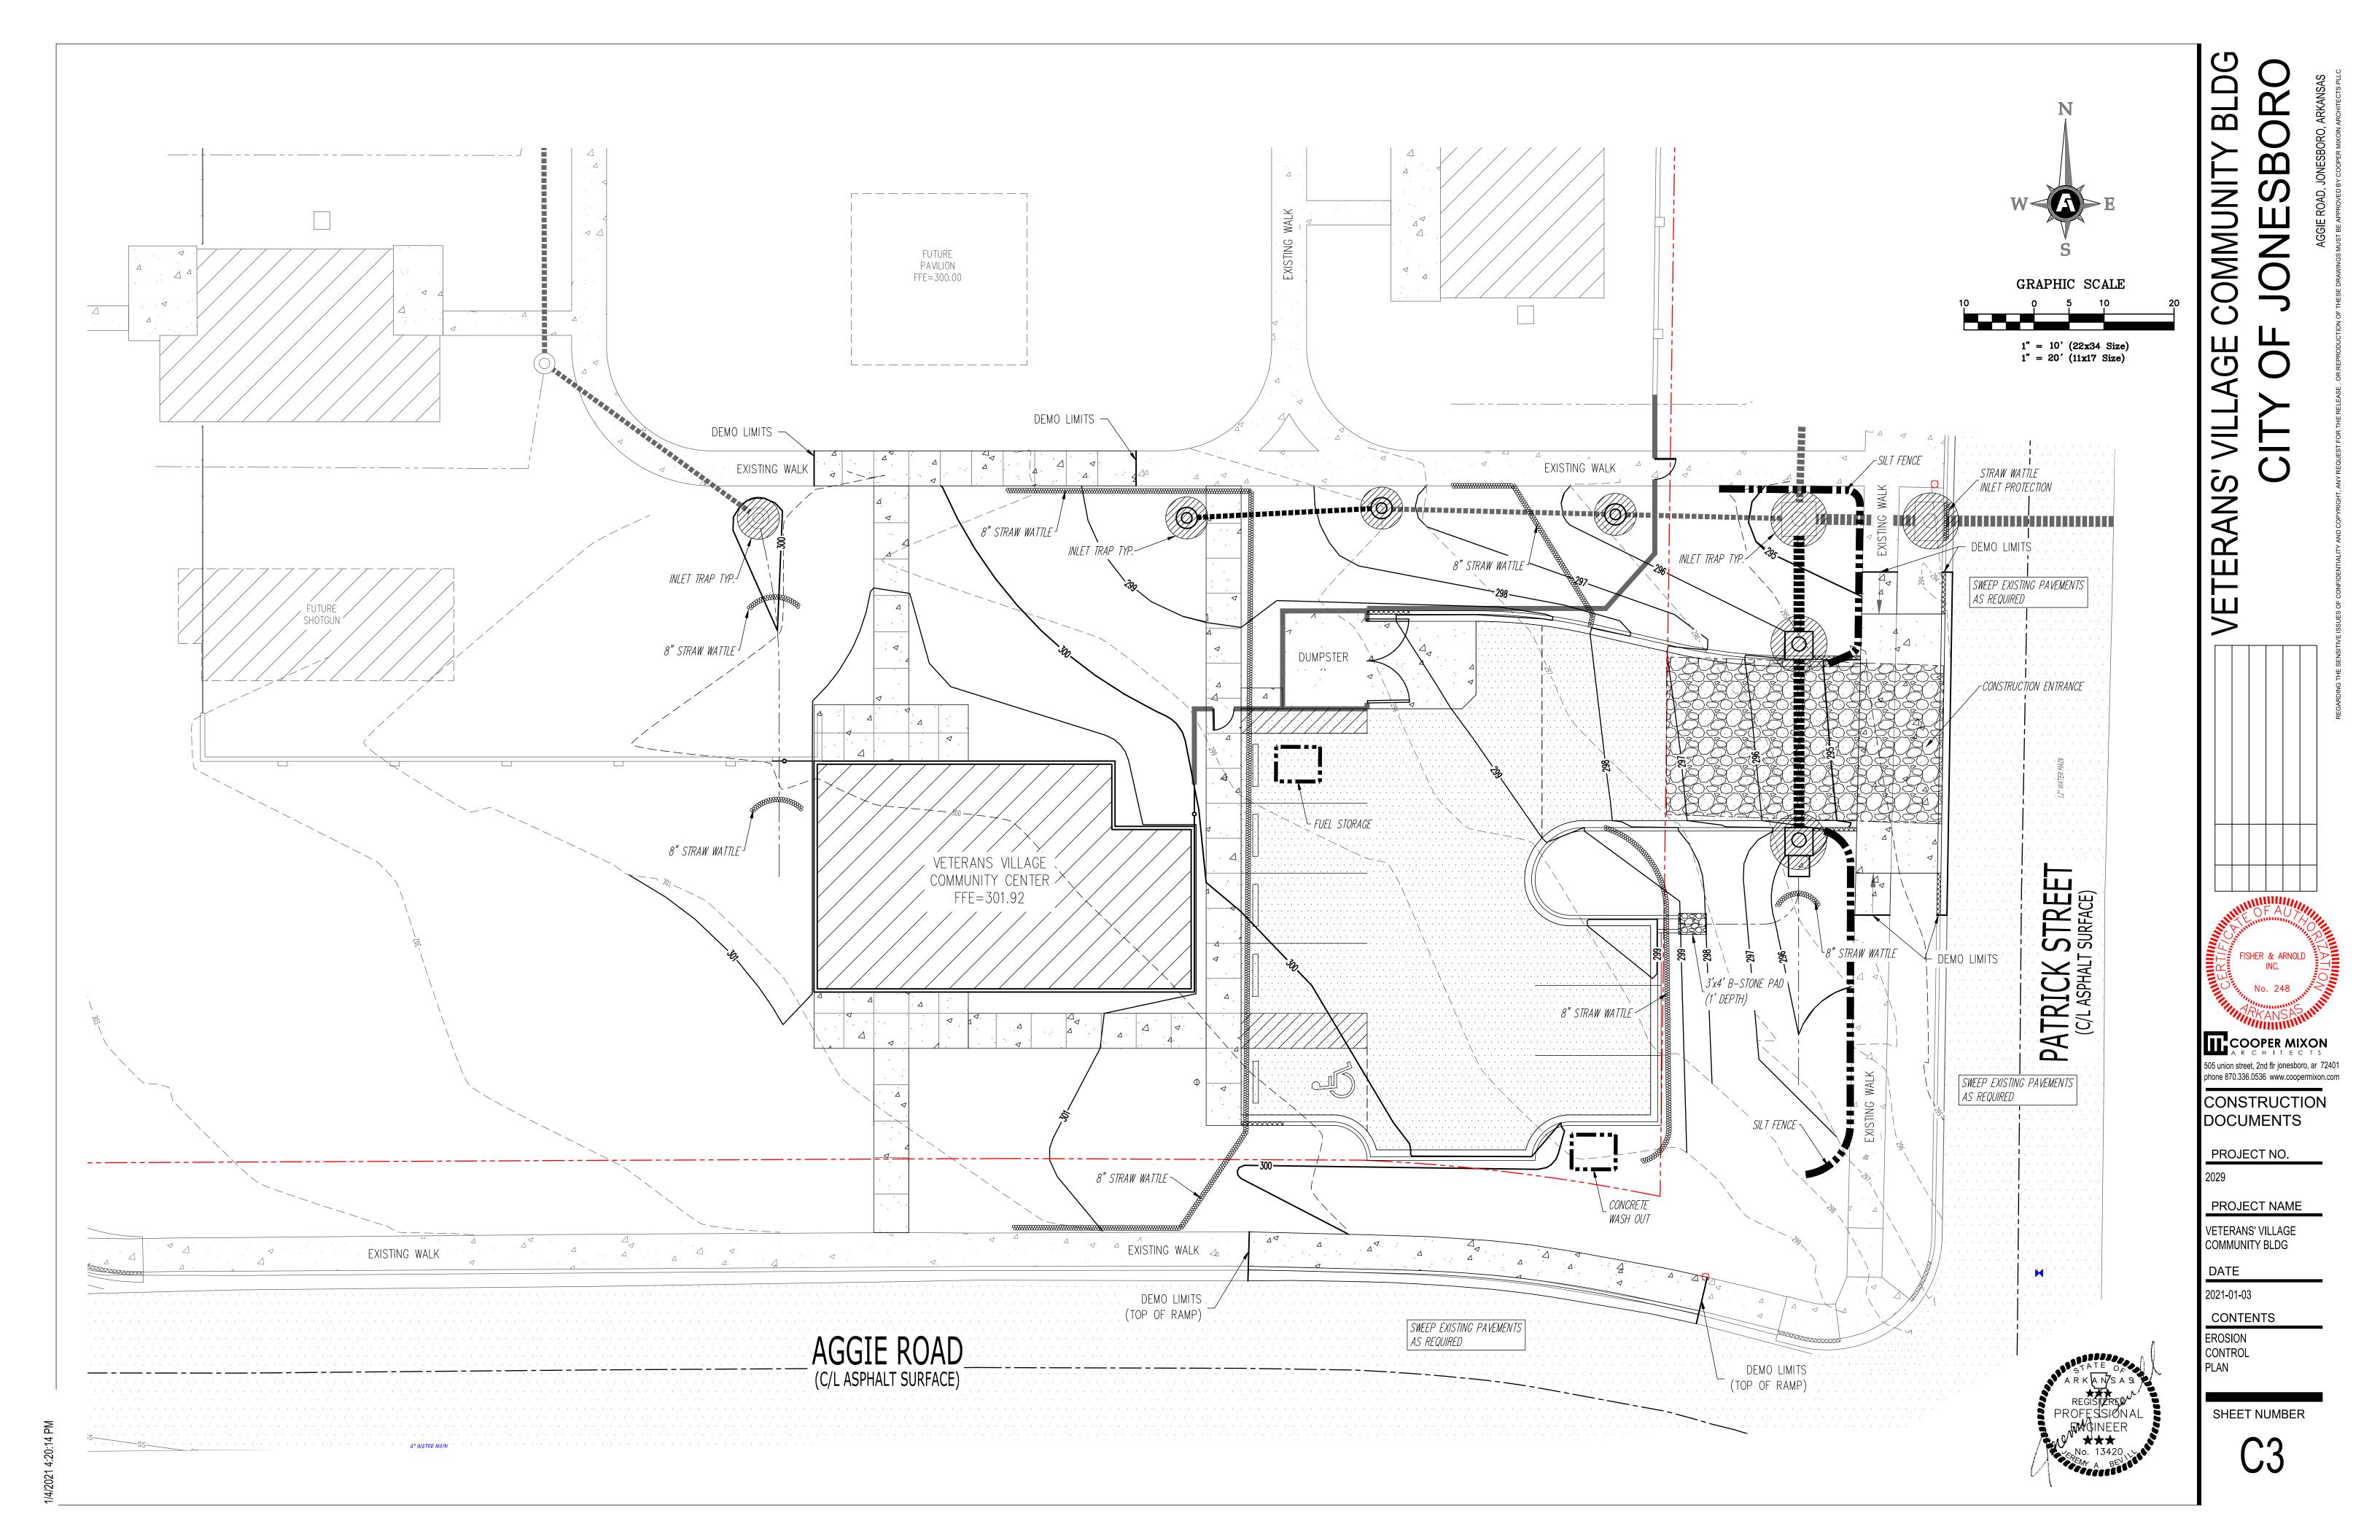



UTILITY CONTRACTOR NOTES:

- 1. WATER MAINS CROSSING SEWERS SHALL BE LAID TO PROVIDE A MINIMUM VERTICAL DISTANCE OF 18" AND A MINIMUM HORIZONTAL SEPARATION OF 10' BETWEEN THE OUTSIDE OF THE WATER MAIN AND THE OUTSIDE OF THE SEWER. THIS SHALL BE THE CASE WHERE THE WATER MAIN IS EITHER ABOVE OR BELOW THE SEWER WITH PREFERENCE TO THE WATER MAIN LOCATED ABOVE THE SEWER.
- 2. AT CROSSINGS, ONE FULL LENGTH OF WATER PIPE SHALL BE LOCATED SO BOTH JOINTS WILL BE AS FAR FROM THE SEWER AS POSSIBLE. SPECIAL STRUCTURAL SUPPORT FOR THE WATER AND SEWER PIPES MAY BE REQUIRED.
- 3. UTILITY CONTRACTOR IS RESPONSIBLE FOR THE INTEGRITY OF UTILITY STREET CROSSING, WHICH INCLUDES ALL WATER AND SEWER MAINS AND WATER AND SEWER SERVICES.
- 4. FLOWABLE FILL IS TO BE USED AS BACKFILL WHERE THE WATER MAIN AND SEWER MAIN CROSSES THE STREET AND ALL SEWER SERVICES THAT ARE IN THE STREET.
- 5. ALL LONG WATER SERVICES ARE TO BE BACKFILLED WITH EITHER FLOWABLE FILL, COMPACTED SAND, OR COMPACTED 3/4" MINUS LIMESTONE.
- 6. SANITARY SEWER LENGTHS ARE FROM THE CENTER OF THE SSMH.
- 7. NO TRANSFORMERS, JUNCTION BOXES, OR PULL BOXES TO BE PLACED OVER WATER FITTINGS.
- 8. CITY WATER & LIGHT IS NOT RESPONSIBLE FOR ANY WATER OR SEWER TRENCH SETTLEMENT BEFORE OR AFTER WARRANTY PERIOD
- 9. THE DEVELOPER & ENGINEER ARE RESPONSIBLE FOR METER BOX LOCATIONS. ANY CONFLICTS THAT REQUIRE PLASTIC BOX(S) TO BE CHANGED OUT TO CONCRETE BOX(S) WILL BE AT THE DEVELOPER OR ENGINEERS EXPENSE
- 10. IF UNSAFE PRACTICES ARE DISCOVERED BY CWL DURING OUR INSPECTIONS OF WORKMANSHIP AND MATERIALS, CWL WILL NOTIFY THE OSHA. THIS IN NO WAY OBLIGATES CWL FOR THE RESPONSIBILITY OF THE CONTRACTORS SAFETY PRACTICES.



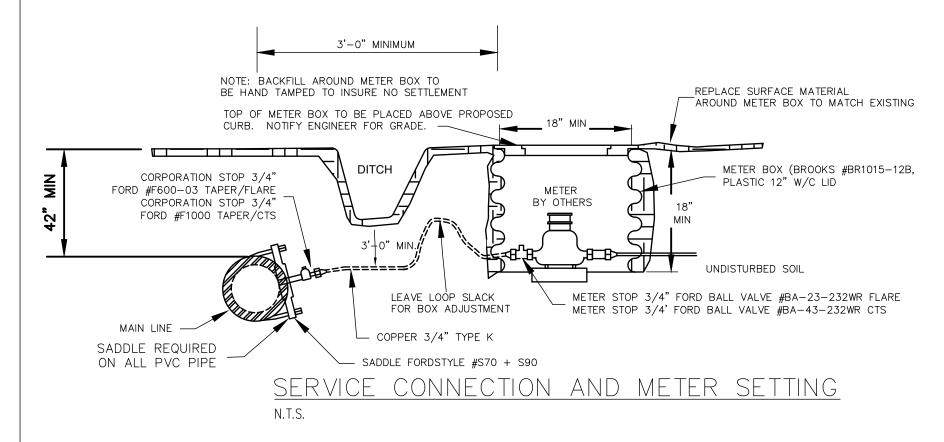

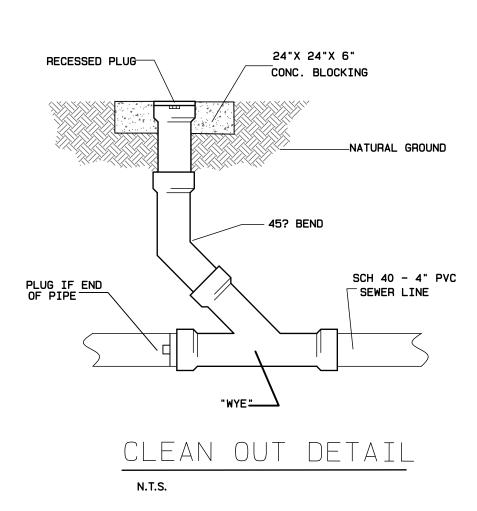

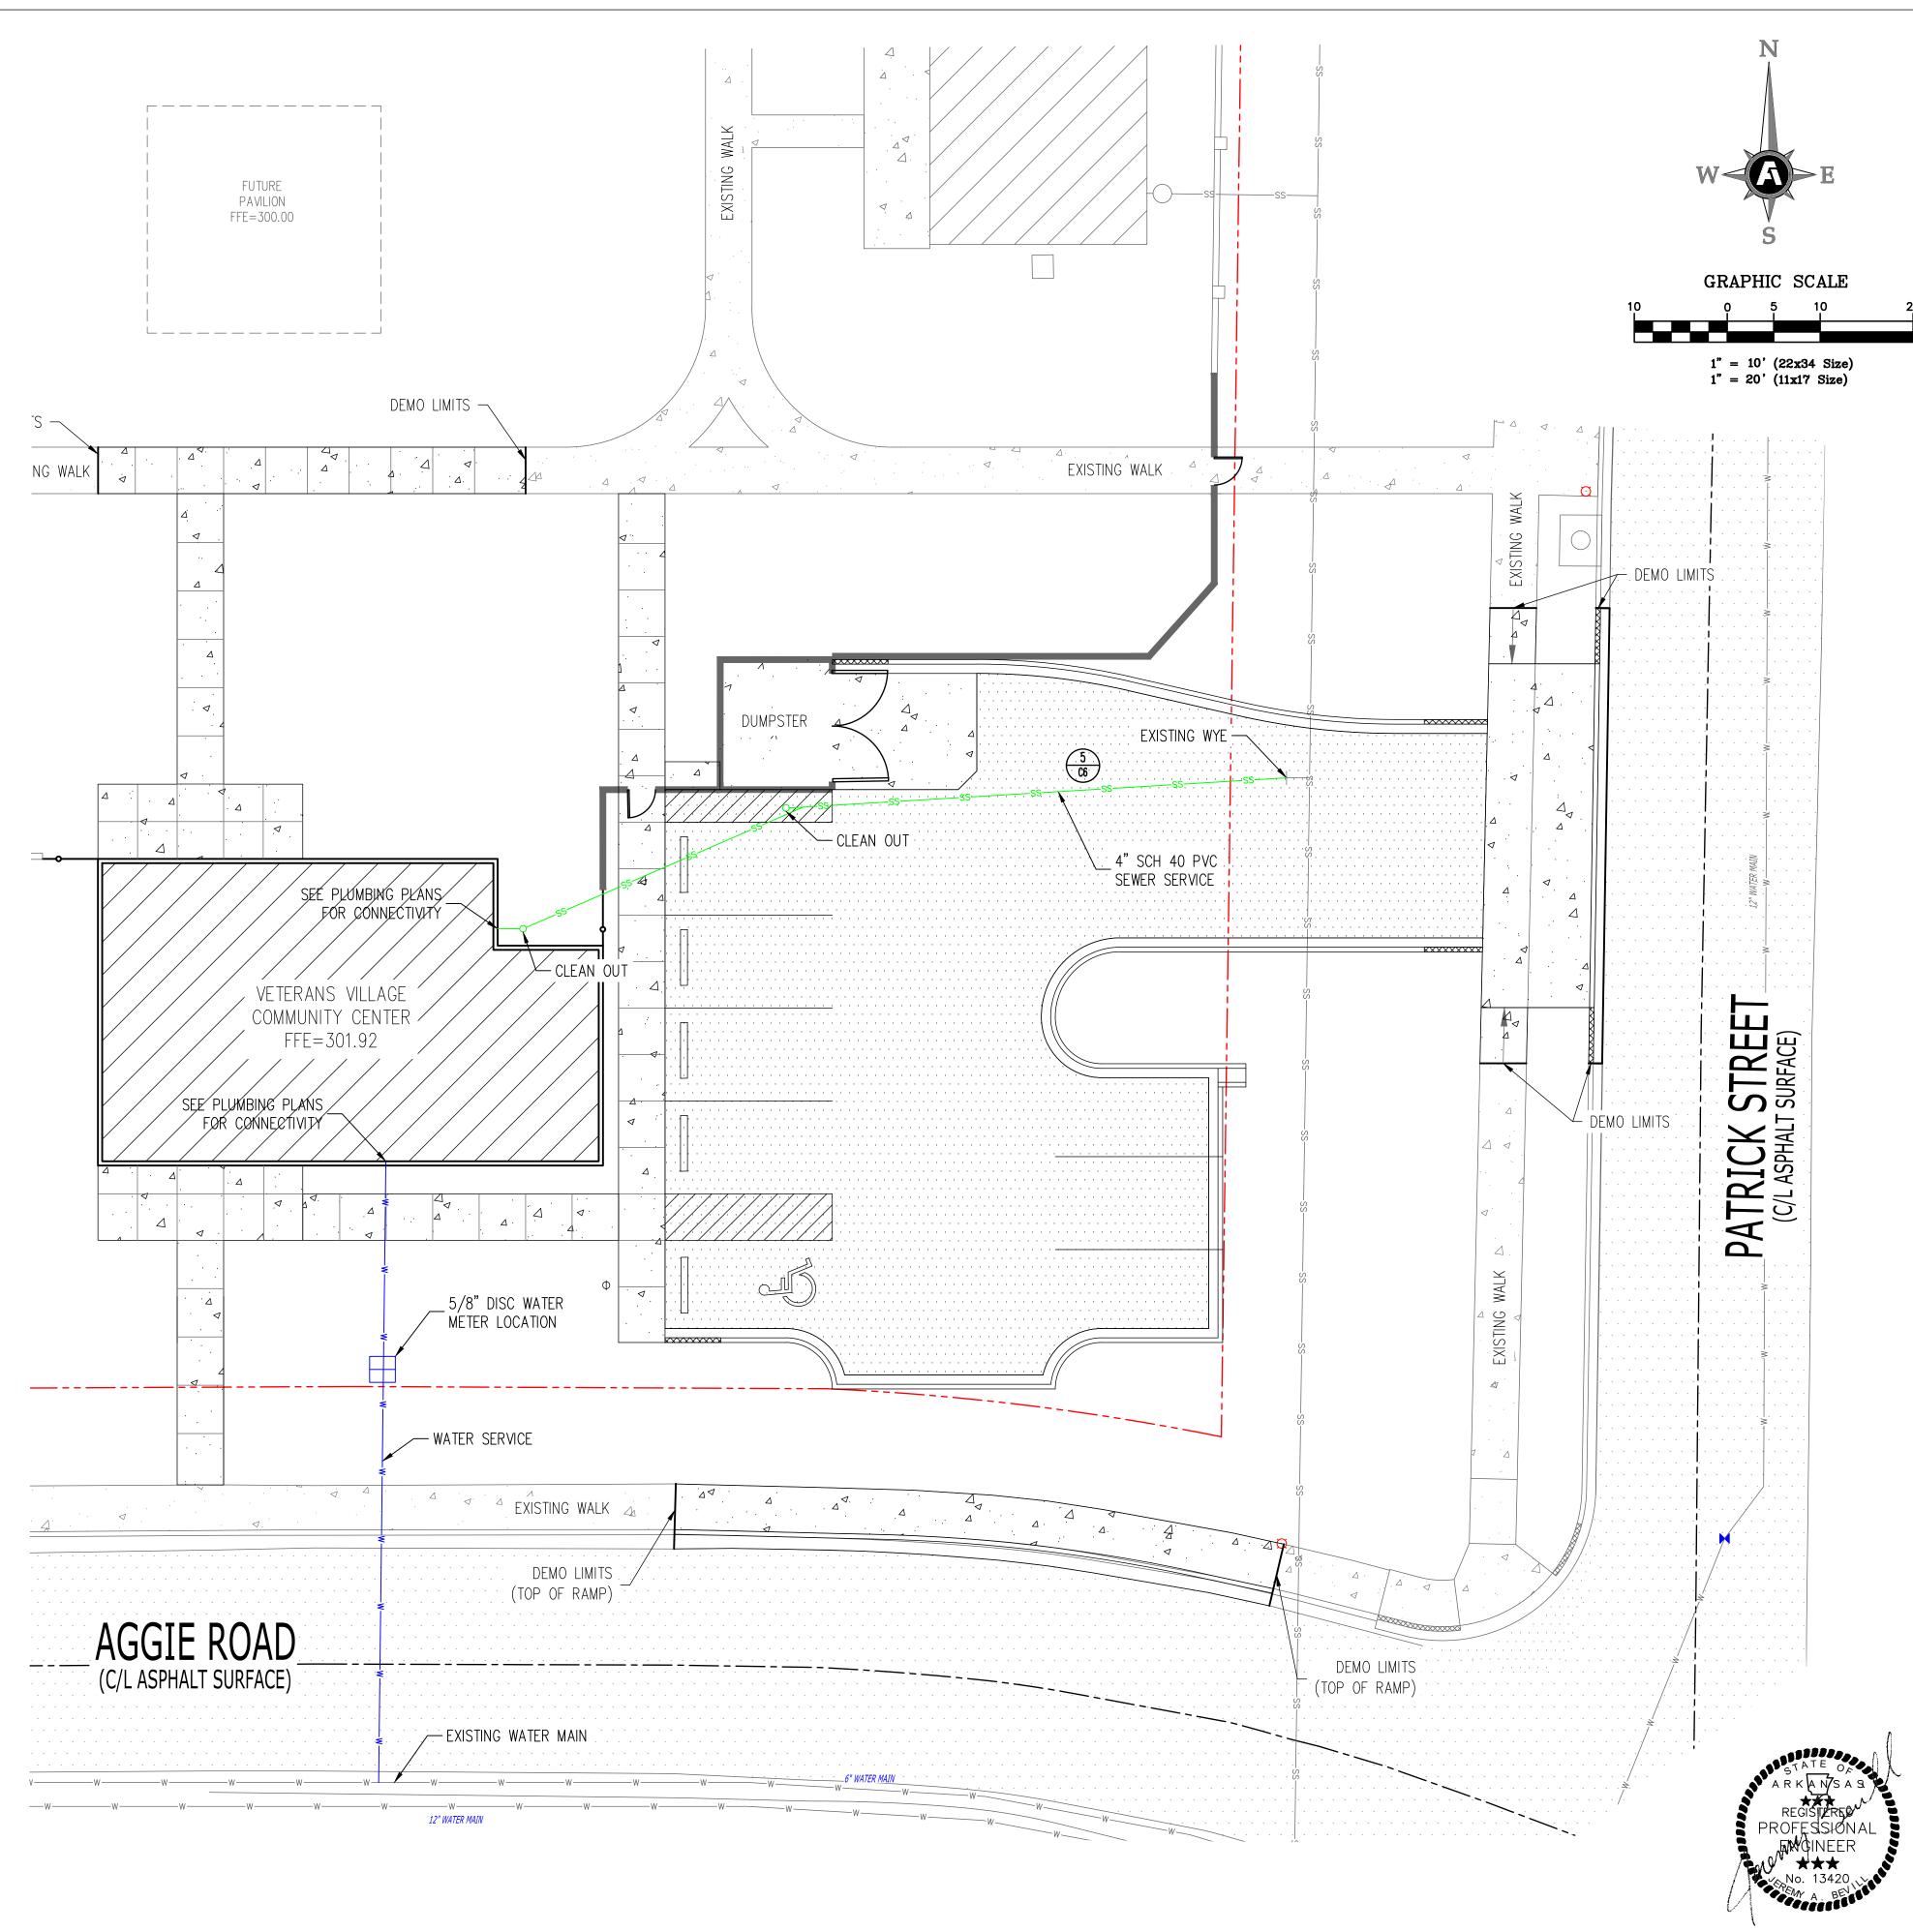

TERANS' VILLAGE COMMUNITY
CITY OF JONESB

BL

FISHER & ARNOLD INC.

No. 248

No. 248

TOOPER MIXON
A R C H I T E C T S

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CONSTRUCTION DOCUMENTS

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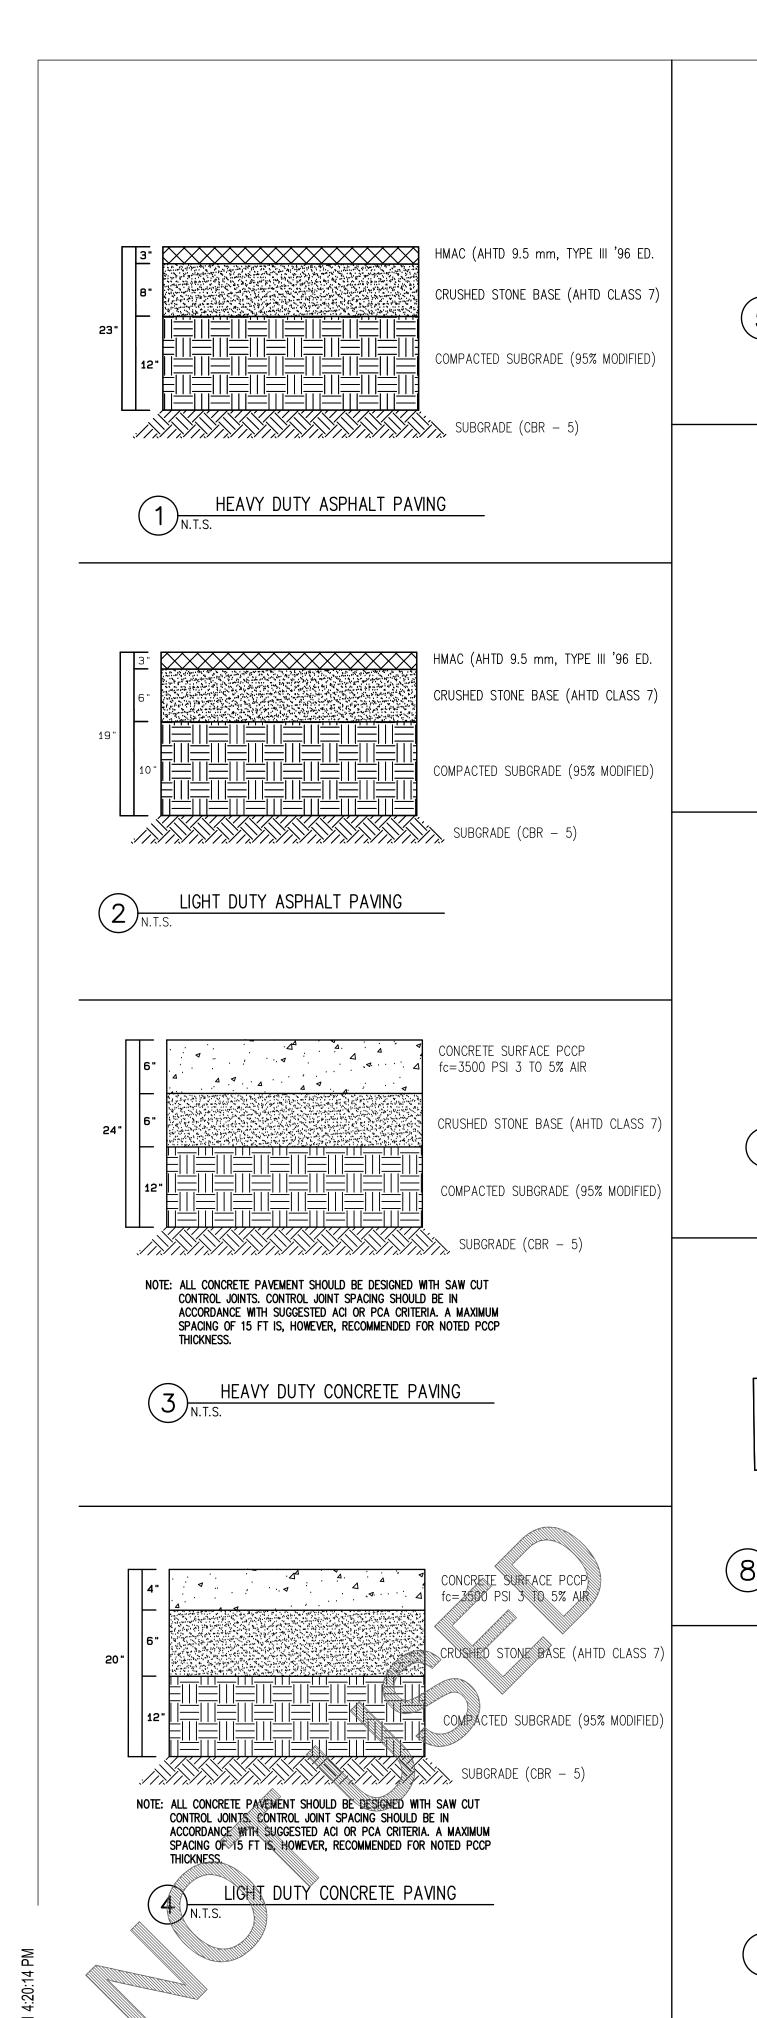
2021-01-03


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UTILITY PLAN

SHEET NUMBER

C4



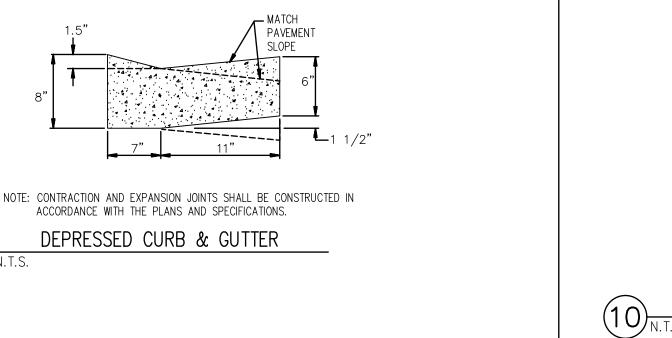

PAVEMENT

60'-0" O.C. MAX.

EXPANSION JOINT (EJ)

- LEVEL LANDING SLOPE

SEE PLANS 1'-0"

SIDEWALK

SEE PLANS

L SIDEWALK RAMP CROSS-SLOPE 50:1 MAX. (2.0%) TYP.

-MAX. SLOP# 1/4"/FT.

P.S.I. CONCRETE

- 95% MODIFIED SUBGRADE

50:1 MAX. (2.0%) IN ALL DIRECTIONS

SLOPE

TYPE "A" (BARRIER) RESIDENTIAL & COLLECTOR STREETS

NOTE: CONTRACTION AND EXPANSION JOINTS SHALL BE CONSTRUCTED IN

ACCORDANCE WITH THE PLANS AND SPECIFICATIONS.

BARRIER TYPE CURB & GUTTER

AT INTERVALS

WALK WIDTH. SAW CUT CURB

JOINT ON 15'

NOTE: PROVIDE EXPANSION JOINT WHERE CURB ABUTTS STRUCTURES. PROVIDE EXPANSION JOINT WHERE SIDEWALK ABUTTS CURB AND NEXT

INTERVALS

JOINTS FOR CURB & WALKS

SIDEWALK RAMP DETAIL

CURB (TYP.)

4" SIDEWALK CROSS SECTION

CONTRACTION JOINT (CJ)

CURB AS REQUIRED -


6X6 WELDED WIRE SHEET MESH


INSTALL MID SLAB W/ CHAIRS


SEE PLANS


USE SELF LEVELING SEALANT ON ALL JOINTS


6" TYPICAL UNLESS . 5"

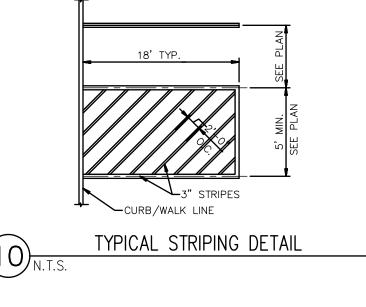

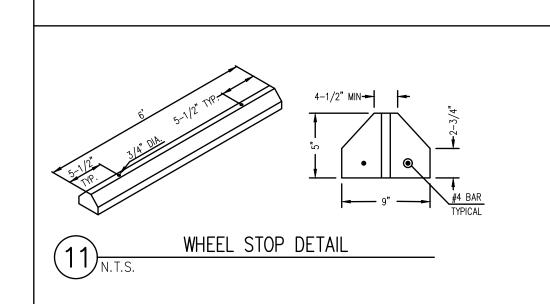


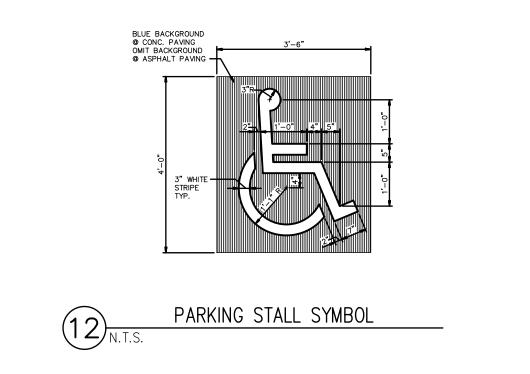

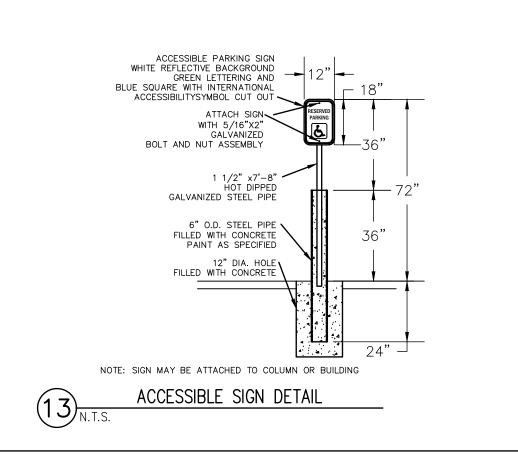

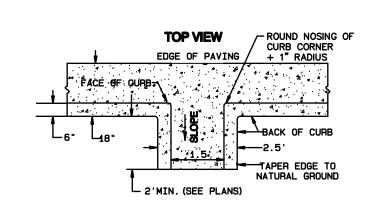


FLUME / CURB CUT DETAIL

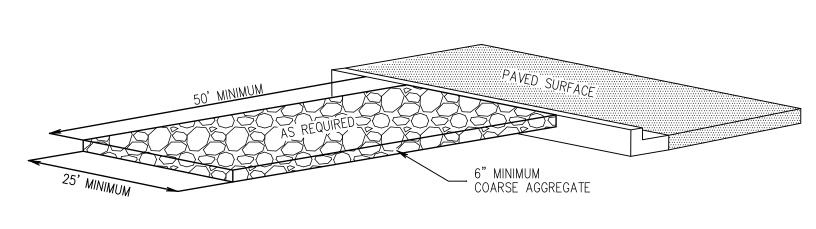



STAKE

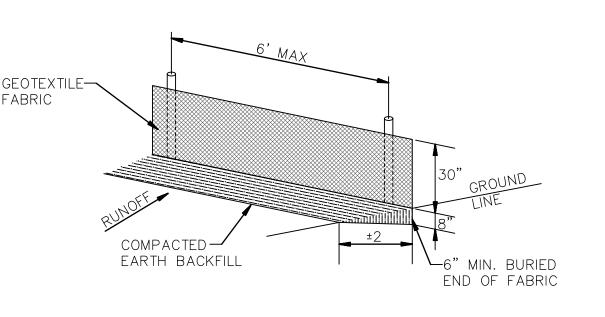

GEOTEXTILE FABRIC SHALL BE SPLICED TOGETHER WITH A SEWN SEAM ONLY AT A SUPPORT POST, OR TWO SECTIONS OF FENCE MAY BE OVERLAPPED INSTEAD. PAYMENT OF ADDITIONAL MATERIAL FOR

WOVEN GEOTEXTILE ~

(TYP.)

SUBGRADE

ANCHOR TRENCH


1. GEOTEXTILE ANCHORED IN TRENCH A MINIMUM OF 15 CM (6 IN).


DEPENDING UPON CONFIGURATION, ATTACH GEOTEXTILE TO STEEL

TRENCH BACKFILLED WITH TAMPED NATURAL SOIL.

POST WITH TIE WIRES OR WOOD POSTS WITH STAPLES.

OVERLAP WILL NOT BE MADE.

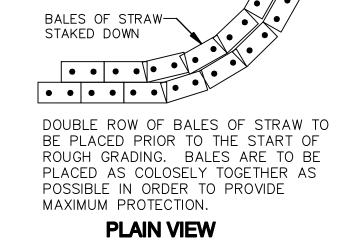

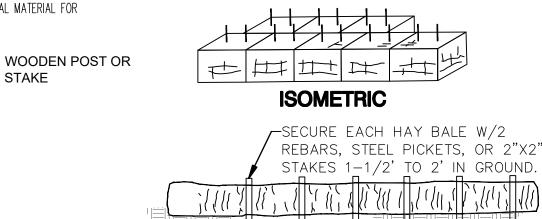




WIRE OR NYLON BOUND BALES ARE REQUIRED FOR DURABILITY.

REQUIRED AT LOW AREAS OF SITE WHERE SURFACE DRAINAGE OCCURES DURING GRADING OPERATIONS & PRIOR TO LANDSCAPING COMPLETION.


STRAW BALE DETAILS


SILT FENCE DETAIL

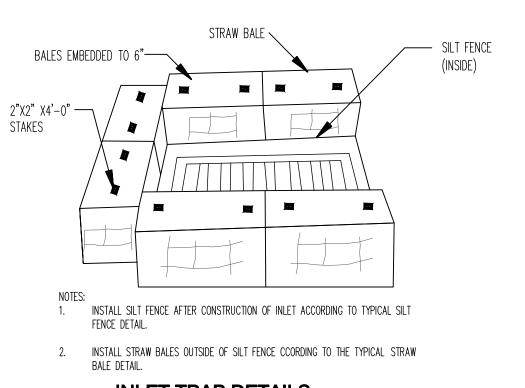

INLET TRAP DETAILS

EROSION CONTROL DETAILS

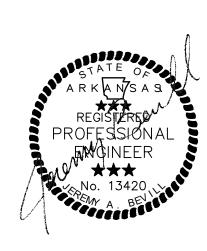

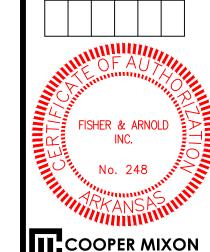

BL

NOMMO

TERAN

COOPER MIXON 505 union street, 2nd flr jonesboro, ar 72401 phone 870.336.0536 www.coopermixon.com

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PROJECT NO.


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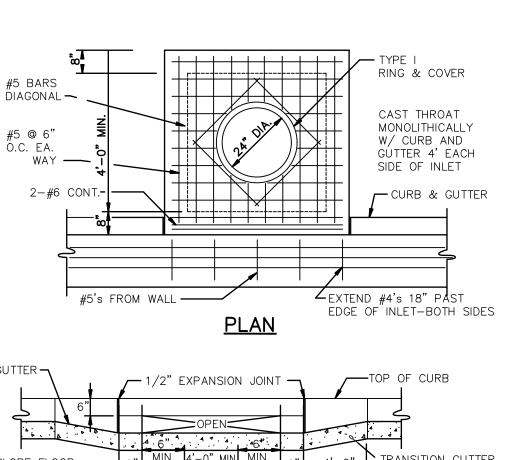
VETERANS' VILLAGE COMMUNITY BLDG


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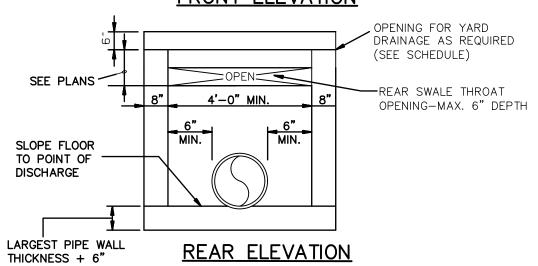
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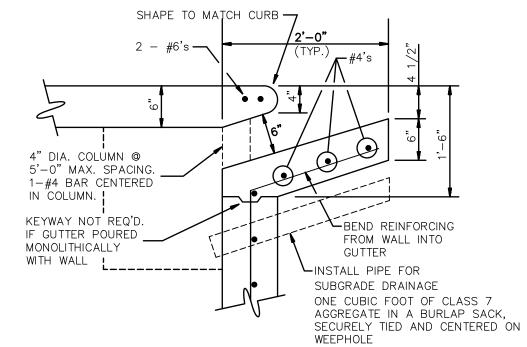
DETAILS








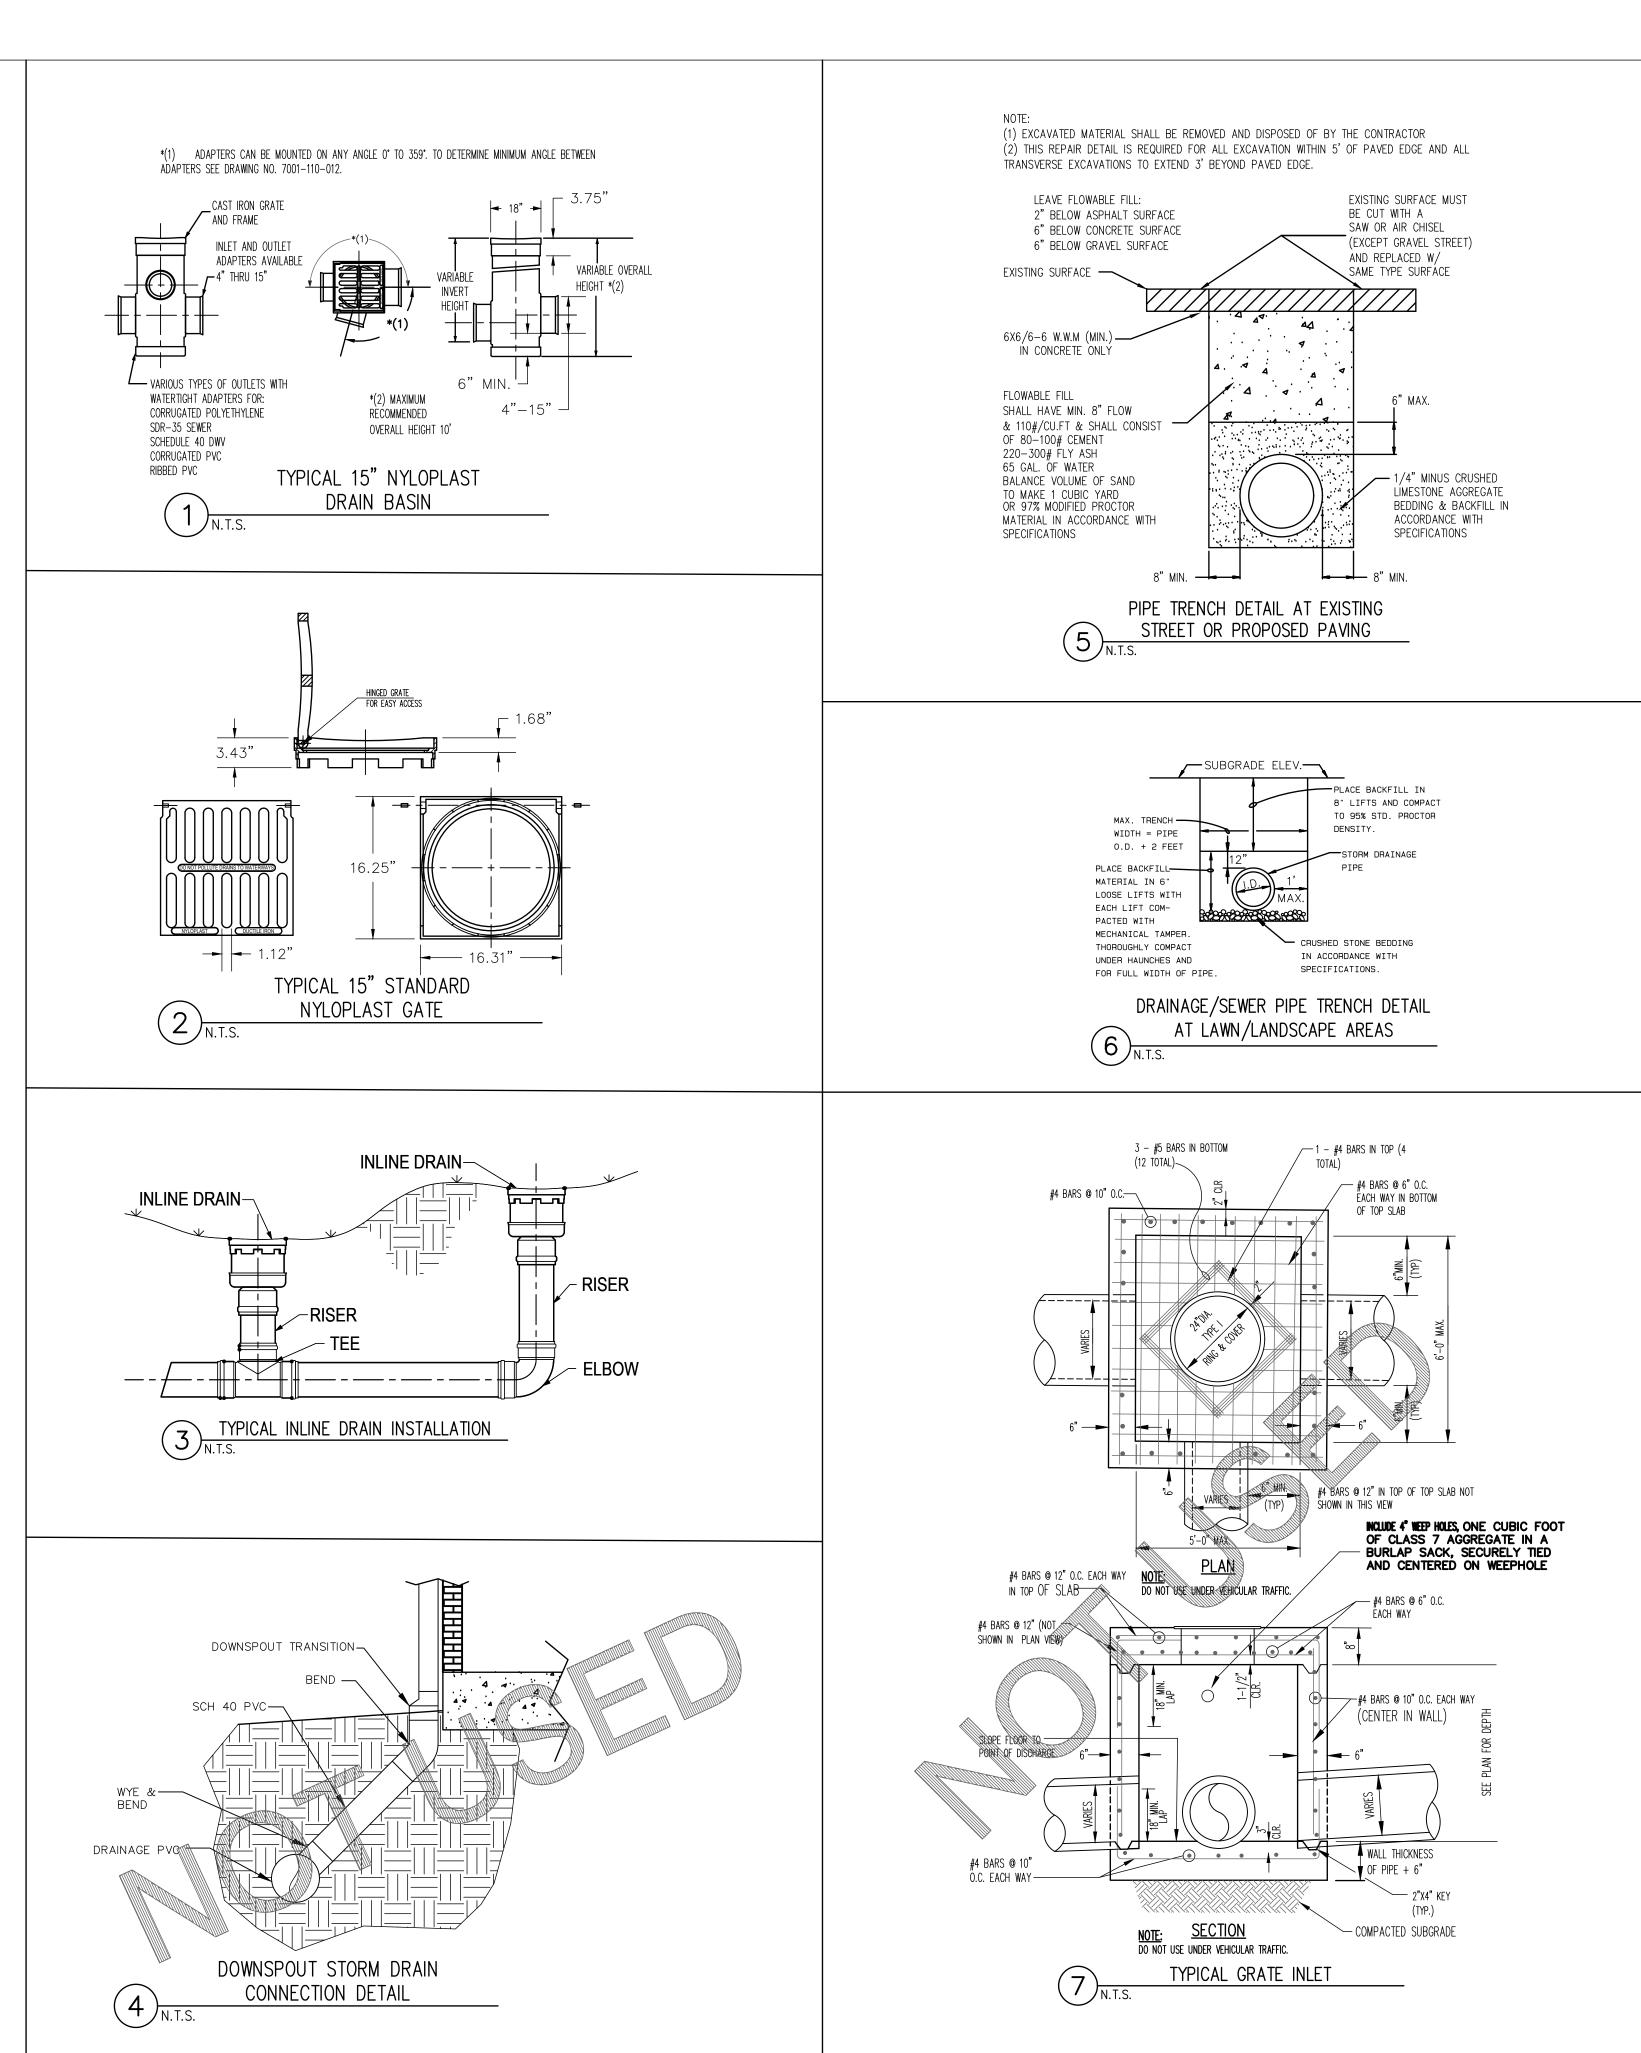

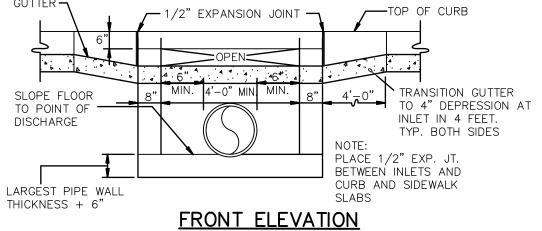



SECTION - CURB OPENING

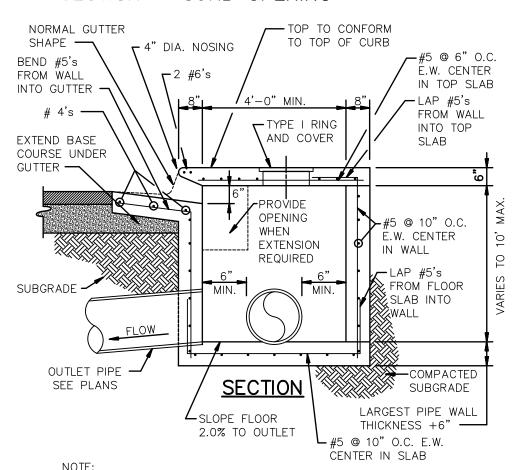

NOIE:
INLETS MORE THAN 3'-0" DEEP SHALL HAVE STANDARD MANHOLE
STEPS PLACED AT 15" O.C. — MANHOLE FRAME AND COVER SHALL
BE PLACED ADJACENT TO THE WALL WITH THE STEPS.



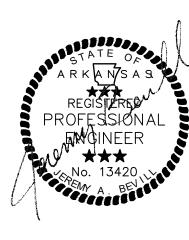

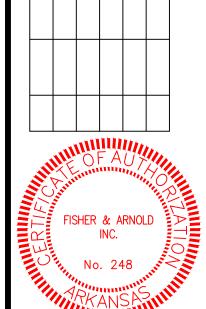

COPER MIXON

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CONSTRUCTION DETAILS

SHEET NUMBER

C6

PROPERTY OWNER: CITY OF JONESBORG 300 S CHURCH STREE JONESBORO, AR 72401 PHONE: 870.336.7229

COOPER MIXON ARCHITECTS 505 UNION STREET, SECOND FLOOR JONESBORO, AR 72401 PHONE: 870.336.0536

CONTACT: JOHN MIXON

CIVIL ENGINEER FISHER ARNOLD 1801 LATOURETTE DR JONESBORO, AR 72404 PHONE: 870.932.1076

CONTACT: REGINA BURKETT, COMMUNITY DEVELOPMENT DIRECTOR

CONTACT: JASON MACDONALD

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CIVIL	
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C3	EROSION CONTROL PLAN
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A6.0	INTERIOR ELEVATIONS
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A8.0	SECTIONS

GENERAL NOTES

- 1. FIELD VERIFY ALL MEASUREMENTS REQUIRED. USE DIMENSIONS SHOWN ON DRAWINGS AND ACTUAL FIELD MEASUREMENTS. DO NOT SCALE DRAWINGS. VERIFY ALL DIMENSIONS AND CONDITIONS AND NOTIFY ARCHITECT OF ANY DISCREPANCIES IN WRITING BEFORE PROCEEDING WITH WORK.
- 2. PRIOR TO THE SUBMISSION OF BIDS, THE CONTRACTOR SHALL VISIT THE SITE AND BE RESPONSIBLE FOR COORDINATING THE EXISTING CONDITIONS WITH THE WORK SPECIFIED IN THE CONTRACT DOCUMENTS, TO CONFIRM THAT THE INTENT OF THE CONTRACT DOCUMENTS CAN BE FULFILLED. NOTIFY THE ARCHITECT IN WRITING OF ALL
- 3. CONTRACTOR SHALL RECEIVE IN WRITING, AUTHORIZATION TO PROCEED BEFORE STARTING ANY WORK THAT IS NOT CLEARLY DEFINED BY THE CONTRACT DOCUMENTS.
- 4. CONTRACTORS SHALL INSTALL ALL EQUIPMENT AND MATERIALS IN ACCORDANCE WITH MANUFACTURERS RECOMMENDATIONS UNLESS SPECIFICALLY, OR OTHERWISE INDICATED, OR WHERE APPLICABLE CODES OR
- 5. ALL WORK PERFORMED AND MATERIALS INSTALLED SHALL BE IN STRICT ACCORDANCE WITH ALL APPLICABLE CODES, REGULATIONS AND ORDINANCES. CONTRACTOR SHALL GIVE NOTICES AND COMPLY WITH ALL LAWS, ORDINANCES RULE, REGULATIONS AND LAWFUL ORDERS OF ANY PUBLIC AUTHORITY BEARING ON PERFORMANCE OF THE WORK. MECHANICAL, ELECTRICAL SYSTEMS SHALL BE INSTALLED IN ACCORDANCE WITH ALL APPLICABLE MUNICIPAL AND UTILITY COMPANY SPECIFICATIONS, LOCAL AND STATE JURISDICTIONS, ORDINANCES, AND APPLICABLE REGULATIONS.
- GENERAL CONTRACTOR OR CONSTRUCTION MANAGER SHALL SUPERVISE, AND DIRECT THE WORK. CONTRACTORS SHALL BE SOLELY RESPONSIBLE FOR ALL CONSTRUCTION MEANS, METHODS, TECHNIQUES, SEQUENCES AND PROCEDURES FOR COORDINATING ALL PORTIONS OF THE WORK UNDER THE CONTRACT. INCLUDING CONTRACT AND COORDINATION WITH ALL AUTHORIZED OWNER REPRESENTATIVES.
- 7. DETAILS ARE INTENDED TO SHOW THE END RESULT OF THE DESIGN AND PERFORMANCE, MINOR MODIFICATIONS MAY BE REQUIRED TO SUIT EXISTING CONDITIONS. SUCH MODIFICATIONS SHALL BE INCLUDED AS PART OF THE
- 8. CONTRACTORS SHALL VERIFY LOCATIONS OF ALL UTILITIES AND SERVICES PRIOR TO PROCEEDING WITH THE WORK TO ENSURE PROPER COORDINATION, SEQUENCING AND INSTALLATION OF NEW WORK.
- 9. PROVIDE FIRE SEALANT TO PERIMETER OF ALL PIPING, HVAC SLEEVING OR OTHER TYPE OF THRU-WALL PENETRATION.
- 10. NOTIFY ARCHITECT IMMEDIATELY OF ANY UNFORESEEN CONDITIONS FOR DIRECTION BEFORE PROCEEDING WITH
- 11. PAINT ALL EXPOSED SURFACES, EXCEPT WHERE ITEMS ARE SCHEDULED TO REMAIN NATURAL OR ARE OTHERWISE RESTRICTED BY LOCAL CODES, ORDINANCES OR AUTHORITIES HAVING JURISDICTION
- 12. COORDINATE/VERIFY WITH ARCHITECT EXTERIOR LIGHTING MOUNTING HEIGHTS.

PROJECT ABBREVIATIONS

PER SQUARE INCH

PLATE LINE

REFERENCE SYMBOLS

LINEAR DIMENSION

REVISION BUBBLE

COLUMN GRID & BUBBLE

PARTITION TYPE

BREAK LINE

CEILING TAG

ROOM TAG

F.E.C. F.H.C. FLASH FLR FLCO F.D. FLOUR FT FTG FDN ABV A.F.F. ACOUS A/C ALT ABOVE FINISH FLOOR ACOUSTICAL FLOOR (ING) FLOOR CLEANOUT ALTERNATE ALUMINUM ANCHOR BOLT FLOOR DRAIN FLUORESCENT ALUM A.B. FOOT OR FEET @ APPROX ARCH A.D. A.C. ASPH APPROXIMATE FOUNDATION ARCHITECTURE (URAL) GALV
GA
G.C.
GLS
GLS BLK
GLB
G.B.
GR
GND
GYP BD AREA DRAIN ASPHALT CONCRETE GALVANIZED GENERAL CONTRACTOR GLASS BLOCK BM BLW B.G. B.M. BLK BLKG BD B.O.B. BOT BLDG B.U.R. GLUE LAM BEAM GRAB BAR GRADE, GRADING GROUND GYPSUM BOARD BOARD BOTTOM OF BEAM HC HDW HDR HVAC HANDICAPPED **BUILT-UP ROOFING** HEATING/VENTILATION CABINET COLD FORMED METAL STUD H.C. H.M. or HM HORIZ H.B. HR HOLLOW CORE HOLLOW METAL CENTER
CENTER LINE
CEMENT
CLEAR
CLOSET
CLEAN OUT HOSE BIBB INCL INFO I.D. INSUL INT INSTALL INFORMATION INSIDE DIAMETER
INSULATE, INSULATION COLUMN COMBINATION CONCRETE INTERIOR INSTALLATION CONCRETE MASONRY UNIT CONSTRUCTION CONTINUOUS (ATION) CONTRACTOR KNOCKOUT KO KPLT KICKPLATE CONTROL JOINT L.B. LAM LT LWC LVR LAG BOLT COUNTERSINK CUBIC FOOT LIGHTWEIGHT CONCRETE DEMOLITION MATL MGMT MFG MAS M.O. MAT MH MAX MECH MBR MEMB MTL MIN MISC MATERIAL MANAGEMENT MANUFACTURER DIAGUNAL
DIAMETER
DIMENSION
DISPENSER
DOOR
DOUBLE
DOWN
DOWN SPOUT MASONRY MASONRY OPENING MATERIAL MANHOLE MAXIMUM MECHANICAL MEMBER MEMBRANE MINIMUM MISCELLANEOUS (N) NOM ELECTRIC (AL NORTH NOT IN CONTRACT NOT TO SCALE N N.I.C. N.T.S. NO. ENCLOSE (URE) END NAILING EQUAL EQUIPMENT ON CENTER OPAQUE EXISTING EXPANSION JOINT OPENING OUTSIDE DIAMETER F.O.C. F.O.F. F.O.M. F.O.S. FGLS F.N. FIN F.G. F.F. F.F.E. FACE OF CONCRETE (CURB FACE OF FINISH FACE OF MASONRY FACE OF STUB d P.C.F. P.L.F. P.S.F. P.S.I. PENNY PER CUBIC FOOT FIELD NAILING PER LINEAL FOOT

FINISH GRADE FINISH FLOOR FINISH FLOOR ELEVATION

1 1/2"

ROOM NAME

Χ

(XXX)

WINDOW TYPE

DOOR TAG

FIRE ALARM
FIRE EXTINGUISHER

PLATE GLASS PLYWOOD POWER POLE POLYVINYL CHLORIDE PRE-CAST CONCRETE PRE-ENGINEERED
METAL BUILDING PRESSURE TREATED DOUGLAS FIR PROPERTY LINE QUARRY TILE REDWOOD REFERENCE REINFORCE (D) (ING) RETURN AIR REV REQD R.O.W. REVISION REQUIRED (ING) RIGHT OF WAY ROOF DRAIN ROUGH OPENING SCHEDULE SOLID CORE SPECIFICATIONS STAINLESS STEEL STORM DRAIN STRUCTURAL STRUCT SUSPENDED SUBCONTRACTOR TELEPHONE TEMPORARY TONGUE AND GROOVE TOP OF BEAM TOP OF CURB T.O.L. T.O.P. T.O.P. T.O.PL. T.O.S. T.O.T. T.O.W. TOP OF PAVEMENT TOP OF SLAB TOP OF TRUSS TOP OF WALL TREAD TYPICAL UNDERGROUND UNFINISHED
UNLESS NOTED OTHERWISE URINAL UTILITIES VAPOR BARRIER VERTICAL

VESTIBULE VINYL BASE WALL HUNG WALL TO WALL W TO W WATER CLOSET WATER HEATER WATERPROOF WATER RESISTANT W.W.M.

WELDED WIRE MESH WINDOW WOOD BASE WROUGHT IRON

INTERIOR ELEVATION

EXTERIOR ELEVATION

BUILDING SECTION

WALL SECTION

ELEVATION MARK

NORTH ARROW

DRAWING TITLE

BACK REF.

X VIEW TITLE
SCALE

DETAIL

CERTIFICATION

I HEREBY CERTIFY THAT THESE PLANS AND SPECIFICATIONS HAVE BEEN PREPARED BY ME, OR UNDER MY SUPERVISION. I FURTHER CERTIFY THAT TO THE BEST OF MY KNOWLEDGE THESE PLANS AND SPECIFICATIONS ARE AS REQUIRED BY LAW AND IN COMPLIANCE WITH

GYP. BD.

INSULATION

INSULATION

PLYWOOD

PLASTER ON


MTL. LATH


GROUT, OR

MATERIALS LEGEND

CONCRETE


SITE LOCATION

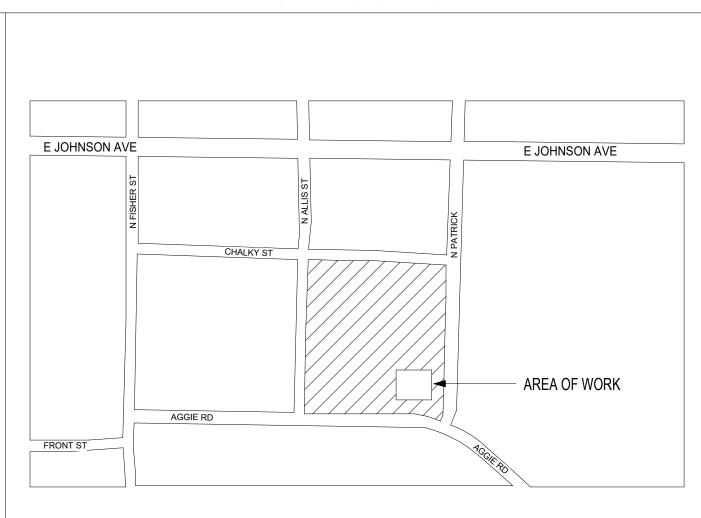

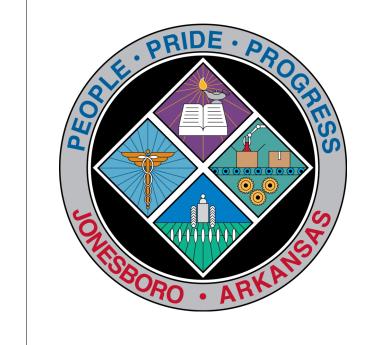

VETERANS' VILLAGE COMMUNITY CENTER

CITY OF JONESBORO, ARKANSAS

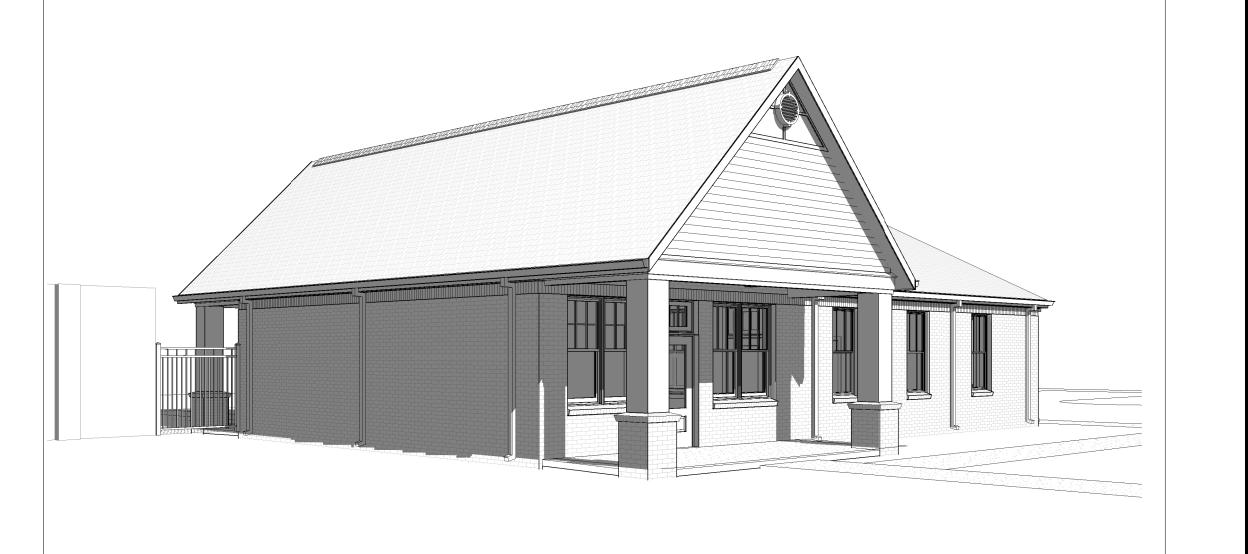

THE ARKANSAS FIRE PREVENTION CODE FOR THE STATE OF ARKANSAS.

JOHN MIXON, ARCHITECT

COOPER MIXON 505 union street, 2nd flr jonesboro, ar 72401 phone 870.336.0536 www.coopermixon.com CONSTRUCTION

PROJECT NO.

DOCUMENTS

 \Box

OMMUNI

VETERANS

PROJECT NAME

VETERANS' VILLAGE COMMUNITY BLDG

DATE 2021-01-03

CONTENTS PROJECT TEAM, GENERAL NOTES, DRAWING INDEX MATERIAL LEGEND

EXIT DOOR DESIGNED FOR 46 OCCUPANTS LIVING ROOM OFFICE 2 COMMUNITY BUSINESS CENTER 102 OFFICE 1 66' TRAVEL DISTANCE DOOR DESIGNED FOR 24 OCCUPANTS EXIT DOOR DESIGNED FOR 70 OCCUPANTS

2 LIFE SAFETY PLAN - OCCUPANCY AND EGRESS
1/8" = 1'-0" 4 / A0.0

Rentable Area Legend

ASSEMBLY (CHAIRS ONLY NOT FIXED)


BUSINESS AREA

CLASSROOM AREA


EXCLUDED



	OCCUI	PANCY LOAD CALCULATION		
#	FUNCTION OF SPACE	AREA	LOAD FACTOR	OCCUPANT LOAD
		·	·	
	ASSEMBLY (CHAIRS ONLY NOT FIXED)	632 SF	7 NET	91
	EXCLUDED	110 SF	N/A	0
	CLASSROOM AREA	366 SF	20 NET	19
	BUSINESS AREA	247 SF	100 GROSS	3
	BUSINESS AREA	180 SF	100 GROSS	2
TAL OCCL	JPANCY LOAD	,	,	115

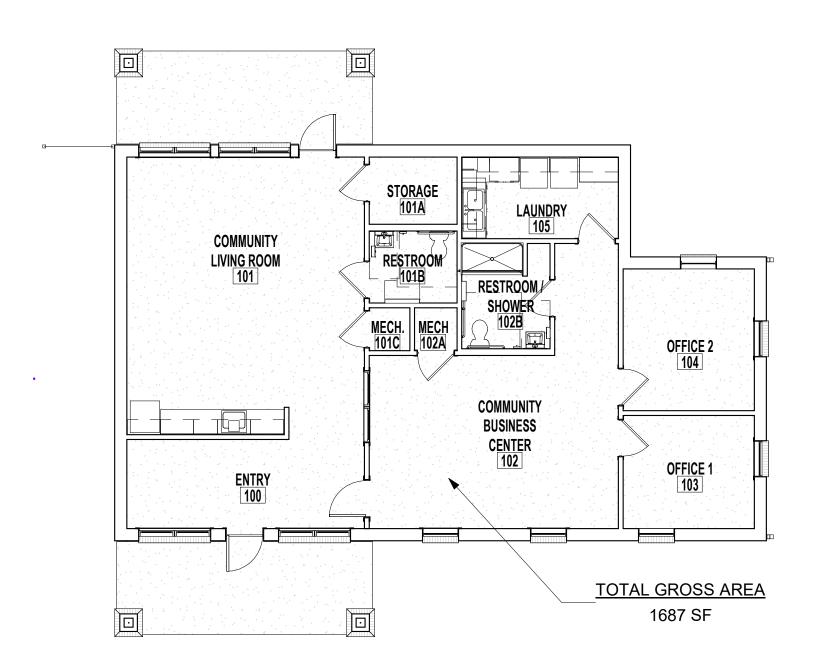



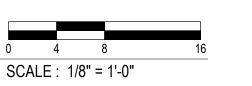



AUTHORITY HAVING JURISDICTION

CITY OF JONESBORO ARKANSAS

ADOPTED CODES

2012 International Building Codes 2012 Existing Building Code 2012 Arkansas Fire Prevention Code Vol. I: Fire 2012 Arkansas Fire Prevention Code Vol. II: Building 2012 Arkansas Fire Prevention Code Vol. III: Residential 2014 Arkansas Energy Code (2009 IECC w/ supplements & amendments) 2010 AMC: Arkansas Mechanical Codes 2006 APC: Arkansas Plumbing Codes 2006 AFAG: Arkansas Fuel and Gas Codes 2003 ICC/ANSI A117.1: American National Standards(ADA requirements) 2010 ADA Standards for Accessibility

CODE STUDY

2017 NEC: National Electrical Codes

THE PROJECT IS THE NEW CONSTRUCTION OF A COMMUNITY SERVICES BUILDING FOR THE VETERANS' VILLAGE.

BUILDING USE OR OCCUPANCY

NON-SEPARATED MIXED OCCUPANCIES - ASSEMBLY GROUP A-3, BUSINESS GROUP B, AND EDUCATION GROUP E

GENERAL BUILDING HEIGHTS AND AREAS - BASED ON MOST RESTRICTIVE ASSEMBLY GROUP A-3					
TABLE 503	TABULAR ALLOWABLE AREA	6,000 SF			
	TABULAR ALLOWABLE STORIES	1			
	TABULAR ALLOWABLE HEIGHT	40			
ACTUAL AREA	GROSS SQUARE FEET	1,687 SF			
	WASHINGTON STREET LEVEL	2,757 SF			
ACTUAL STORIES		1			
ACTUAL HEIGHT		< 25'			

BUILDING CONSTRUCTION

CONSTRUCTION TYPE V-B NON SPRINKLED

FIRE RECICEAN	RE DATING REQUIREMENTS (URUSS)
I FIKE KESISTAN	CE RATING REQUIREMENTS (HOURS)
	······ ··· ··· ··· ··· ··· · · ··· · ·

TABLE 601	COMPONENT	RATING REQUIRED	RATING PROVIDED
	STRUCTURAL FRAME	0	0
	BEARING WALLS - EXTERIOR	0	0
	BEARING WALLS - INTERIOR	0	0
TABLE 602	NONBEARING WALLS & PARTITIONS - EXTERIOR	0	0
	NONBEARING WALLS & PARTITIONS - INTERIOR	0	0
	FLOOR CONSTRUCTION	0	0
	ROOF CONSTRUCTION	0	0

FIRE ALARM AND DETECTION SYSTEMS

NOT REQUIRED - OCCUPANT LOAD < 300

OCCUPANT LOAD CALCULATIONS - SEE OCCUPANCY LOAD CALCULATION TABLE

MEANS OF EGRESS

1005.1	MINIMUM REQUIRED EGRESS WIDTH	.3" PER OCCUPANT FOR STAIRWAYS, AND .2" PER OCCUPANT FOR OTHER EGRESS COMPONENTS					
	BUILDING AREA	OCCUPANCY	FACTOR	REQUIRED (IN)	PROVIDED (IN)		
	COMMUNITY BUSINESS CENTER DOOR	24	.2	4.8" (MIN 32")	36"		
	SOUTH EXIT DOOR	70	.2	14" (MIN 32")	36"		
	NORTH EXIT DOOR	46	.2	9.2" (MIN 32")	36"		
		REQUIRED		PROVIDED			
TABLE 1016.2	EXIT ACCESS TRAVEL DISTANCE	200' MAXIMUM APPROXIMATELY 66'					
TABLE 1021.2	MIN. NUMBER OF EXITS FOR OCCUPANT LOAD	2		2	2		

SCHEDULE OF SPECIAL INSPECTIONS SERVICES - PER CHAPTER 17 OF THE 2012 ARKANSAS FIRE PREVENTION CODE

<u>ACTIVITY</u>	EXTENT	<u>AGENT</u>
-----------------	---------------	--------------

1705.2 STEEL CONSTRUCTION

INSPECTION OF STEEL FRAME JOINT DETAILS FOR COMPLIANCE WITH APPROVED CONSTRUCTION DOCUMENTS

MATERIALS VERIFICATION OF COLD -FORMED STEEL DECK AND ATTACHMENTS.

1705.3 CONCRETE CONSTRUCTION

1. INSPECTION OF REINFORCING STEEL INSTALLATION

2.INSPECTION OF ANCHORS CAST IN CONCRETE WHERE ALLOWABLE LOADS HAVE BEEN INCREASED OR WHERE STRENGTH DESIGN IS USED.

3. INSPECTION OF ANCHORS POST - INSTALLED IN HARDENED CONCRETE 4. VERIFY USE OF REQUIRED DESIGN MIX. 5. AT THE TIME FRESH CONCRETE IS SAMPLED TO FABRICATE SPECIMENS

FOR STRENGTH TESTS, PERFORM SLUMP TEST AND AIR CONTENT TESTS, AND DETERMINE THE TEMPERATURE OF THE CONCRETE.

1705.6 SOILS

1. VERIFY MATERIALS BELOW SHALLOW FOUNDATIONS ARE ADEQUATE TO ACHIEVE THE DESIGN BEARING CAPACITY.

2. VERIFY EXCAVATIONS ARE EXTENDED TO PROPER DEPTH AND HAVE REACHED PROPER MATERIAL.

PERIODIC STRUCTURAL ENGINEER PERIODIC STRUCTURAL ENGINEER

PERIODIC STRUCTURAL ENGINEER.

PERIODIC STRUCTURAL ENGINEER

PERIODIC STRUCTURAL ENGINEER

PERIODIC STRUCTURAL ENGINEER CONTINUOUS TESTING AGENCY

PERIODIC GEOTECHNICAL ENGINEER

PERIODIC GEOTECHNICAL ENGINEER

SHEET NUMBER

图

OMMUNI

VETERANS

2027-01-03

COOPER MIXON
A R C H I T E C T S

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CONSTRUCTION

DOCUMENTS

PROJECT NO.

PROJECT NAME

VETERANS' VILLAGE


COMMUNITY BLDG

DATE

2021-01-03

CONTENTS

LIFE SAFETY

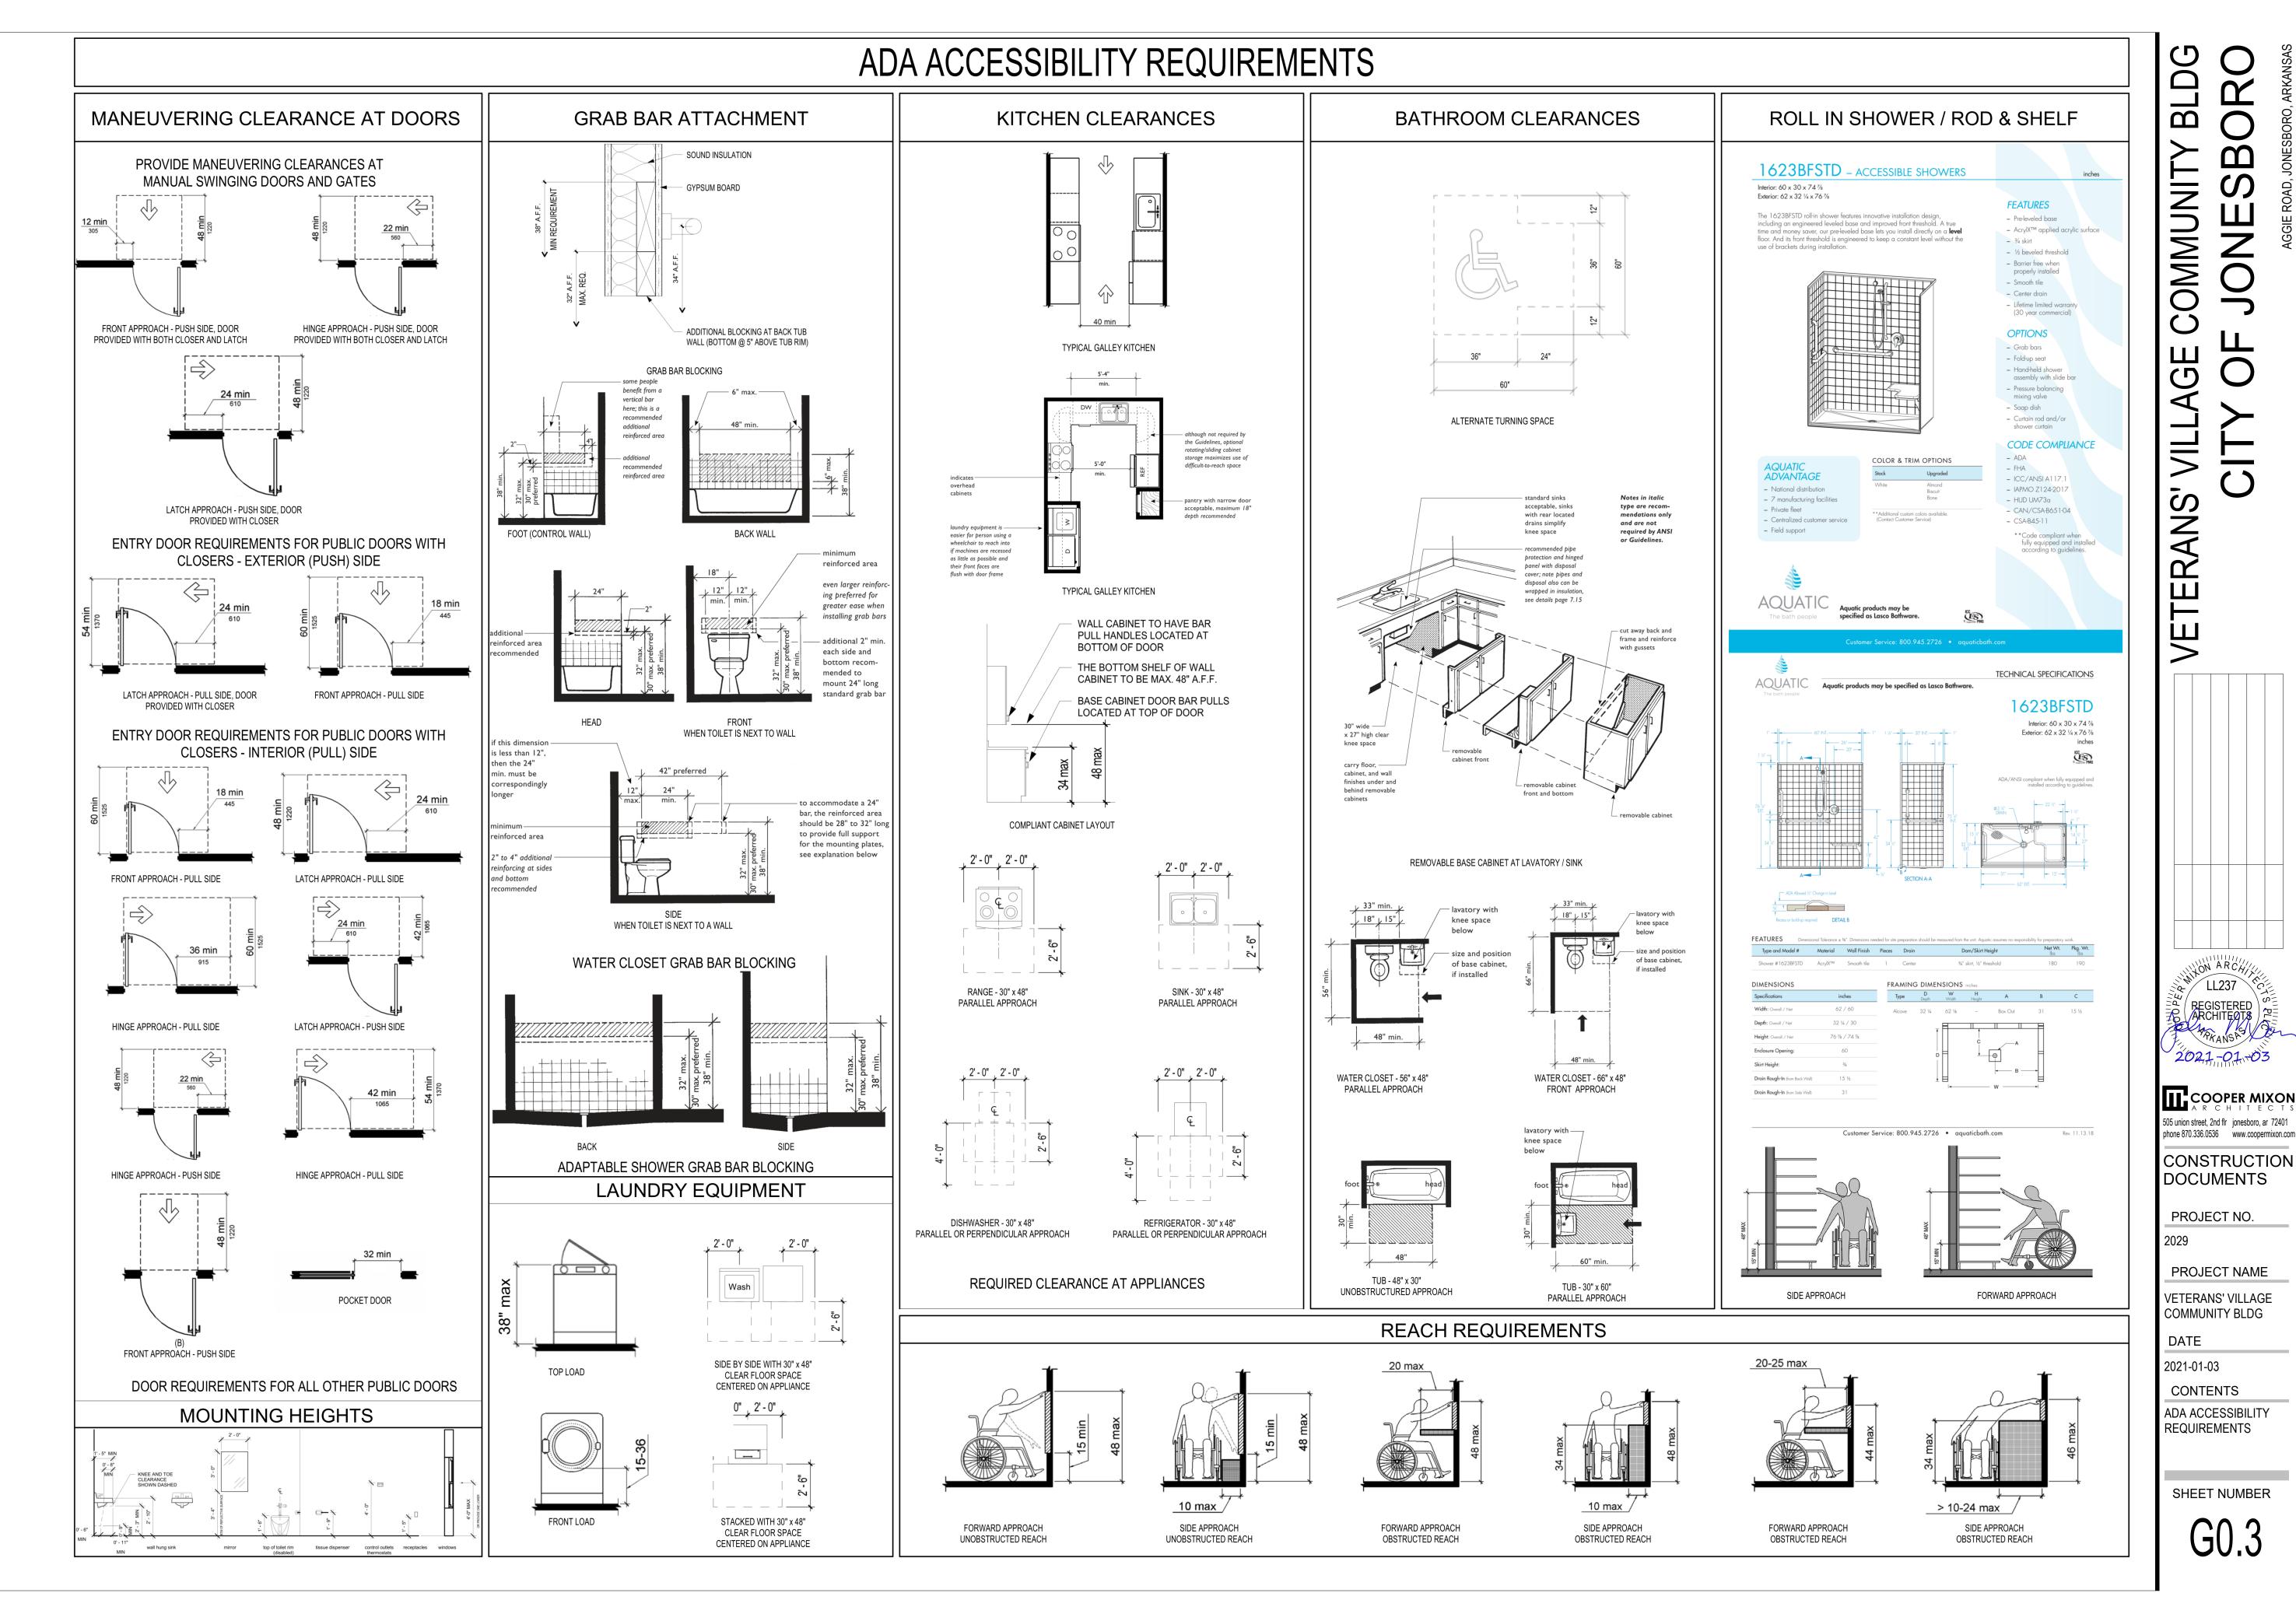

GENERAL NOTES:

A. SPECIAL INSPECTIONS:

- ALL SPECIAL INSPECTIONS AND TESTS REQUIRED IN ACCORDANCE WITH CHAPTER 17 OF THE INTERNATIONAL BUILDING CODE SHALL BE PERFORMED BY A QUALIFIED INSPECTOR.
- A COPY OF ALL SPECIAL INSPECTION REPORTS SHALL BE PROVIDED TO THE STRUCTURAL ENGINEER OF RECORD

GENERAL:

- CONTRACTOR SHALL COMPLY WITH ALL HEALTH AND SAFETY REGULATIONS SET FORTH BY THE OCCUPATIONAL SAFETY AND HEALTH ADMINISTRATION (OSHA) DURING CONSTRUCTION
- CONTRACTOR SHALL FIELD VERIFY ALL RELEVANT EXISTING CONDITIONS PRIOR TO BEGINNING CONSTRUCTION. CONTRACTOR SHALL NOTIFY THE OWNER'S REPRESENTATIVE OF ANY SIGNIFICANT VARIANCE FROM THESE DRAWINGS OR INTERFERENCES
- CONTRACTOR SHALL LOCATE ALL EXISTING UTILITIES PRIOR TO CONSTRUCTION. ALL UNDERGROUND UTILITIES MAY NOT BE SHOWN IN THESE DRAWINGS. CONTRACTOR SHALL NOTIFY THE OWNER'S REPRESENTATIVE OF ANY UNIDENTIFIED UTILITIES ENCOUNTERED.
- THE STRUCTURE SHOWN IN THESE DRAWINGS HAS ONLY BEEN DESIGN FOR THE PRESCRIBED LOADS AS A COMPLETED STRUCTURE. THE CONTRACTOR SHALL BE RESPONSIBLE FOR THE DESIGN AND USAGE OF ADEQUATE SHORING, BRACING, FORMWORK, AND OTHER SUPPORTING ELEMENTS AS REQUIRED FOR CONSTRUCTION.
- CONTRACTOR SHALL COORDINATE WORK FROM ALL DISCIPLINES AS REQUIRED.
- ANY CONFLICTS OR CONTRADICTIONS BETWEEN DIFFERENT DETAILS WITHIN THESE DRAWINGS OR SPECIFICATIONS SHALL BE IMMEDIATELY BROUGHT TO THE ATTENTION OF THE OWNER'S REPRESENTATIVE FOR CLARIFICATION/RESOLUTION.

C. EARTHWORK:

- ALL SITE WORK SHALL BE PERFORMED IN ACCORDANCE WITH THESE NOTES AND COORDINATED WITH THE APPLICABLE GEOTECHNICAL REPORT. THE GEOTECHNICAL REPORT SHALL CONTROL WHEN IT REQUIRES MORE STRINGENT PROCEDURES.
- FOUNDATIONS ARE DESIGNED BASED ON AN ALLOWABLE BEARING CAPACITY OF 2000PSF. BEARING CAPACITY SHALL BE VERIFIED BY A GEOTECHNICAL ENGINEER LICENSED IN THE STATE OF ARKANSAS.
- CONTRACTOR SHALL COORDINATE OVER EXCAVATION AND ADDITIONAL BACKFILLING AS REQUIRED TO REMOVE
- UNSUITABLE MATERIALS OR AS INDICATED BY THE GEOTECHNICAL ENGINEER. ALL AREAS AT-GRADE SHALL BE CUT A MINIMUM OF 12 INCHES AND BACKFILLED PRIOR TO POURING NEW
- FOUNDATIONS.
- BACKFILLING SHALL BE PERFORMED IN 8-INCH MAXIMUM LIFTS COMPACTED TO AT LEAST 95% OF STANDARD PROCTOR MAXIMUM DRY DENSITY PER ASTM D698.
- BACKFILL MATERIAL SHALL BE APPROVED BY THE OWNER'S REPRESENTATIVE. FILL SOIL SHALL NOT CONTAIN ORGANIC MATERIAL, ROCKS OR LUMPS LARGER THAN 6 INCHES, OR OTHER DELETERIOUS MATERIALS. THE AMOUNT OF ROCKS LARGER THAN 2.5IN SHALL NOT EXCEED 15%. FILL MATERIAL IS EXPECTED TO HAVE A PLASTICITY INDEX LESS THAN 30, LIQUID LIMIT LESS THAN 50, AND A DENSITY OF AT LEAST 90 PCF
- BACKFILL COMPACTION SHALL BE PERFORMED WITH MOISTURE CONTENTS WITHIN 3% OF OPTIMUM. WET SOILS SHALL BE SUBSURFACE PUMPED AND STABILIZED BY METHODS APPROVED BY THE OWNER'S REPRESENTATIVE OR REMOVED AND REPLACED WITH APPROPRIATE BACKFILLING METHODS
- FOOTING ELEVATIONS SHOWN IN THESE DRAWINGS ARE FOR BIDDING PURPOSES

CONCRETE AND REINFORCING:

- ALL CONCRETE AND REINFORCEMENT SHALL CONFORM TO THE LATEST APPLICABLE ACI CODES.
- ALL REINFORCING BARS SHALL BE A-615 GRADE 60 STEEL
- REINFORCEMENT BAR HOOKS SHALL BE FORMED AS ACI "STANDARD HOOKS" UNLESS NOTED OTHERWISE.
- LAP ALL REINFORCING BARS 48 BAR DIAMETERS MIN
- REINFORCEMENT STEEL SHALL NOT BE WELDED OR TORCHED
- REINFORCEMENT SHALL HAVE MINIMUM CONCRETE COVER OF 2 INCHES TYPICALLY AND 3 INCHES MINIMUM WHEN CAST AGAINST EARTH, UNLESS NOTED OTHERWISE.
- WELDED WIRE REINFORCEMENT SHALL BE FLAT SHEETS THAT CONFORM TO ASTM A1064 AND SHALL BE LAPPED 9 INCHES MINIMUM UNLESS NOTED OTHERWISE
- ALL CONCRETE SHALL HAVE A COMPRESSIVE STRENGTH AT 28 DAYS (F'C) OF 3500 PSI.
- CONCRETE MIX DESIGN SHALL BE SUBMITTED TO THE STRUCTURAL ENGINEER OF RECORD PRIOR TO THE START OF
- 10. MIX DESIGN SHALL NOT CONTAIN CALCIUM CHLORIDE, THIOCYANATES, ADMIXTURES WITH MORE THAN 0.5% CALCIUM CHLORIDE. OR OTHER DELETERIOUS CHEMICALS
- 11. PROVIDE CORNER BARS AT INTERSECTIONS OF ALL CONCRETE MEMBERS. MATCH SIZE AND SPACING OF REBAR IN **FOOTING**
- 12. REINFORCEMENT SHALL BE SUPPORTED AT 4'-0" MAXIMUM INTERVALS AND IN ACCORDANCE WITH THE CRSI MANUAL OF STANDARD PRACTICE. SUPPORTS SHALL BE IN ACCORDANCE WITH THE MOST RECENT ACI MANUAL OF STANDARD PRACTICE FOR DETAILING REINFORCED CONCRETE STRUCTURES.
- CONCRETE SHALL BE THOROUGHLY COMPACTED VIA MECHANICAL VIBRATION DURING AND AFTER PLACEMENT
- SLAB EDGE TOLERANCE SHALL BE ±1/2" U.N.O.
- 15. PLACE AND CURE CONCRETE IN ACCORDANCE TO ACI 305R AND 306R FOR HIGH AND LOW AIR TEMPERATURES AT PLACEMENT. RESPECTIVELY.
- CONCRETE SLABS SHALL BE CURED FOR SEVEN DAYS AS OUTLINED BY ACI 308.
- 17. THE CONCRETE FOUNDATION HAS BEEN DESIGNED IN ACCORDANCE WITH ACT 1100, 1991 OF THE STATE OF ARKANSAS.
- EPOXY ANCHORS SHALL BE INSTALLED WITH HILTI HIT-RE 500 V3 OR EQUIVALENT EPOXY AS APPROVED BY THE STRUCTURAL ENGINEER OF RECORD. ALL ANCHORS SHALL BE INSTALLED IN ACCORDANCE WITH THE MANUFACTURER'S GUIDELINES.

WOOD DESIGN:

- WOOD MEMBER DESIGN IS BASED ON AWC NDS-2012.
- ALL WOOD FRAMING SHALL BE SOUTHERN PINE GR. NO. 2 OR STRONGER U.N.O. CONTRACTOR SHALL BE RESPONSIBLE FOR DESIGN OF ALL ROOF TRUSSES.
- ALL WOOD CONNECTIONS SHALL CONFORM TO IBC 2012 TABLE 2304.9.1 U.N.O.
- ALL WOOD MEMBERS IN CONTACT WITH CONCRETE SHALL BE PRESSURE TREATED.
- ALL CONNECTORS IN CONTACT PRESSURE TREATED LUMBER SHALL BE HOT-DIP GALVANIZED OR STAINLESS STEEL. DO NOT PLACE GALVANIZED CONNECTORS IN CONTACT WITH STAINLESS STEEL CONNECTORS.
- ALL SHEATHED WALLS SHALL HAVE 2x BLOCKING AT ALL PANEL EDGES AND AT 4'-0" O.C. MAX. NON-LOAD BEARING
- WALLS SHALL HAVE 2x BLOCKING AT MID-HEIGHT.
- ALL LOAD BEARING WALLS AND/OR SHEAR WALLS SHALL HAVE MINIMUM TWO 2x STUDS AT EACH SIDE OF ALL WALL OPENINGS.

DESIGN SUMMARY:

THE STRUCTURAL DESIGN OF THE BUILDING CONSISTS OF WOOD FRAMING WITH WOOD SHEATHED SHEAR WALLS. THE ROOF SYSTEM SHALL BE COMPRISED OF WOOD TRUSSES DESIGNED BY OTHERS. THE BUILDING SHALL BE SUPPORTED BY SHALLOW FOUNDATIONS DESIGNED BASED ON AN ALLOWABLE BEARING CAPACITY OF 2000 PSF

DESIGN CODE: 2012 ARKANSAS FIRE PREVENTION CODE (BASED ON THE 2012 INTERNATIONAL BUILDING CODE)

ALSO REFERENCES ASCE 7-10 **RISK CATEGORY: II**

GRAVITY LOADS

DEAD LOAD = MATERIAL WEIGHT

LIVE LOADS

TYPICAL ROOF LIVE LOAD (NON-REDUCIBLE) = 20 PSF

SNOW LOADS

GROUND SNOW LOAD FLAT-ROOF SNOW LOAD SNOW EXPOSURE FACTOR CE = 1.0IS SNOW IMPORTANCE FACTOR THERMAL FACTOR

1 FOUNDATION PLAN

1/4" = 1'-0"

LATERAL LOADS WIND:

ULTIMATE WIND SPEED NOMINAL WIND SPEED **IMPORTANCE FACTOR EXPOSURE CATEGORY**

115 MPH

89 MPH

1.0

1.0

1.450

0.507

1.450

0.760

0.967

0.507

LIGHT-FRAME (WOOD)

WALLS SHEATHED

WITH WOOD

Vasd =

SM1 =

SDS =

SD1 =

SEISMIC: SOIL SITE CLASS (ASSUMED)


IMPORTANCE FACTOR MAPPED SPECTRAL RESPONSE **ACCELERATION PARAMETERS** MCE/R SPECTRAL RESPONSE **ACCELERATION PARAMETERS DESIGN SPECTRAL RESPONSE**

ACCELERATION PARAMETERS SEISMIC DESIGN CATEGORY SEISMIC FORCE RESISTING SYSTEM

ENGINEERING ON DENOMESSIONAL OF ENGINEER No. 12969

1/3/2021

STRUCTURAL PANELS 10 PSF RESPONSE MODIFICATION COEFFICIENT 7 PSF R = 7.0SEISMIC RESPONSE COEFFICITNE CS = 0.138DESIGN BASE SHEAR V = 0.138W= 1.0 ANALYSIS PROCEDURE **EQUIVALENT LATERAL** FORCE PROCEDURE

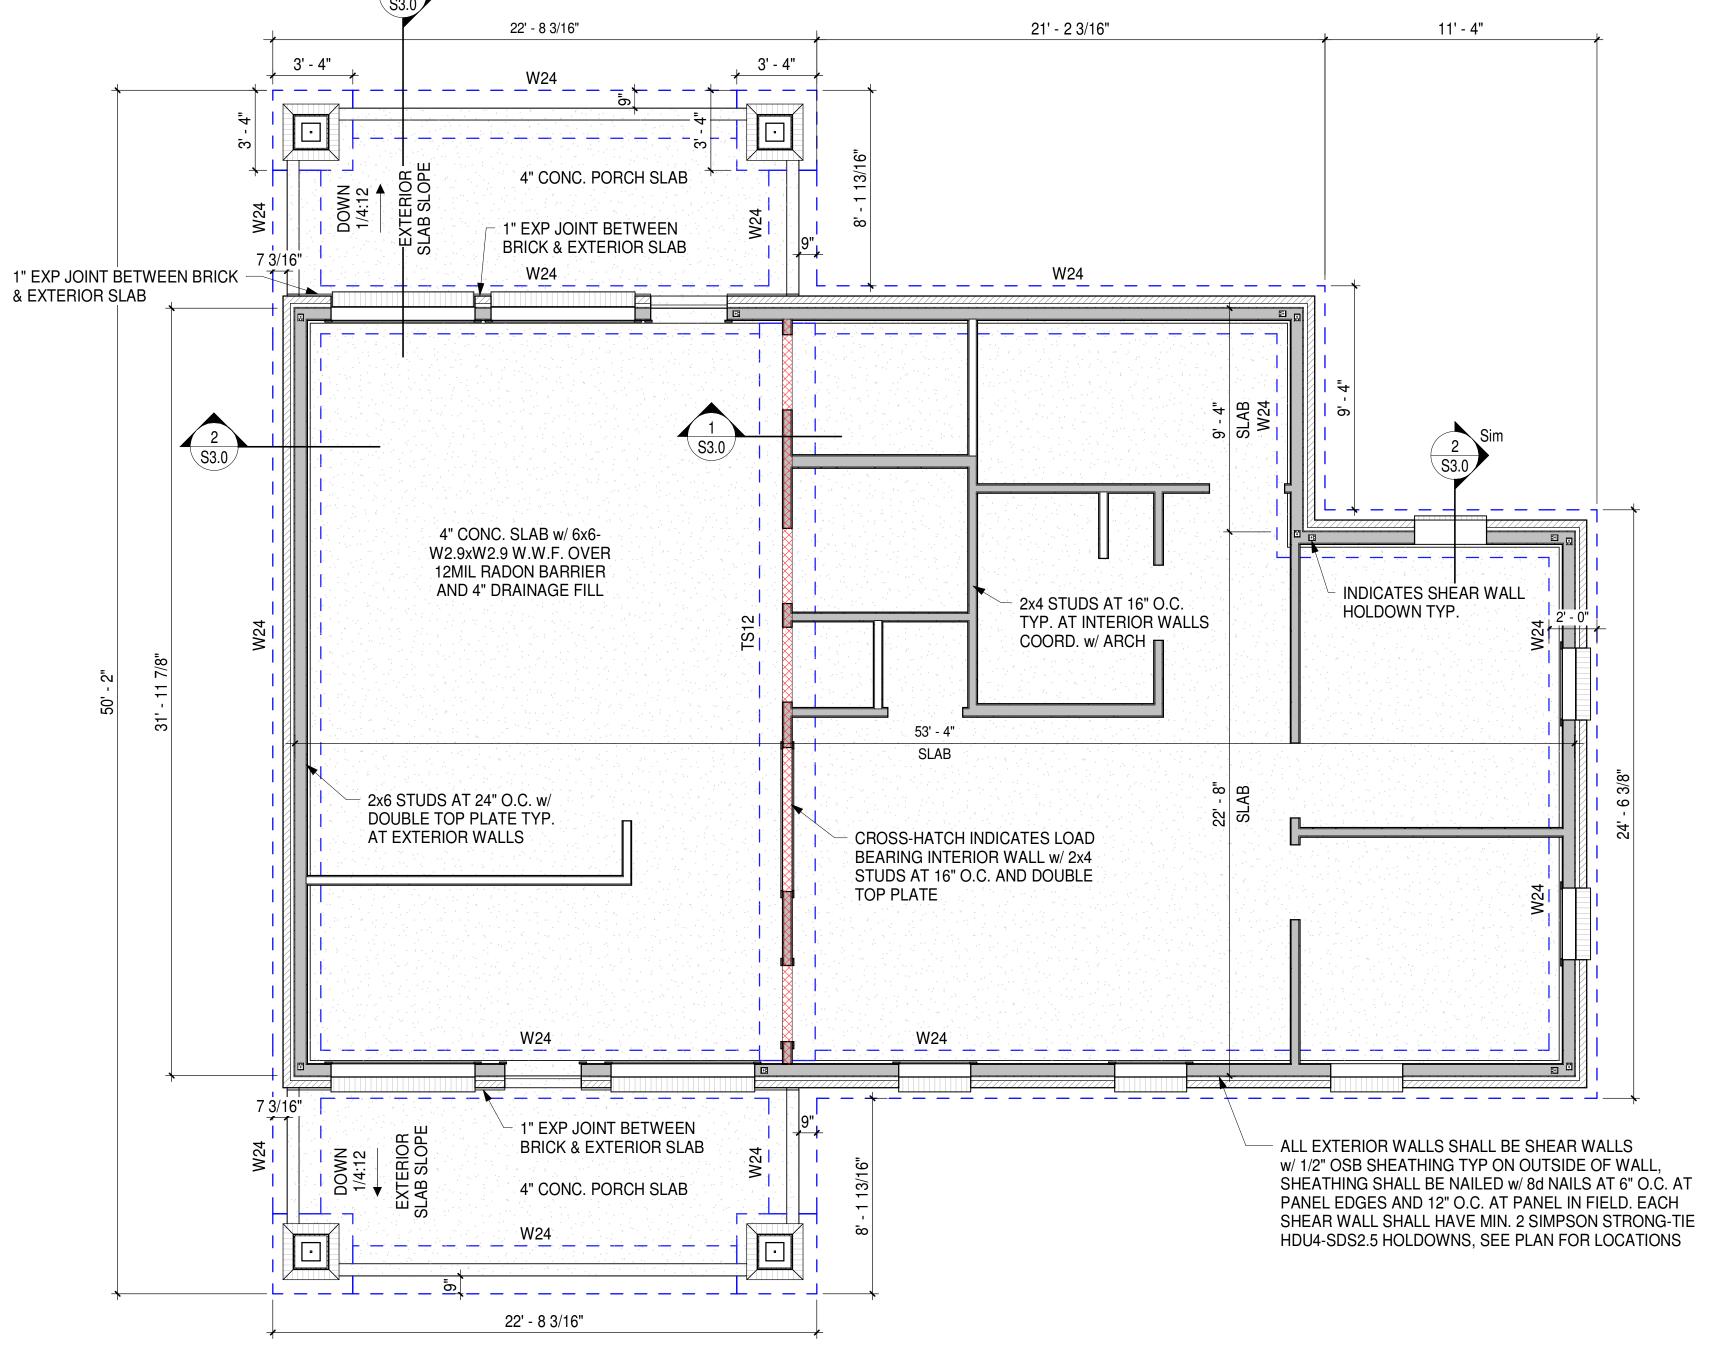

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MWO

COOPER MIXON A R C H I T E C T S 505 union street, 2nd flr jonesboro, ar 72401 phone 870.336.0536 www.coopermixon.com

CONSTRUCTION

DOCUMENTS PROJECT NO.

2029

VETERANS' VILLAGE **COMMUNITY BLDG** DATE

PROJECT NAME

2021-01-03

CONTENTS **STRUCTURAL** NOTES & FOUNDATION PLAN




TRUSS DESIGN LOADS: DL = 12PSF + SELF WEIGHT LL = 20PSF (NON-REDUCIBLE)



BLDG

COMMUNIT

VETERANS' VILL

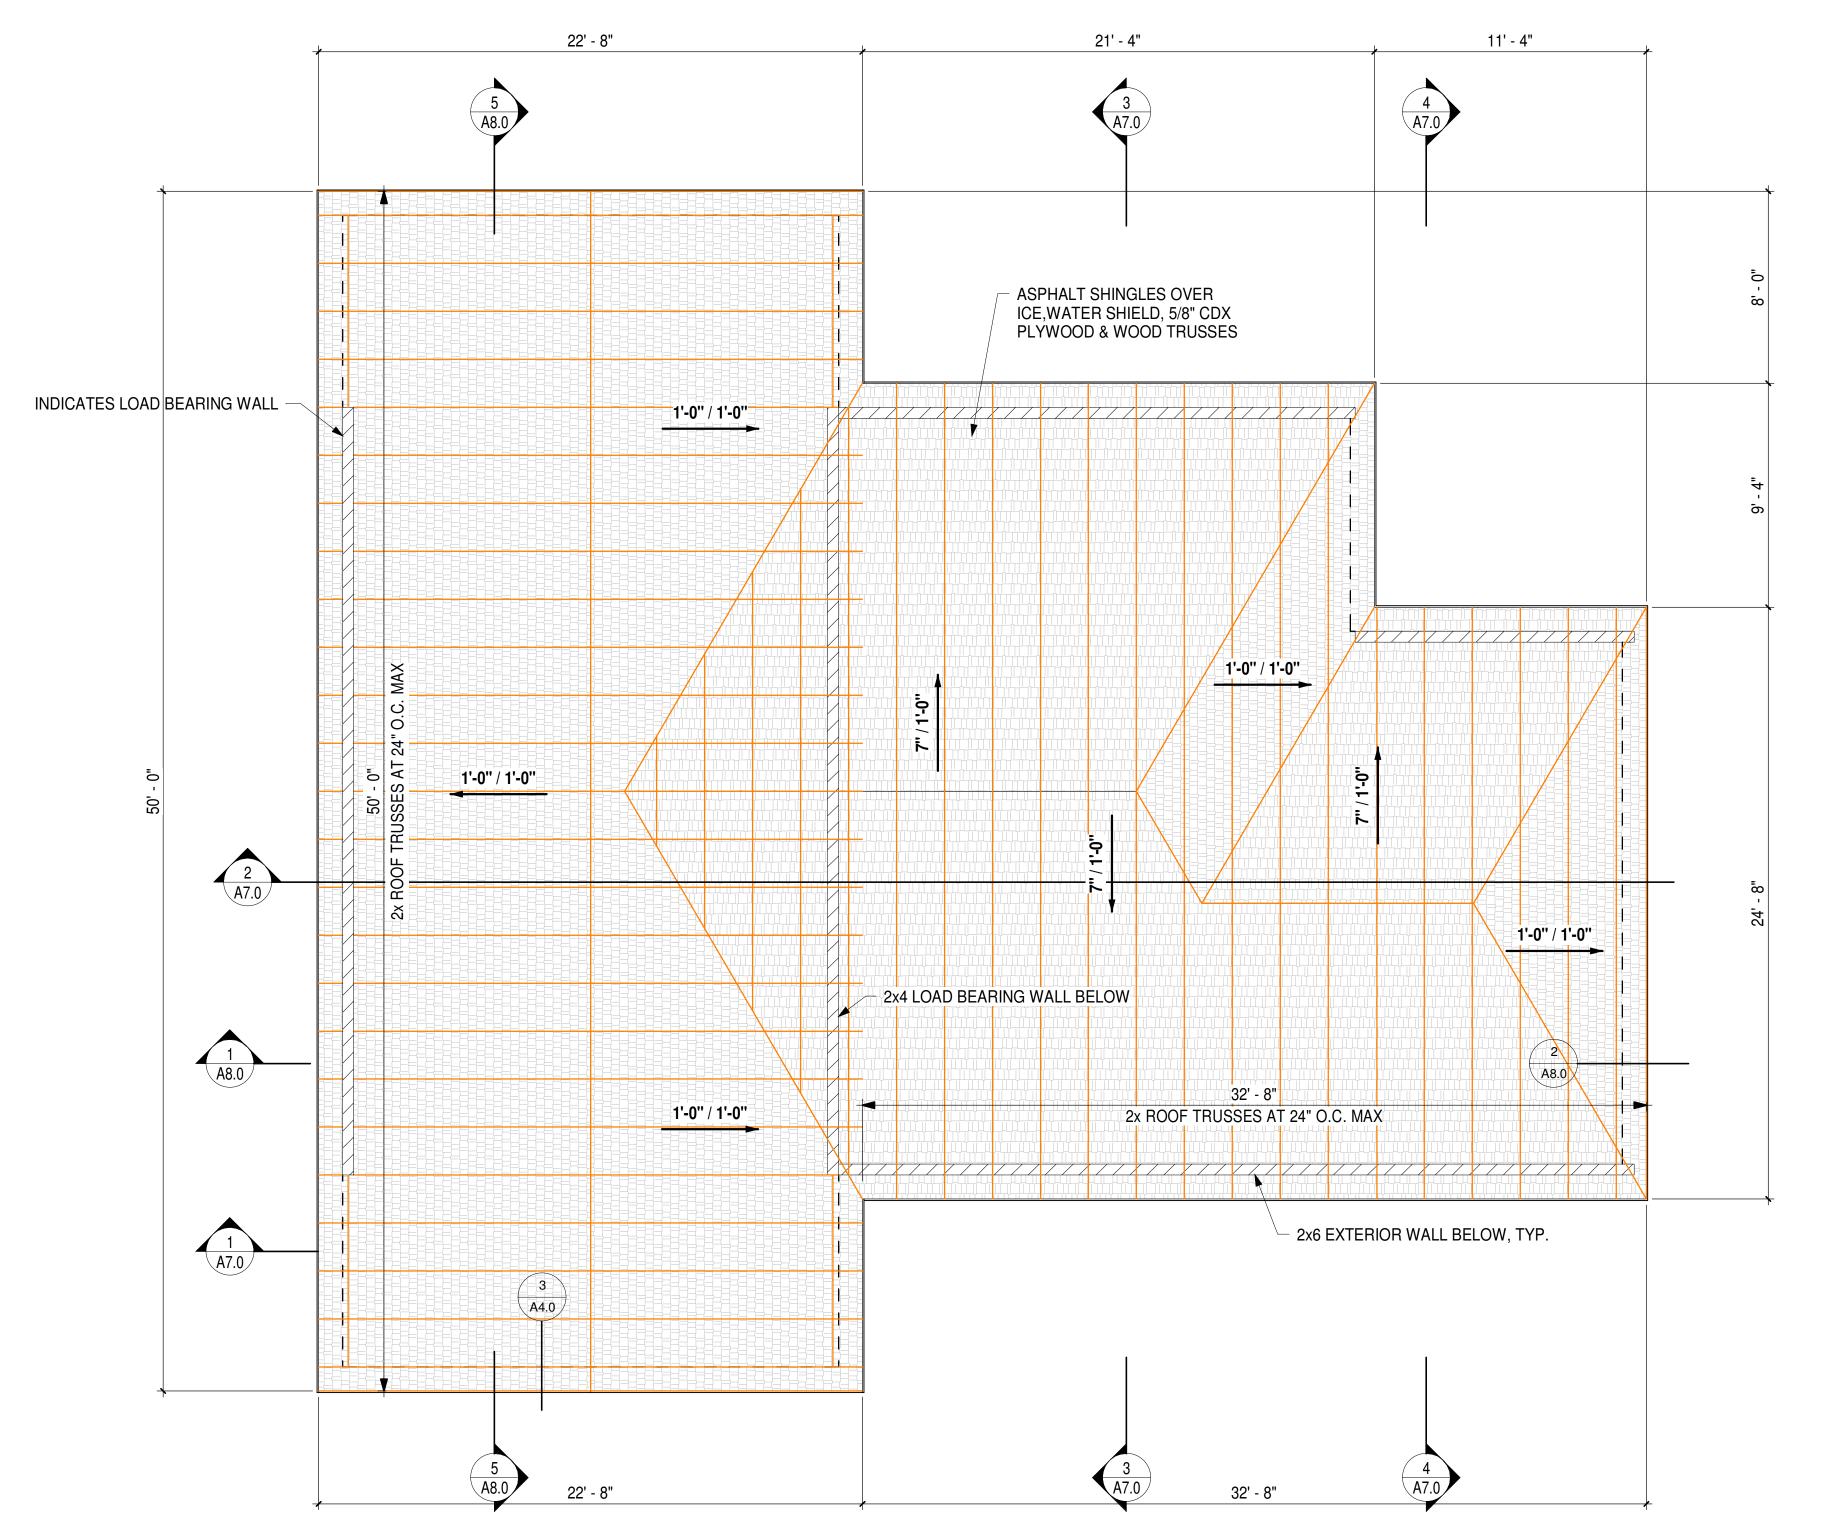



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phone 870.336.0536 www.coopermixon.com

CONSTRUCTION DOCUMENTS

PROJECT NO.

PROJECT NAME


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VILLAGE
COMMUNITY BLDG
DATE


2021-01-03

CONTENTS
ROOF FRAMING
PLAN

SHEET NUMBER

S2.0

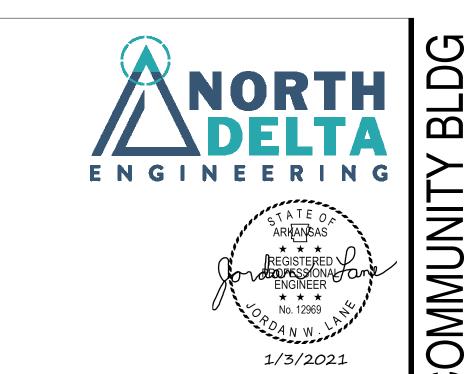


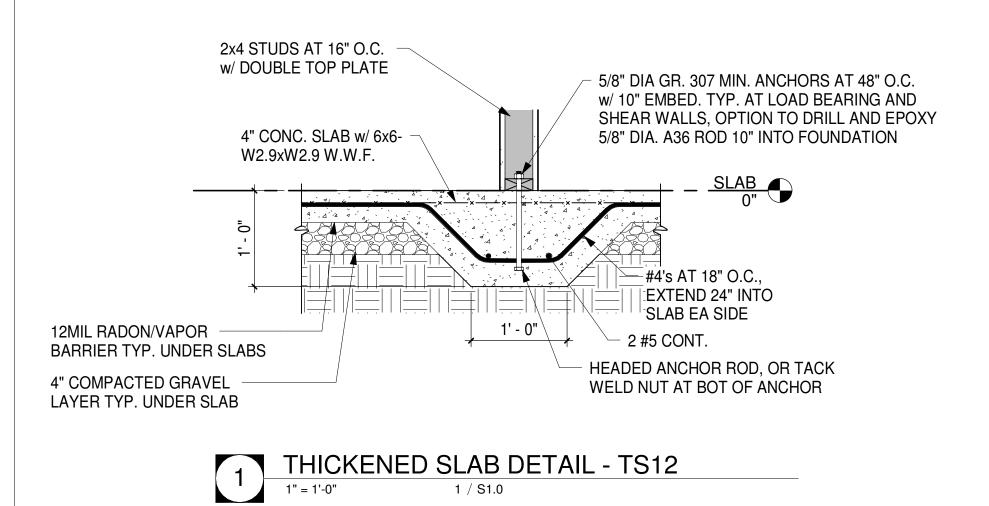

2x6 AT 24" O.C. EXTERIOR STUD WALLS, PROVIDE DOUBLE 2x6 AT HOLDOWNS w/ ARCH, PROVIDE BRICK TIES AT 16" O.C. EA WAY SIMPSON STRONG-TIE HDU4-SDS2.5 HOLDOWN OR EQUIV. AT SHEAR WALL ENDS, COORD. FASTENER SIZES w/ MANUFACTURER SPEC., EMBED ANCHOR 12" MIN. COORD. EXTERIOR GRADE 8" CMU STEM WALL, GROUTED SOLID, w/ TOP L-BLOCK A307 ANCHOR w/ 12" MIN. EMBED, __T.<u>O. FOUNDATION</u> _-1' - 4" PROVIDE HEADED ANCHOR OR -TACK WELD NUT AT BOT, OPTION TO DRILL AND EPOXY A36 - #4 L BARS AT 24" O.C. ANCHOR ROD 12" INTO BLOCK WALL, COORD. ANCHOR DIA w/ HOLDOWN SPEC. 3 #5's CONT. #4's AT 18" O.C. 2' - 0"

FOOTING SECTION AT EXTERIOR WALL

COORD. BRICK VENEER

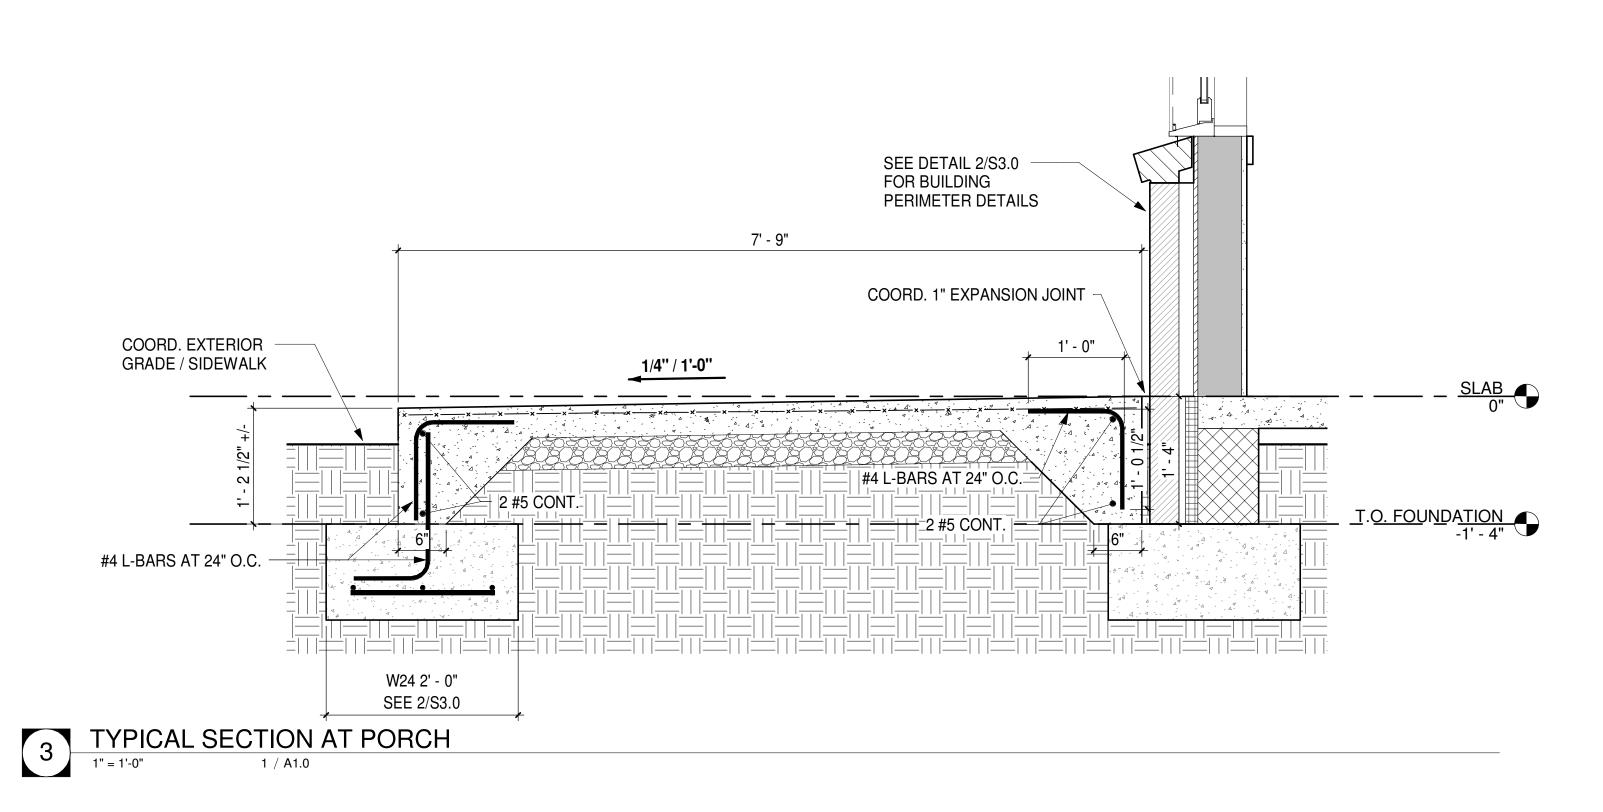

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CONSTRUCTION **DOCUMENTS**

PROJECT NO.

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VETERANS

PROJECT NAME

VETERANS' VILLAGE COMMUNITY BLDG DATE

2021-01-03

CONTENTS STRUCTURAL DETAILS